


City Plan Set No. 2022022

electronic copies.

# EAST WRF INFLUENT PUMP STATION REHABILITATION PROJECT

COLLABORATE. INNOVATE. CREATE.

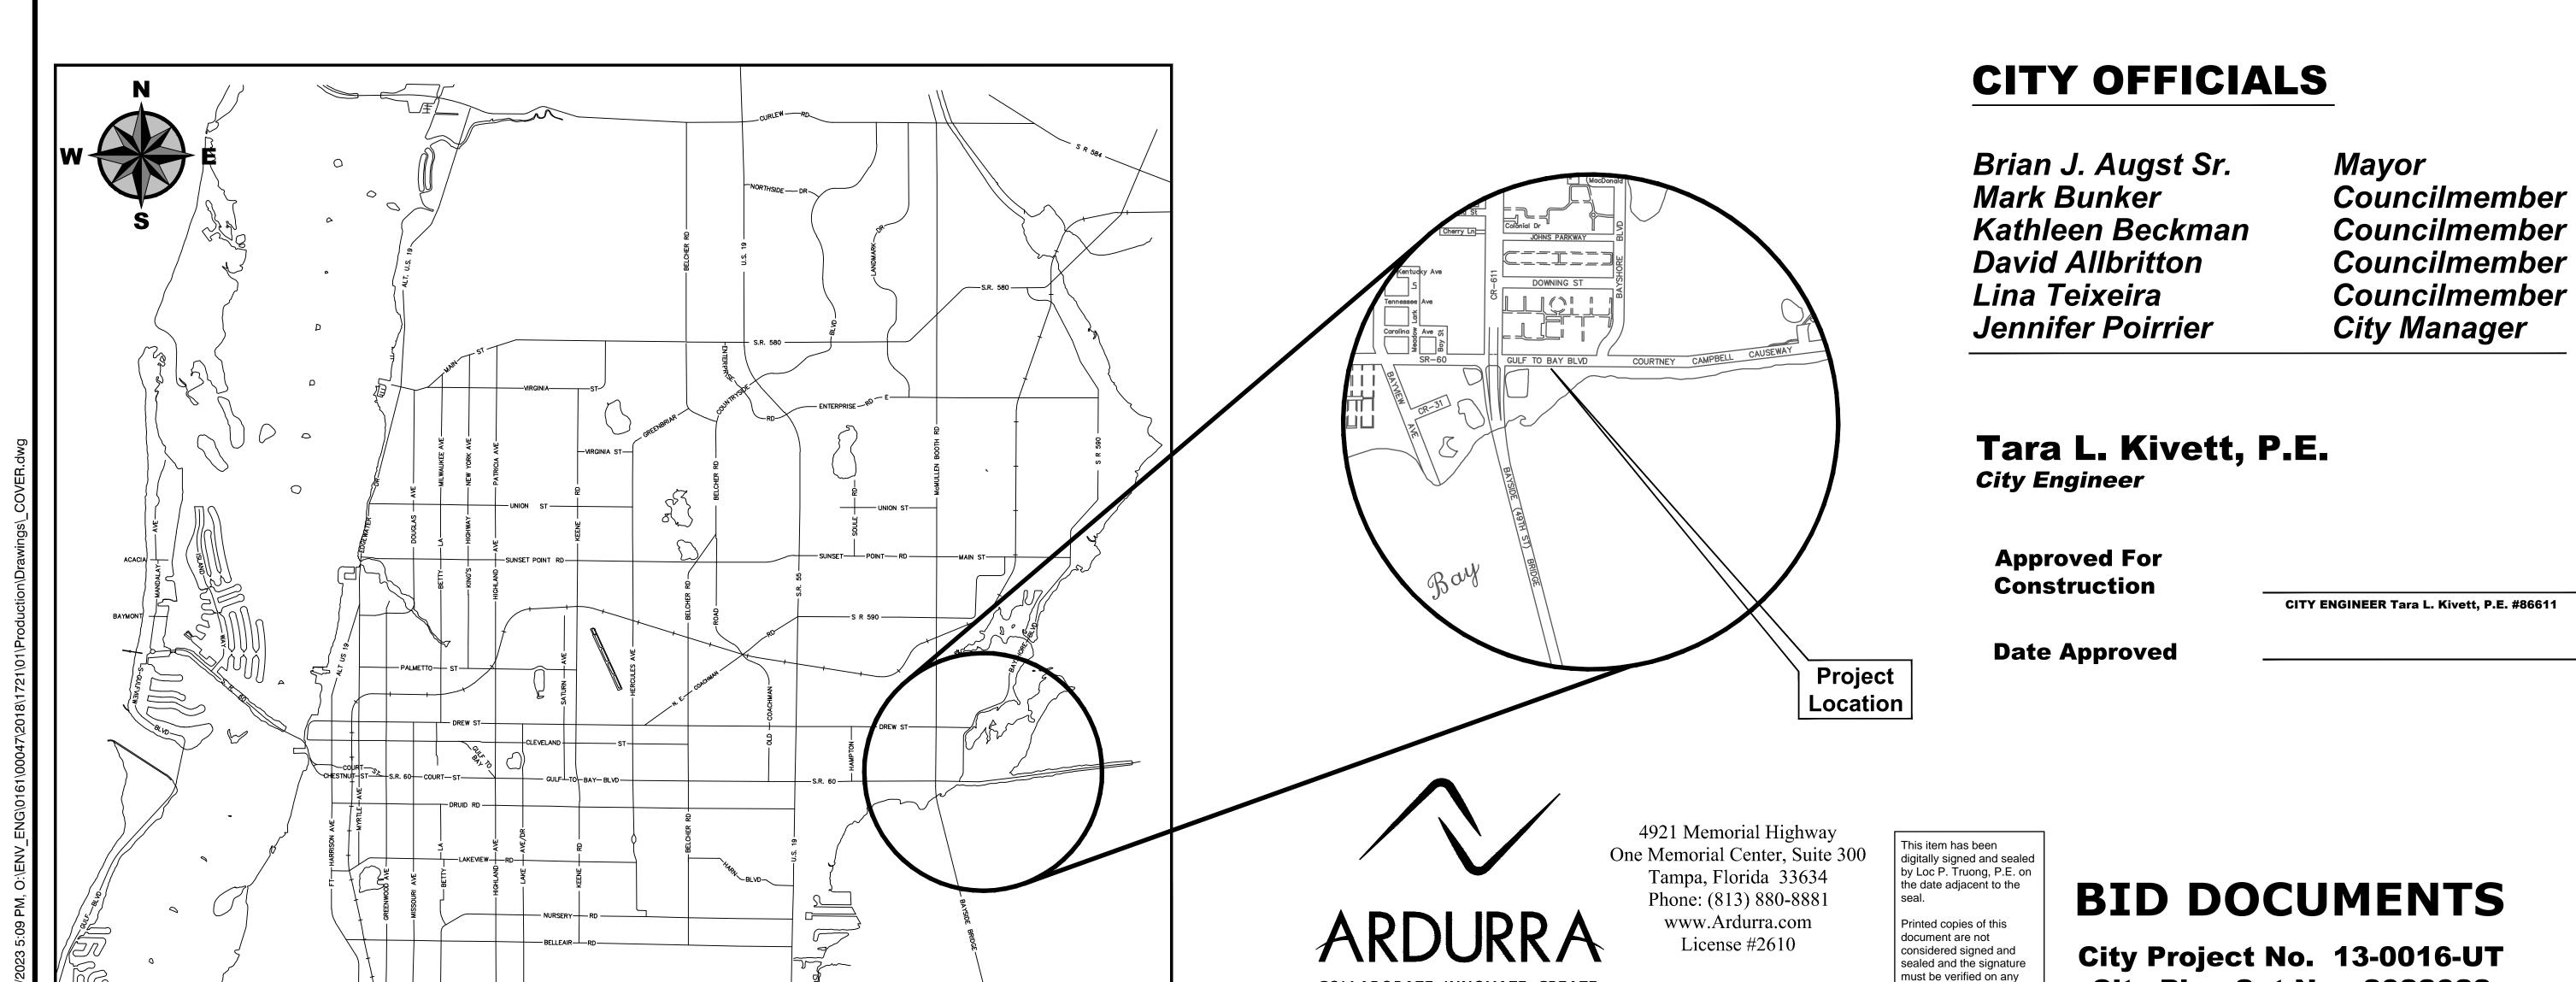

# **ABBREVIATIONS**

ACT	ACTIVATED	RED	REDUCER
AL	ALUMINUM	RED ELL	REDUCER ELBOW
ALT	ALTERNATE	REQ'D	REQUIRED
APP	APPARENT	RNG	RANGE
ARV	AIR RELEASE VALVE	R/W	RIGHT OF WAY
AVE	AVENUE	S	SOUTH
BFV	BUTTERFLY VALVE	SANT/SAN	SANITARY
BLDG	BUILDING	SCH	SCHEDULE
BLVD	BOULEVARD	SEW	RAW SEWAGE
CIPP	CURED-IN-PLACE-PIPE	SHT	SHEET
CLR	CLEARANCE/CLEAR	SOD	SODIUM
CO	CLEAN OUT	SS	STAINLESS STEEL
CONC	CONCRETE	STD	STANDARD
CP	CONCRETE PIPE	TBM	TEMPORARY BENCHMARK
CV	CHECK VALVE	TEMP	TEMPORARY DENOMINARY
DECHLOR	DECHLORINATION	THK	
DEPT	DEPARTMENT	TOB	THICK TOP OF BANK
DEW	DRAIN EFFLUENT WATER		
DI	DUCTILE IRON	TOS	TOE OF SLOPE
DIA	DIAMETER	TWN	TOWNSHIP
DIM	DIMENSION	TYP	TYPICAL
DISCH	DISCHARGE	UP W	UTILITY POLE
DIP	DUCTILE IRON PIPE	W	WEST
DR	DRIVE	W/	WITH
DWG	DRAWING	WAS	WASTE ACTIVATED SLUDGE
F	FAST	WM	WATER MAIN

EAST

ECCENTRIC

EFFLUENT

ELEVATION

EMERGENCY

EXPANSION

FLOOR DRAIN

FOUND IRON ROD

FIBER OPTIC CABLE

FIBRE REINFORCED PLASTIC

HIGH DENSITY POLYETHYLENE

EXISTING

FINISH

FLANGED

GALLON

GROUND

HIGH HOSE BIB

GALVANIZED

GENERATOR

GATE VALVE

HEADWALL

INFLUENT

MAGNETIC

MAXIMUM

MANHOLE

MINIMUM

NORTH

NUMBER

NOT TO SCALE

OFF CENTER

PRECAST

PLACE

PLACES

PLUG VALVE

PRESSURE

POLYVINYL CHLORIDE

POTABLE WATER

PRESSURE RELIEF VALVE

RETURN ACTIVATED SLUDGE

REINFORCED CONCRETE PIPE

PLAIN END

LANE

HYPO-CHLORITE

JURISDICTIONAL

INVERT ELEVATION

MECHANICAL JOINT

MOTOR CONTROL CENTER

PROGRAMMABLE LOGIC CONTROLLER

GUY WIRE POLE

FORCE MAIN

EAV EAV

ECC

EFFL

EFW

**EMERG** 

EL

ΕX

EXP

FCA

FDEP

FDOT

FIN

FIR

FL

FM

FOC

FRP

GAL

GALV

GEN

GRD

HDPE

HDWL

HYP

INFL

INV

MAG

MAX

MCC

МН

NO

OC

PΕ

PL

PLC

PLCS

PV

PVC

PRV

PW

RAS

RCP

RD

PRESS

NTS

MIN

GP

FD

ELECTRIC ACTUATED VALVE

ELECTRIC ACTUATED VALVE

FLANGED COUPLING ADAPTER

FLORIDA DEPARTMENT OF ENVIRONMENTAL PROTECTION

FLORIDA DEPARTMENT OF TRANSPORTATION

EFFLUENT WATER PIPE

# TREE LEGEND

	120€	=	12"	UNKNOWN TYPE
	1200	=	12"	CHERRY LAUREL
	12.	=	12"	WILLOW
	2.0	=	12"	HOLLY
	<b>⟨2.</b> ♥	=	12"	DEAD
	200	=	12"	TALLOW
	12·Q	=	12"	CHINABERRY
	1200	=	12"	OAK
	<b>₹</b>	=	12"	JACARANDA
	<i>\?</i> •∕	=	12"	MULBERRY
	1200	=	12"	PALM
	120€	=	12"	BAY
	<b>₹</b> •�	=	12"	MAGNOLIA
	<b>⟨&gt;</b> ◆	=	12"	MAGNOLIA CITRUS
	1200)	=	12"	PECAN
	<b>₹</b>	=	12"	EUCALYPTUS CAMPHOR
	120	=	12"	CAMPHOR
				SYCAMORE
	120€	=	12"	PINE
	\$,▲	=	12"	AUSTRALIAN PINE
				CEDAR
	<b>₹</b> •√	=	12"	ELM
	<b>?∙</b> ♥	=	12"	MAPLE
SHOWN	<b>∤</b> •◆	=	12"	MYRTLE PUNK
	72×€	=	12"	PUNK
	2.◀	=	12"	CYPRESS
	5.△	=	12"	EAR
SHOWN	المحود في ا	=	12"	EAR SWEET GUM BIRCH
	<b>₹</b>	=	12"	BIRCH
	<b>⟨~</b> (·)	=	12"	HICKORY
	<b>⟨~</b> �	=	12"	BANYON

TREE HAVING ONE TRUNK AT

BREAST HEIGHT, 12" IN DIA.

TRUNKS AT BREAST HEIGHT

REPRESENTS TREE CANOPY

REPRESENTS POTENTIAL

SECTION 00120

TREE TO BE REMOVED, SEE

TREE HAVING MULTIPLE


12", 13" AND 5" IN DIA.


LEGEND	
= RIGHT OF WAY LINE  = PROPERTY LINE  = JURISDICTIONAL LINE  = STAKED SILT FENCE  = TURBIDITY BARRIER  = EDGE OF PAVEMENT  = CHAIN—LINK FENCE  = SILT FENCE  = SILT FENCE  = EXISTING WATER MAIN  = EXISTING SEWER  = EXISTING PIPE (UNDER GROUND)  = EXISTING PIPE (ABOVE GROUND)	= NGS = NATIONAL GEODETIC SURVEY, SURVEY MARK  (IDENTIFICATION AS SHOWN)  = SCM = SET 4"X4" CONCRETE MONUMENT "PRM LB#2610"  = SIR = SET 1/2" IRON ROD & CAP LB#2610  = SND = SET NAIL & DISK LB#2610
—————————————————————————————————————	<pre>## ## ## = OVERHEAD LINE </pre>
CONC = CONCRETE  = CONCRETE MITERED END SECTION  = CONCRETE FLARED END SECTION	— TOE OF SLOPE  — TOP OF BANK  — SAN SPM = SANITARY SEWER PIPE, MANHOLE, CLEANOUT,
E = ELECTRIC BOX  EM = ELECTRIC METER  \( \triangle = \text{ELECTRIC TRANSFORMER} \)	VALVE & PAINT MARK IDENTIFYING PROBAE LOCATION OF PIPE  TEL
FDC	GAS GPM = GAS LINE WITH GAS VALVE, GAS METER & PAINT MARK IDENTIFYING PROBABLE LOCATION OF UTILITY
FH - = FIRE HYDRANT  GRATE INLET	
GP,O' = GUY POLE  GP,O' = GUY POLE  GP,O' = GUY POLE	ELC ELC = ELECTRIC UTILITY LINE WITH ELECTRIC UTILITY  MANHOLE & PAINT MARK IDENTIFYING  PROBABLE LOCATION OF UTILITY  DCO
IV = IRRIGATION CONTROL VALVE  LP  = LIGHT POLE  = MAIL BOX  = METER POLE  ■ SIGN	TOP OF CURB FLOWLINE OF CURB 7.90 EDGE OF PAVEMENT 7.91 TOP OF CURB 8.22 EDGE OF PAVEMENT 7.91  TOP OF CURB 8.22 EDGE OF PAVEMENT 7.91  TOP OF CURB 8.22 EDGE OF PAVEMENT 7.91
TUB T = TELEPHONE UTILITY BOX   TUB T = TELEPHONE UTILITY BOX  TUB T = TRAFFIC SIGNAL POLE  TUB T = TRAFFIC SIGNAL UTILITY BOX	EDGE OF PAVEMENT $7.91$ GROUND ELEVATIONS $6.3_{x}$ $=$ TYPICAL GROUND SPOT ELEVATIONS
= UNDERGROUND CABLE TELEVISION MARKER  UGG → = UNDERGROUND GAS LINE MARKER  = UNDERGROUND TELEPHONE CABLE ROUTE SIGN  FOM ∅ = UNDERGROUND FIBER OPTIC MARKER	CONCRETE CURB INLETS  PROPOSED
FOM () = UNDERGROUND FIBER OPTIC MARKER  () = UTILITY MANHOLE	= PROPOSED PIPE = TO BE DEMOLISHED & REMOVED

# GROUND ELEVATIONS $6.3_x$ = TYPICAL GROUND SPOT ELEVATIONS CONCRETE CURB INLETS

= PROPOSED PIPE = TO BE DEMOLISHED & REMOVED = CONCRETE = CONSTRUCTION STAGING AREA

# SECTION DESIGNATION

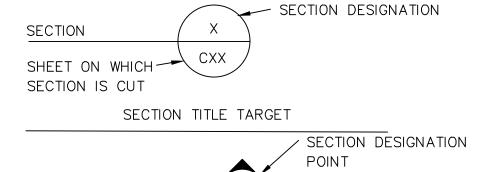

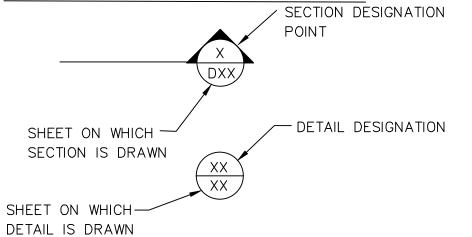

SECTION & DETAIL TARGET

**RECORD DRAWINGS** BID DOCUMENTS LPT 09/28/23 SURVEYED BY: DRAWN BY: REVIEWED BY: PROJECT ENGINEER **REVISION** 

CITY OF CLEARWATER, FLORIDA **ENGINEERING DEPARTMENT** 100 S. MYRTLE AVE. CLEARWATER, FL 33756

UP = UTILITY POLE

ULP 🙋 = UTILITY & LIGHT POLE

WBO = WATER BLOW OFF VALVE

• = FIP = FOUND IRON PIPE

• = FIR = FOUND IRON ROD

= FND = FOUND NAIL & DISK

₩ = WATER BACKFLOW PREVENTER

= TBM = TEMPORARY BENCHMARK

 $\otimes$  = X-CUT = FOUND OR SET X-CUT (AS SHOWN)

(SIZE AND IDENTIFICATION AS SHOWN)

(SIZE AND IDENTIFICATION AS SHOWN)

(SIZE AND IDENTIFICATION AS SHOWN)

(TYPE AND IDENTIFICATION AS SHOWN)

= FCM = FOUND CONCRETE MONUMENT

UHH o = UTILITY HANDHOLE

HA# - HAND AUGER BORING

G# - SPT BORING



EAST WRF INFLUENT PUMP STATION REHABILITATION PROJECT ABBREVIATIONS, SYMBOLS & LEGENDS

# **SHEET INDEX**

NU	EET IMBER NERAL	SHEET TITLE
1.	G0.00	COVER
2.	G1.00	ABBREVIATIONS, SYMBOLS & LEGENDS
3.	G1.00 G1.01	SURVEYOR'S REPORT & GENERAL NOTES
S. CIV		SURVETUR'S REPORT & GENERAL NOTES
4.	C1.00	OVERALL PROJECT SITE PLAN
5.	C1.01	KEY MAP
6.	C1.02	CIVIL SITE DEMOLITION
7.	C1.03	INFLUENT METER ASSEMBLY DEMOLITION
8.	C1.04	INFLUENT PUMP STATION DEMOLITION
9.	C1.05	SLUDGE HANDLING BUILDING BLOWER ROOM DEMOLITION
LO.	C2.00	PROPOSED SITE PLAN AND YARD PIPING
1.	C2.01	BYPASS PUMPING SITE PLAN (1) AND BYPASS MANHOLE
L2.	C2.02	BYPASS PUMPING SITE PLAN (2)
L3.	C2.03	BY-PASS PUMPING SECTION PLAN
	ΓAIL	
L <b>4</b> .	C3.00	CIVIL DETAILS (1)
l <b>5</b> .	C3.01	CIVIL DETAILS (2)
ME	CHANICAL	• ,
L <b>6</b> .	M1.01	PROPOSED INFLUENT ASSEMBLY
L <b>7</b> .	M1.02	PROPOSED INFLUENT PUMP STATION (1)
L8.	M1.03	M1.03 - PROPOSED INFLUENT PUMP STATION (2)
L <b>9</b> .	M1.04	PROPOSED LARGE BUBBLE MIXING SYSTEM LAYOUT SCHEMATIC
20.	M1.05	PROPOSED SLUDGE HANDLING BUILDING BLOWER ROOM IMPROVEMENTS (1)
21.	M1.06	PROPOSED SLUDGE HANDLING BUILDING BLOWER ROOM IMPROVEMENTS (2)
22.	M3.00	MECHANICAL DETAILS (1)
23.	M3.01	MECHANICAL DETAILS (2)
24.	M3.02	MECHANICAL DETAILS (3)
STR	RUCTURAL	
25.	S0.00	STRUCTURAL GENERAL NOTES
26.	S1.01	HEADWORKS INFLUENT STRUCTURE PIPE SUPPORTS
27.	S1.02	HEADWORKS INFLUENT STRUCTURE PIPE SUPPORTS
28.	S1.03	BYPASS MANHOLE PLAN AND SECTION
ELE	CTRICAL	
29.	E1.00	ELECTRICAL SYMBOL, LEGEND & NOTES
30.	E2.00	ELECTRICAL SITE PLAN
31.	E3.00	INFLUENT PUMP STATION ELECTRICAL PLANS
32.	E3.01	ELECTRICAL PLAN - SLUDGE HANDLING BLDG.
33.	E4.00	PARTIAL POWER ONE-LINE DIAGRAM
34.	E4.01	POWER ONE-LINE DIAGRAM (MCC-2000)
35.	E5.00	ELECTRICAL DETAILS
36.	E6.00	PARTIAL INFLUENT ELECTRICAL LAYOUT
INS	TRUMENTA	TION
37.	11.00	INSTRUMENTATION LEGENDS, SYMBOLS & ABBREVIATIONS I
88.	11.01	INSTRUMENTATION LEGENDS, SYMBOLS & ABBREVIATIONS I
89.	11.02	INFLUENT PUMP STATION P&ID
10.	11.03	MISCELLANEOUS INSTRUMENTATION DETAILS

4921 Memorial Highway One Memorial Center, Suite 300 Tampa, Florida 33634 Phone: (813) 880-8881 www.Ardurra.com License #2610

wg NAME: _General-100.dwg	FIELD BOOK:	SURVEYED BY:	SCALE: VERT.	N/A	4
ONTRACT NO.:	DATE DRAWN: 9/28/2023	DRAWN BY:	HORIZ.	AS	SHOWN
в NO.: 2018-1721-01	DESIGNED BY:	CHECKED BY:	SHEET NO.:	OF	40
APPROVED FOR CONSTRUCTION					


**COLLABORATE. INNOVATE. CREATE.** 

DATE

- 1. TYPE OF SURVEY: TOPOGRAPHIC AND SPECIFIC PURPOSE SURVEY PER THE STANDARDS OF PRACTICE AS SET FORTH IN FLORIDA ADMINISTRATIVE CODE CHAPTER 5J-17.050, 5J-17.051 AND 5J-17.052, PURSUANT TO CHAPTER 472 OF THE FLORIDA STATUTES. THE INTENT OF THIS TOPOGRAPHIC SURVEY IS TO SHOW THE SPATIAL RELATIONSHIP OF EXISTING VISIBLE ABOVE GROUND FEATURES AND TREES OF A SPECIFIED SIZE TO THE PROPERTY AND RIGHT-OF-WAY LINE TO AN ESTABLISHED VERTICAL DATUM WITHIN A CLIENT SPECIFIED PROJECT AREA. THE SPECIFIC INTENT OF THE SPECIFIC PURPOSE PORTION OF THE SURVEY IS TO PROVIDE THE RELATIONSHIP OF RIGHT-OF-WAY LINES DEVELOPED FROM RECORDED DOCUMENTS (AS SHOWN ON THE SURVEY) TO EXISTING FOUND MONUMENTS.
- 2. THIS SURVEY WAS PREPARED WITHOUT THE BENEFIT OF A TITLE INSURANCE COMMITMENT.
- 3. NO INSTRUMENTS OF RECORD REFLECTING EASEMENTS, RIGHTS-OF-WAY, AND/OR OWNERSHIP WERE FURNISHED TO OR PURSUED BY THE UNDERSIGNED OTHER THAN THOSE SHOWN HEREON. EASEMENTS OR RESTRICTIONS OF RECORD OTHER THAN THOSE SHOWN HEREON MAY EXIST.
- 4. THE ACCURACY STANDARD USED FOR THIS SURVEY, AS CLASSIFIED IN THE STANDARDS OF PRACTICE (5J-17 FLORIDA ADMINISTRATIVE CODE) IS "COMMERCIAL/HIGH RISK". CONTROL POSITIONS WERE DERIVED BY GLOBAL POSITIONING SYSTEM (GPS) OBSERVATIONS UTILIZING A REAL TIME TECHNOLOGY SOLUTION AND IS THE PRODUCT OF REDUNDANT OBSERVATION SESSIONS CONSISTING OF AT LEAST 60 EPOCHS EACH. THE MAXIMUM POSITIONAL UNCERTAINTY OF THE PHYSICAL CONTROL POINTS IS COMPUTED TO BE 0.050 FEET USING THE ALGEBRAIC SUM MEAN OF THE PROCESSED POSITIONS.
- 5. GRID BEARINGS SHOWN HEREON ARE FIELD MEASURED UNLESS OTHERWISE NOTED AND ARE BASED ON THE FLORIDA STATE PLANE COORDINATE SYSTEM, WEST ZONE, NORTH AMERICAN DATUM 1983/1999 ADJUSTMENT (NAD 83/99) WITH LOCALIZATION TIES TO CONTROL MONUMENT, CITY OF CLEARWATER (COC) E-17 AND THE FIELD POSITIONS OF FOUND CORNER MONUMENTS GENERATED FROM DEEDS AND ALIGNED TO MATCH THE COORDINATE VALUES REPORTED ON CERTIFIED CORNER RECORD NUMBERS 090349 AND 090350 AS PUBLISHED BY THE FLORIDA DEPARTMENT OF ENVIRONMENTAL PROTECTION. MORE SPECIFICALLY THE SURVEY BASELINE HAVING A GRID BEARING OF NORTH 83°15'46" EAST.
- 6. CONTROL ELEVATIONS FOR THIS SURVEY ARE DERIVED USING DIFFERENTIAL LEVELING TECHNIQUES. CLOSURE ACHIEVED IS 0.001 FEET ERROR IN A 0.315-MILE LOCALIZATION LENGTH WHICH EXCEEDS THE MINIMUM ACCURACY REQUIREMENT CALCULATED AT A MAXIMUM MIS-CLOSURE OF 0.0281 FEET.
- 7. CONTROL ELEVATIONS SHOWN HEREON ARE IN FEET AND ARE BASED ON THE NORTH AMERICAN VERTICAL DATUM 1988 ADJUSTMENT (NAVD 88). CONTROL MONUMENT UTILIZED FOR THIS SURVEY WAS (a) CITY OF CLEARWATER (COC), E-17, STAMPED E-17, ELEVATION 6.651.
- 8. NO EXCAVATION WAS PERFORMED TO VERIFY THE LOCATION OR EXISTENCE OF ANY UNDERGROUND IMPROVEMENTS, STRUCTURES, OR FOUNDATIONS. UNDERGROUND UTILITIES SHOWN HEREON ARE SHOWN PER ABOVE GROUND EVIDENCE AND/OR RECORD DRAWINGS OR MUNICIPAL ATLAS INFORMATION AND THE LOCATION OF ALL UNDERGROUND UTILITY LINES ARE APPROXIMATE ONLY. THIS DOCUMENT SHALL NOT BE RELIED UPON FOR EXCAVATION OR CRITICAL DESIGN FUNCTIONS WITHOUT FIELD VERIFICATION OF UNDERGROUND UTILITY LOCATIONS. UTILITIES OTHER THAN THOSE SHOWN HEREON MAY EXIST.
- 9. ADJOINING PROPERTY OWNERS SHOWN HEREON ARE BASED ON INFORMATION OBTAINED FROM THE COUNTY PROPERTY APPRAISER WEB SITE AND IS FOR INFORMATIONAL PURPOSES ONLY.
- 10. THIS REPORT IS INTENDED TO ACCOMPANY A DIGITAL DRAWING FILE NAMED EAST PLANT TOPO BASE.DWG. THE DRAWING IS INTENDED TO DISPLAY AT A SCALE OF 1"=10". THE ABBREVIATION AND SYMBOLS LEGEND IS CONTAINED WITHIN THE DIGITAL DRAWING FILE. THE REPORT AND THE DIGITAL DRAWING FILE ARE NOT FULL AND COMPLETE WITHOUT ONE AND THE OTHER.
- 11. DISTANCES SHOWN HEREON ARE IN U.S. SURVEY FEET.
- 12. USE OF THIS SURVEY FOR PURPOSES OTHER THAN WHICH IT WAS INTENDED, WITHOUT WRITTEN VERIFICATION, WILL BE AT THE USER'S SOLE RISK AND WITHOUT LIABILITY TO THE SURVEYOR. NOTHING HEREIN SHALL BE CONSTRUED TO GIVE ANY RIGHTS OR BENEFITS TO ANYONE OTHER THAN THOSE CERTIFIED TO.
- 13. UNLESS IT BEARS THE SIGNATURE AND THE ORIGINAL RAISED SEAL OF A FLORIDA LICENSED SURVEYOR AND MAPPER THIS DRAWING, SKETCH, PLAT OR MAP IS FOR INFORMATIONAL PURPOSES ONLY AND IS NOT VALID.
- 14. ADDITIONS OR DELETIONS TO SURVEY MAPS OR REPORTS BY OTHER THAN THE SIGNING PARTY OR PARTIES IS PROHIBITED WITHOUT WRITTEN CONSENT OF THE SIGNING PARTY OR PARTIES.
- 15. LAST DATE OF FIELD SURVEY: 02/01/2016

KING ENGINEERING ASSOCIATES, INC.
4921 MEMORIAL HIGHWAY,
TAMPA, FL 33634
PH: 813-880-8881 FAX:813-880-8882
CERTIFICATE OF AUTHORIZATION NUMBER LB2610

DAVID WILLIAM McDANIEL, PSM FLORIDA LICENSE - LS5840

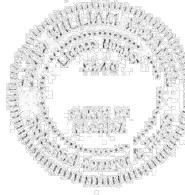

# NOTES

- 1. BASE DRAWINGS PROVIDED BY THE CITY OF CLEAWATER. BASE DRAWINGS PER 1992 PROJECT NO. 87072-2 RECORD DRAWINGS. THE CONTRACTOR SHALL BE RESPONSIBLE FOR VERIFYING THE LOCATION AND ELEVATION OF ALL UNDER GROUND/ABOVE GROUND STRUCTURES, PIPING, FITTINGS, CONDUITS AND WIRE PRIOR TO BIDDING.
- 2. CONTRACTOR SHALL FIELD VERIFY ALL DIMENSIONS AND ELEVATIONS AND MATERIALS OF CONSTRUCTION PRIOR TO ORDERING ANY MATERIALS OR EQUIPMENT.
- 3. THE WASTEWATER TREATMENT PLANT MUST REMAIN IN OPERATION AND IN COMPLIANCE WITH THE FDEP PERMITS AT ALL TIMES. THE CONTRACTOR'S WORK SCHEDULE MAY BE IMPACTED BY OPERATION'S REQUIREMENTS THROUGHOUTTHE PROJECT.
- 4. CONTRACTOR IS HEREBY NOTIFIED THAT SPILLS ARE STRICTLY PROHIBITED DURING THE PROJECT. ANY FINES INCURRED AS A RESULT OF SPILLS WILL BE THE SOLE RESPONSIBILITY OF THE CONTRACTOR.

ARDURRA
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G1.01

SUNSHINE STATE
ONE CALL
OF FLORIDA


www.callsunshine.com
(800) 432-4770
MIN. 48 HOURS
BEFORE YOU EXCAVATE


EAST WRF INFLUENT PUMP STATION
REHABILITATION PROJECT
SURVEYOR'S REPORT & GENERAL NOTES


OWG NAME: General-100.dwg	FIELD BOOK:	SURVEYED BY:	SCALE: VERT.	N //	Δ
			4 VEN 1.	11/	<u> </u>
CONTRACT NO.:	DATE DRAWN: 9/28/2023	DRAWN BY:	HORIZ.	AS	SHOWN
JOB NO.: 2018-1721-01	DESIGNED BY:	CHECKED BY:	SHEET NO.:	OF	40
APPROVED FOR CONSTRUCTION					
			_		


CITY OF CLEARWATER, FLORIDA
ENGINEERING DEPARTMENT
100 S. MYRTLE AVE.
CLEARWATER, FL 33756




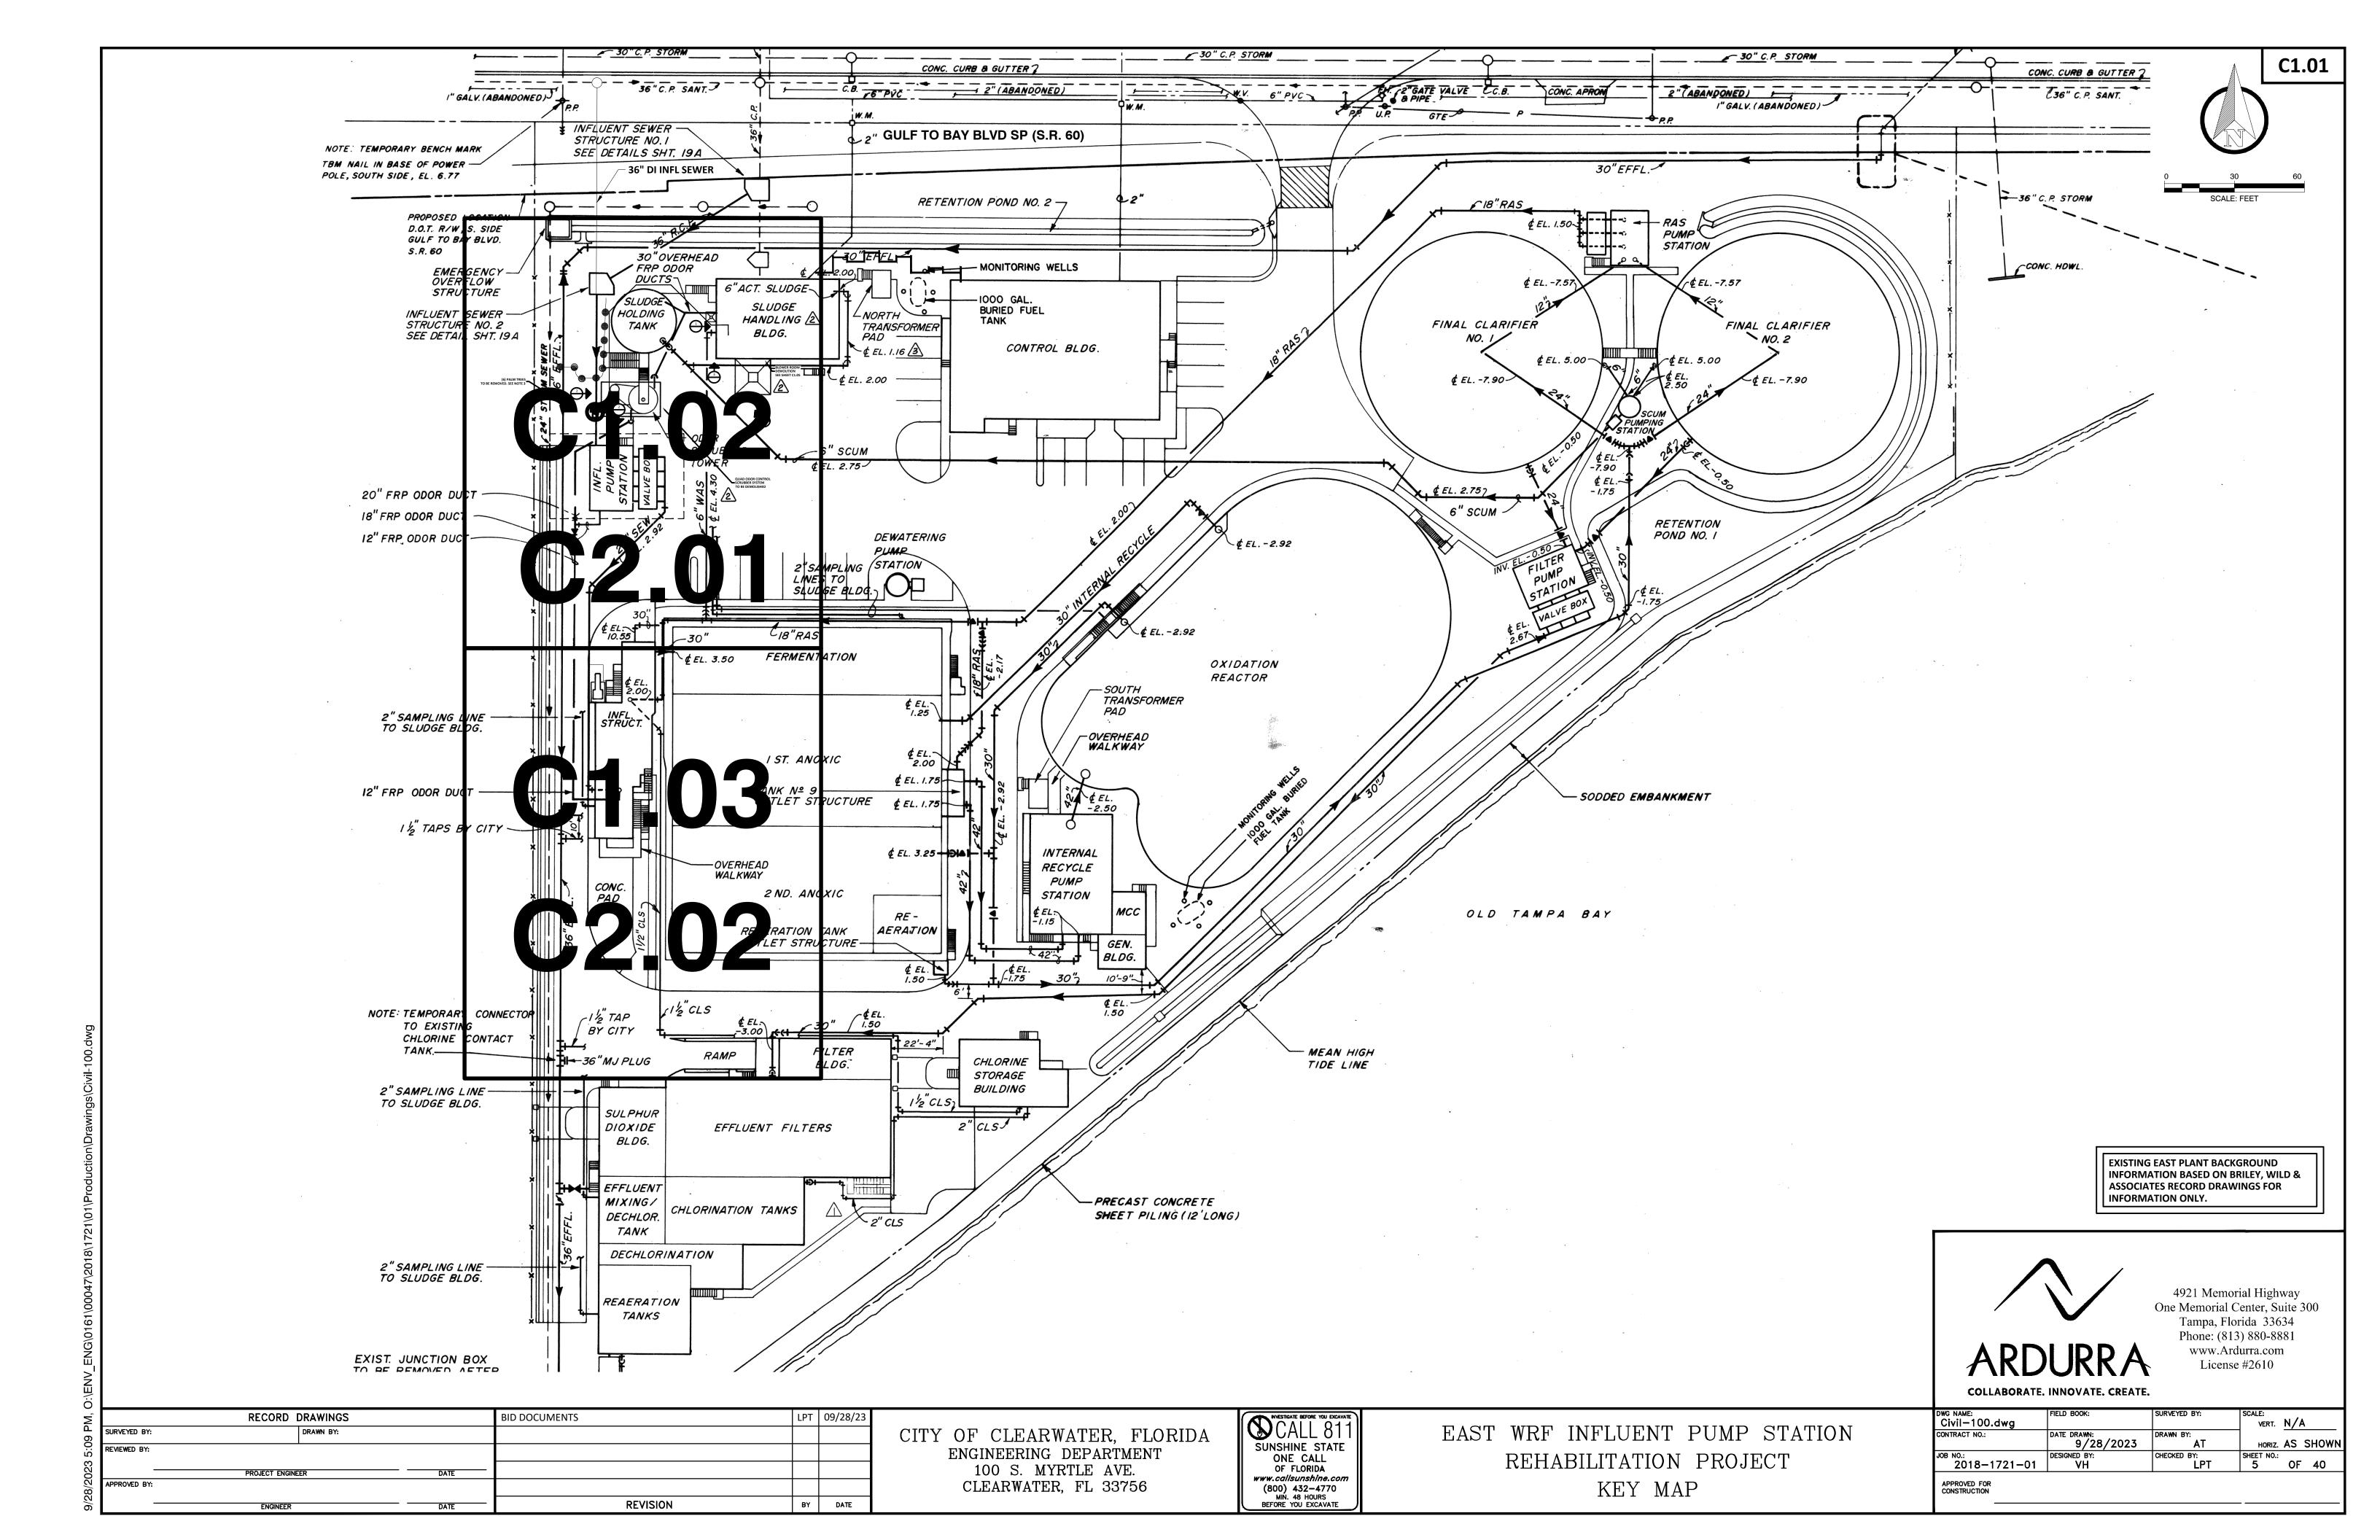


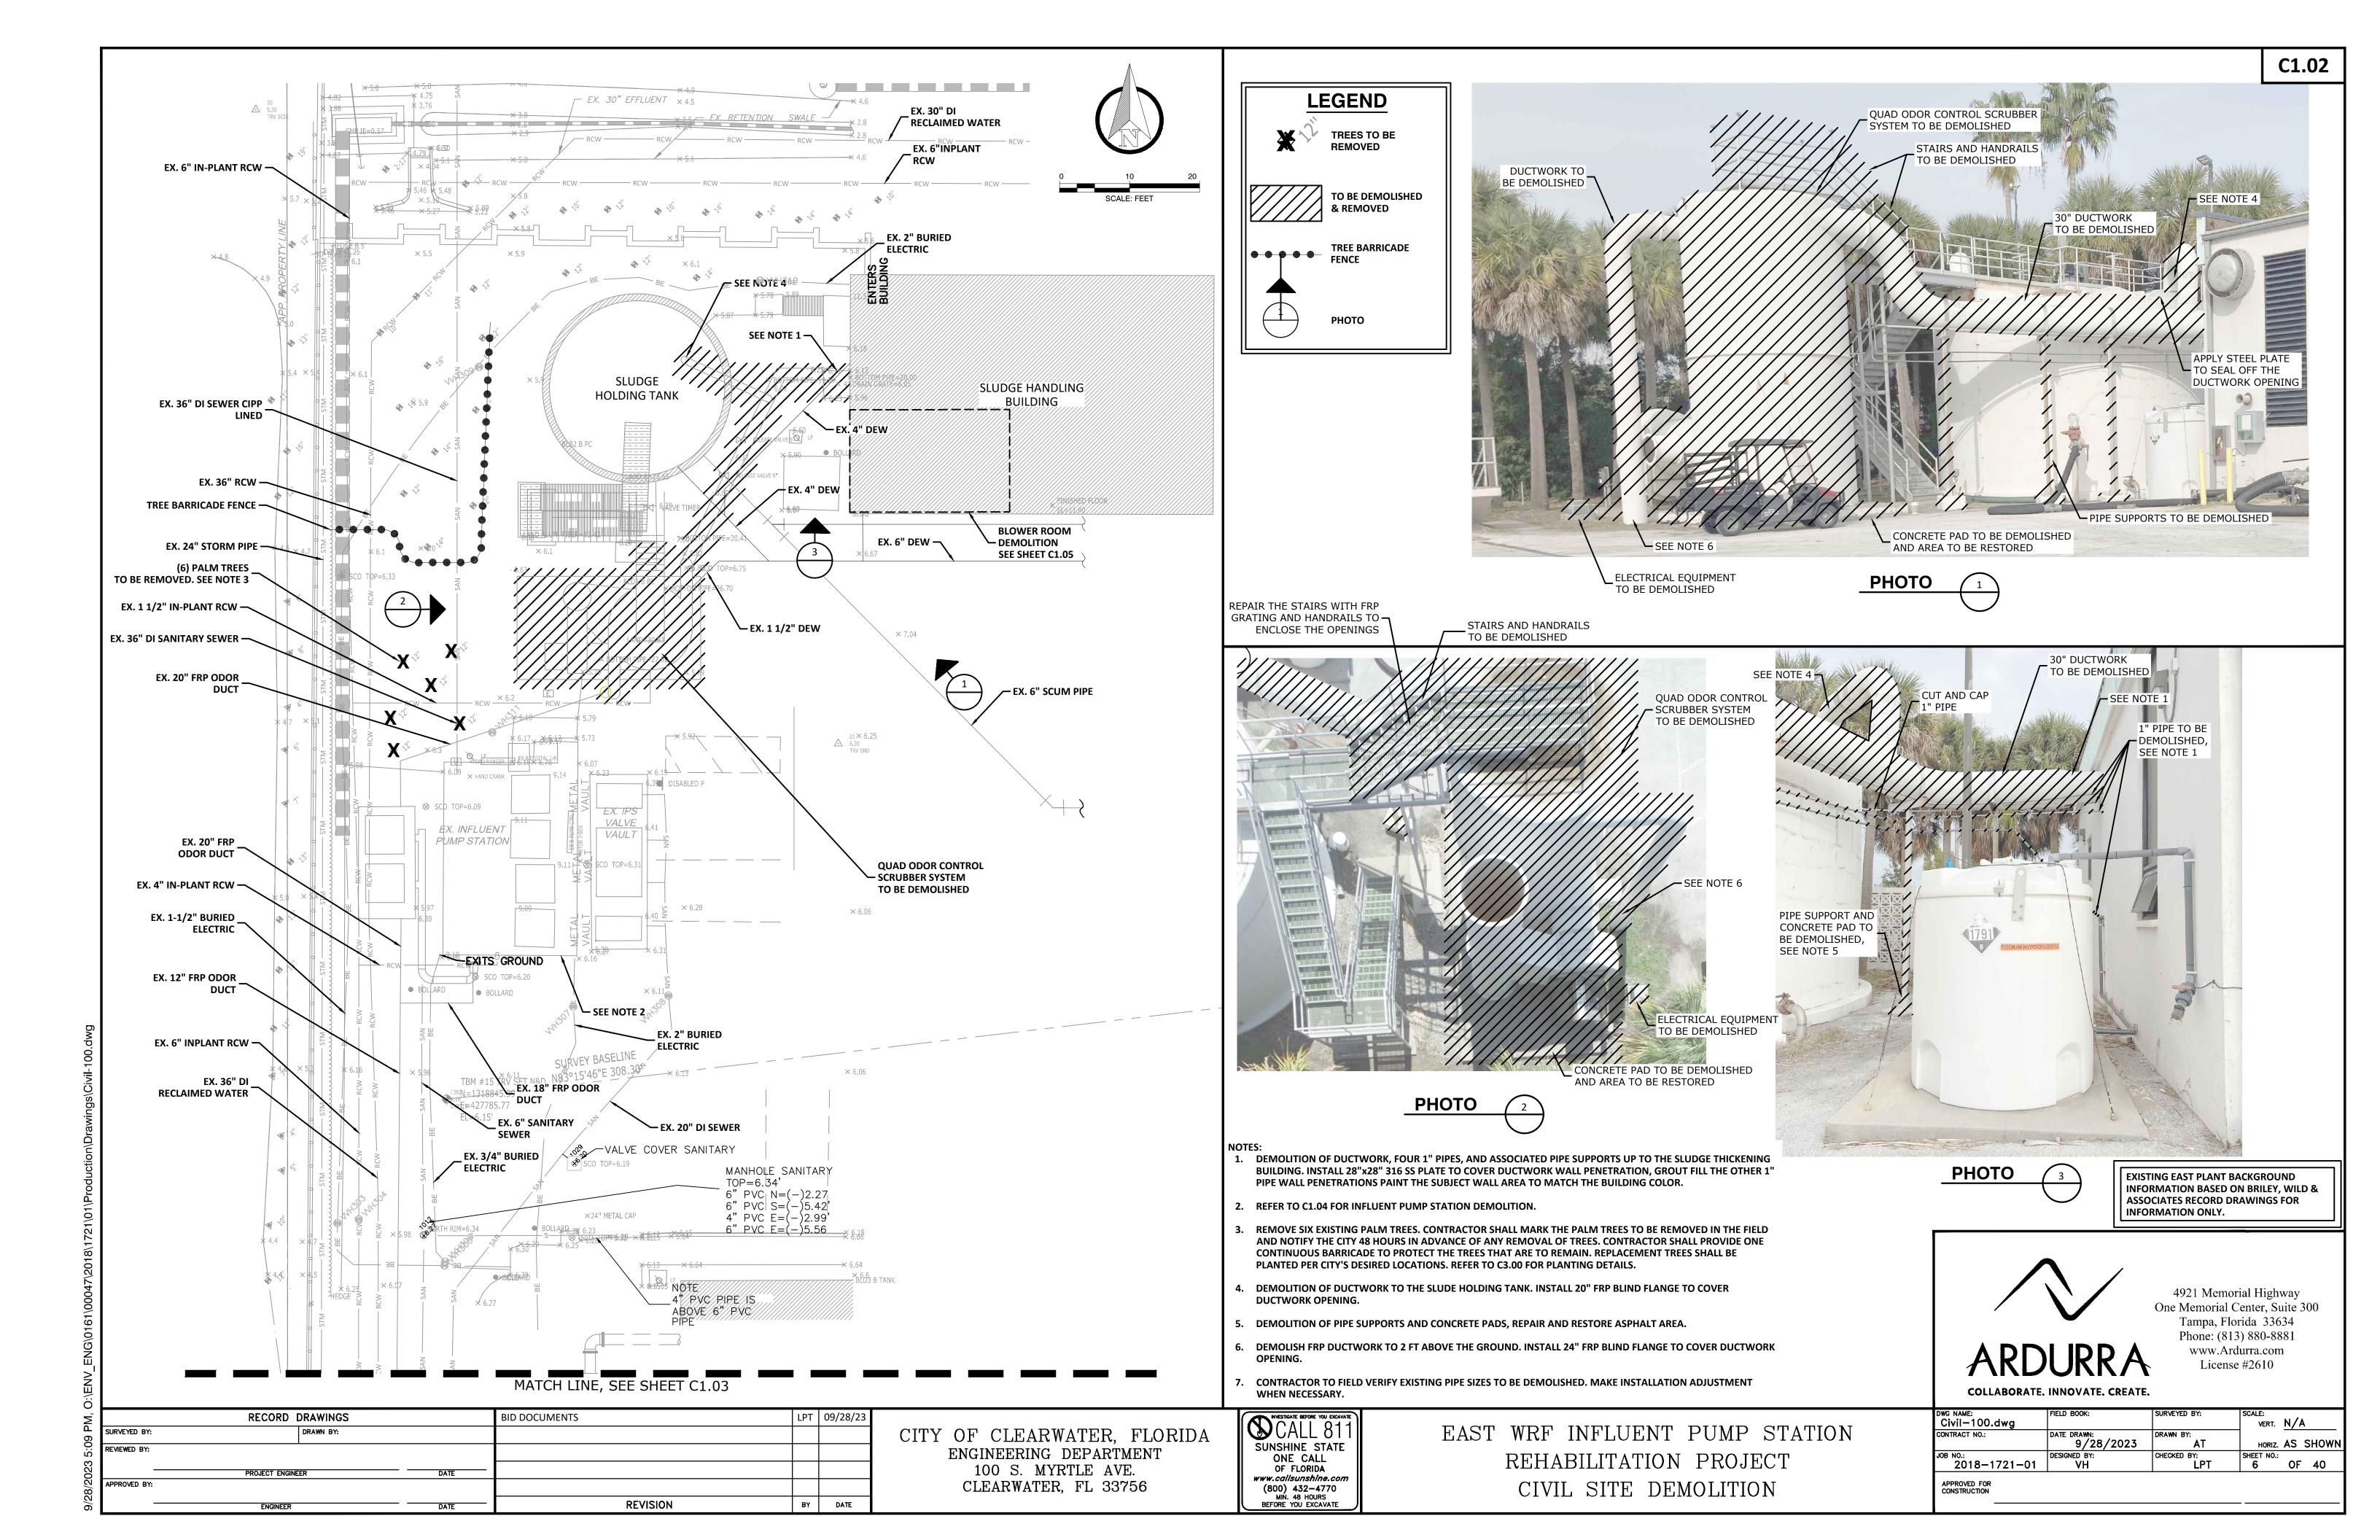

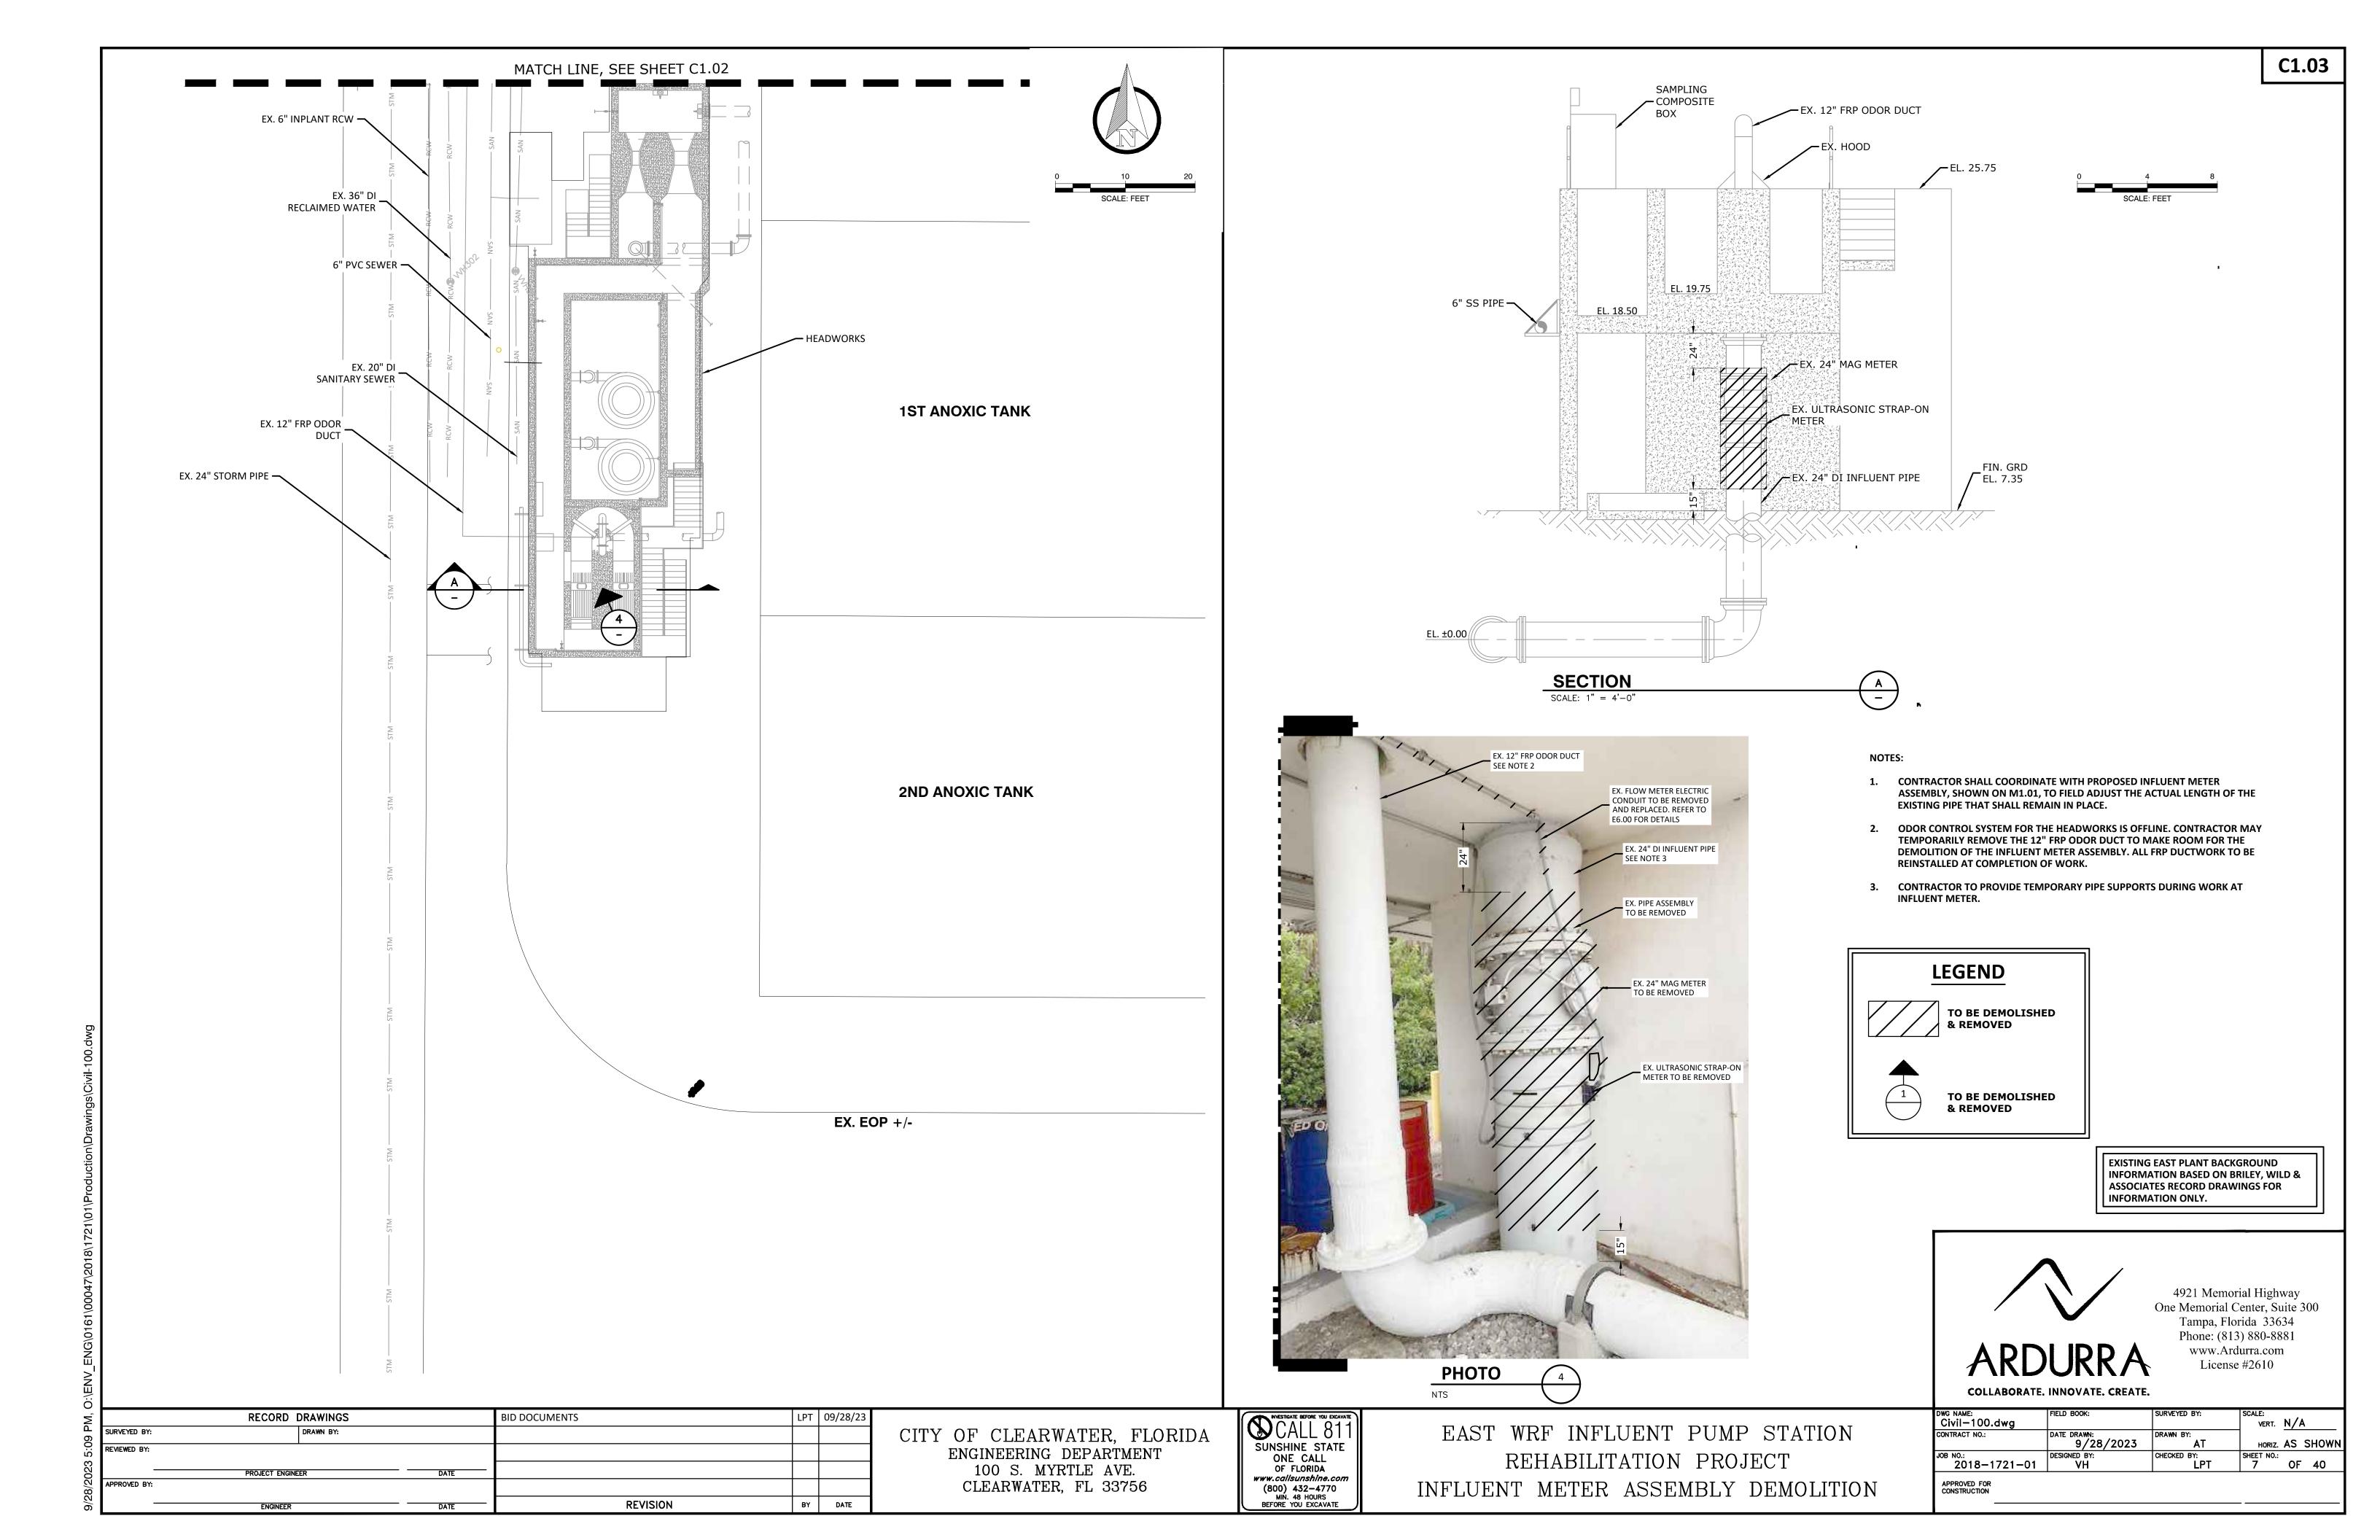

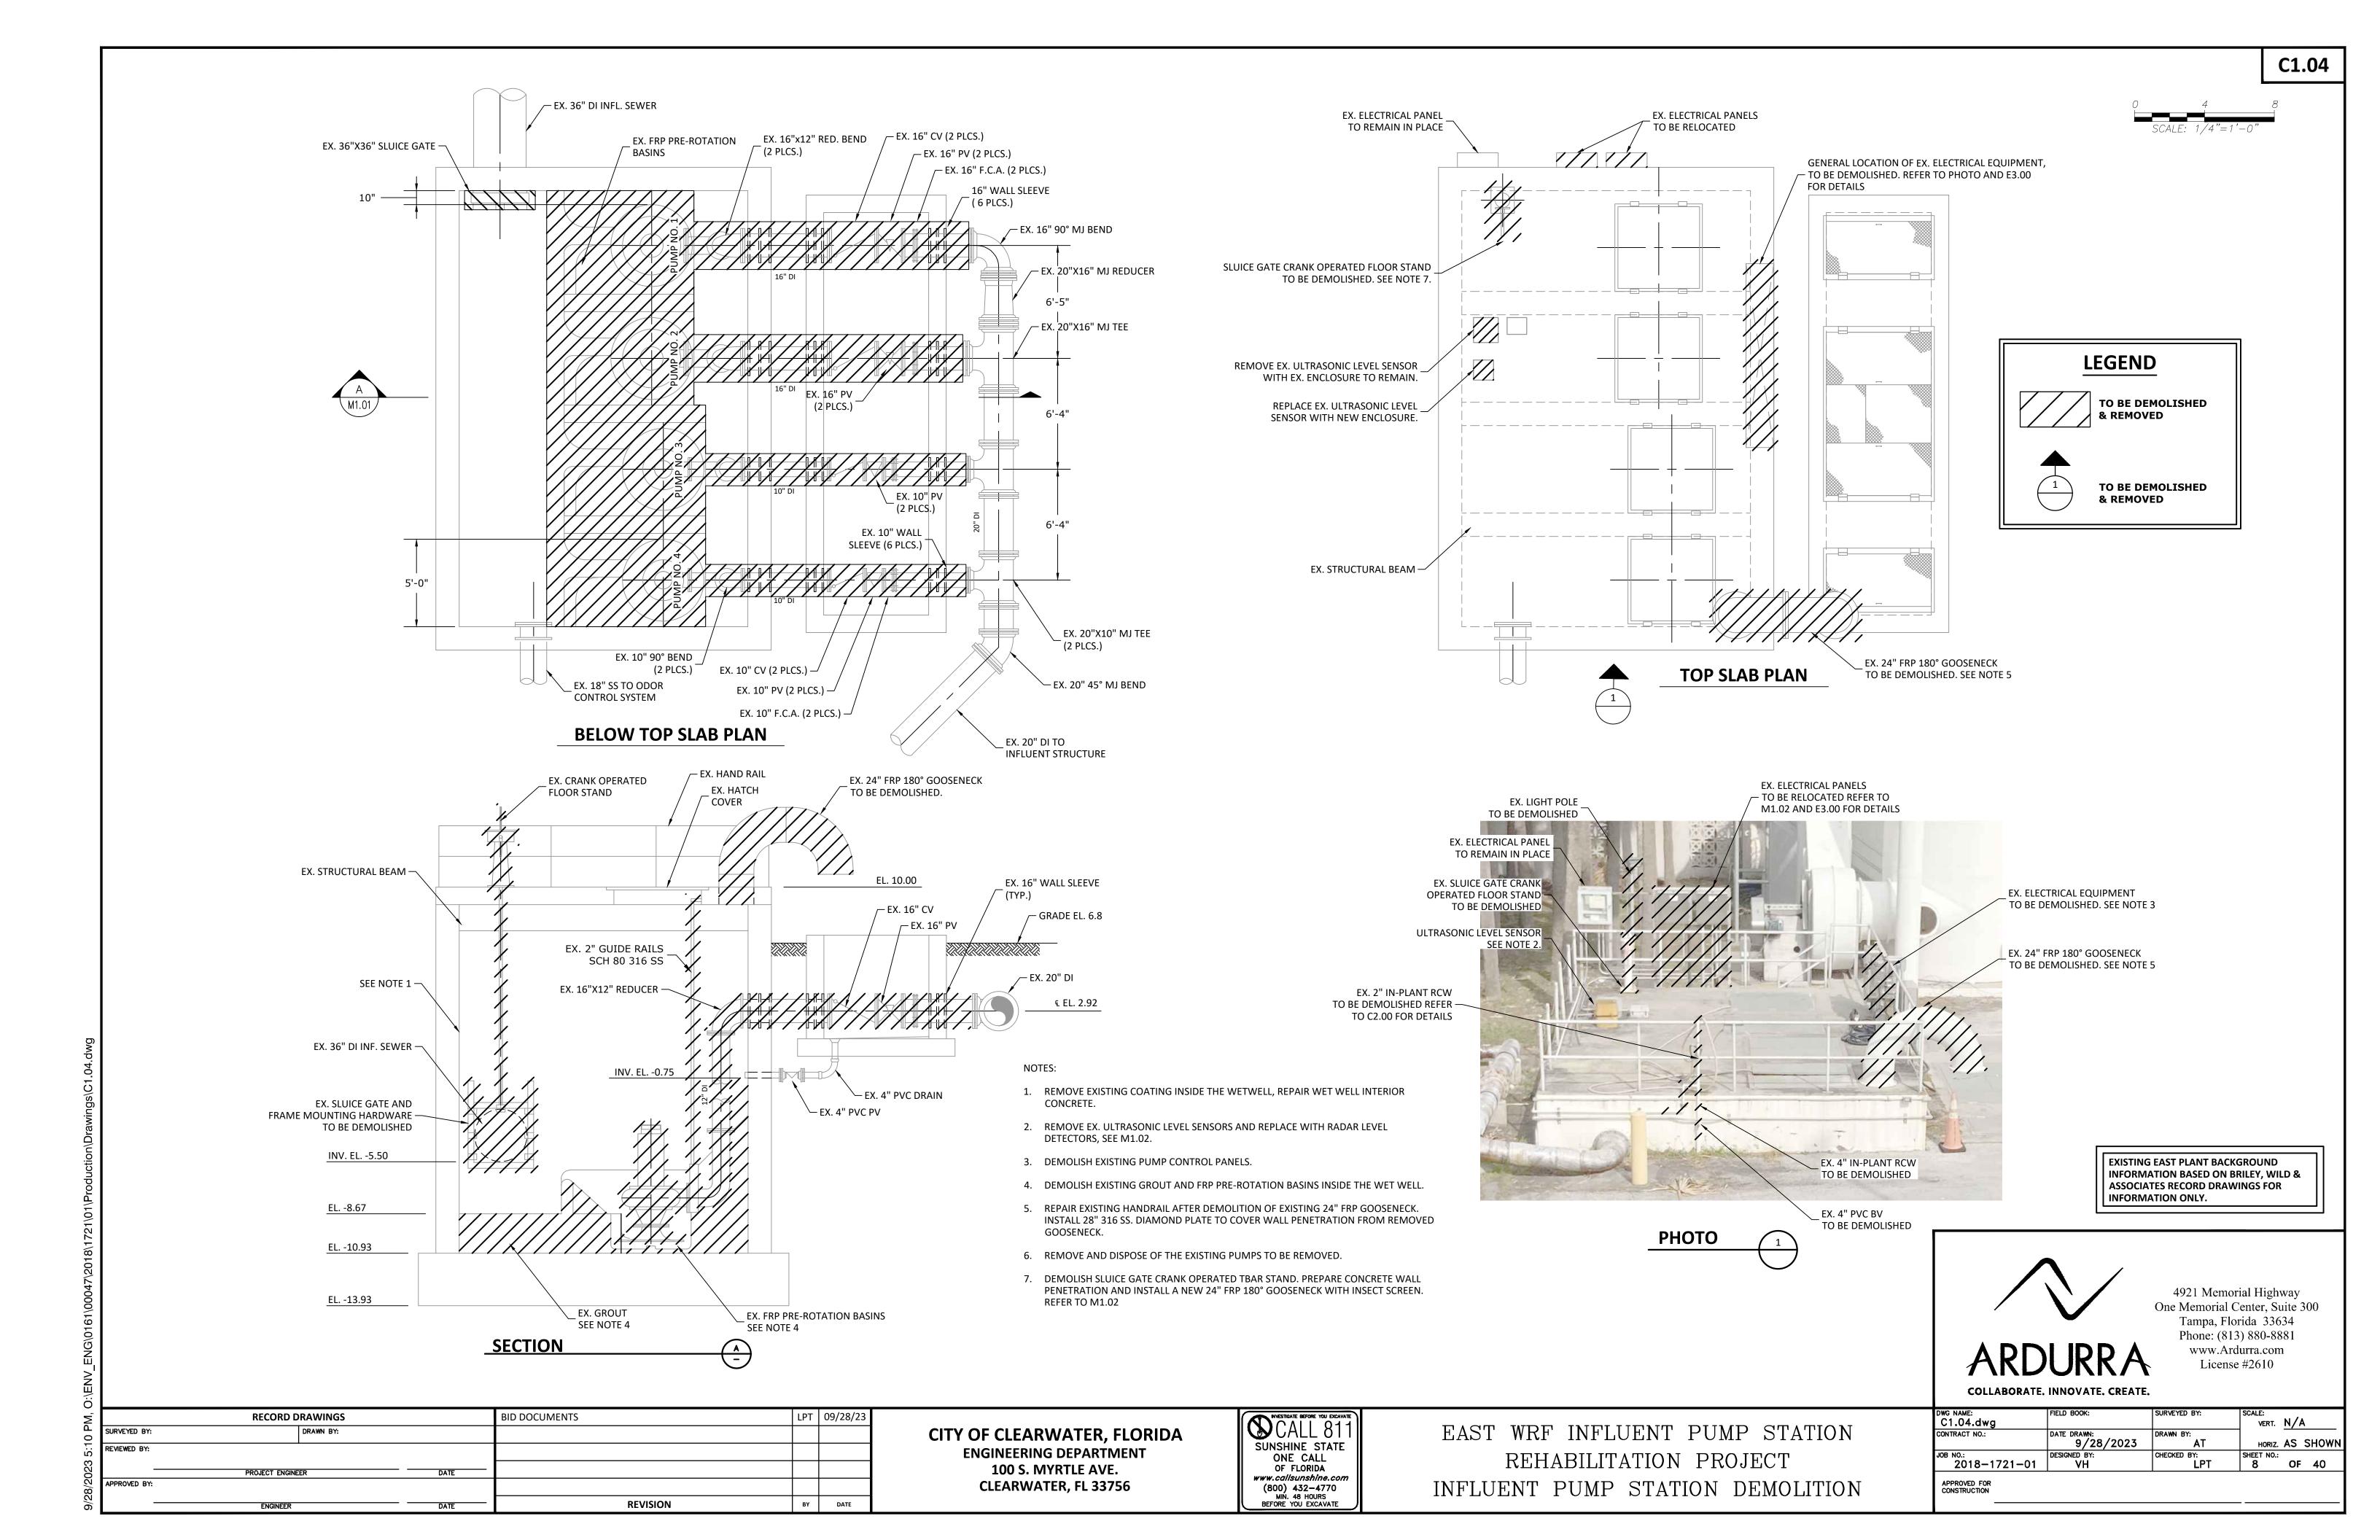

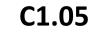

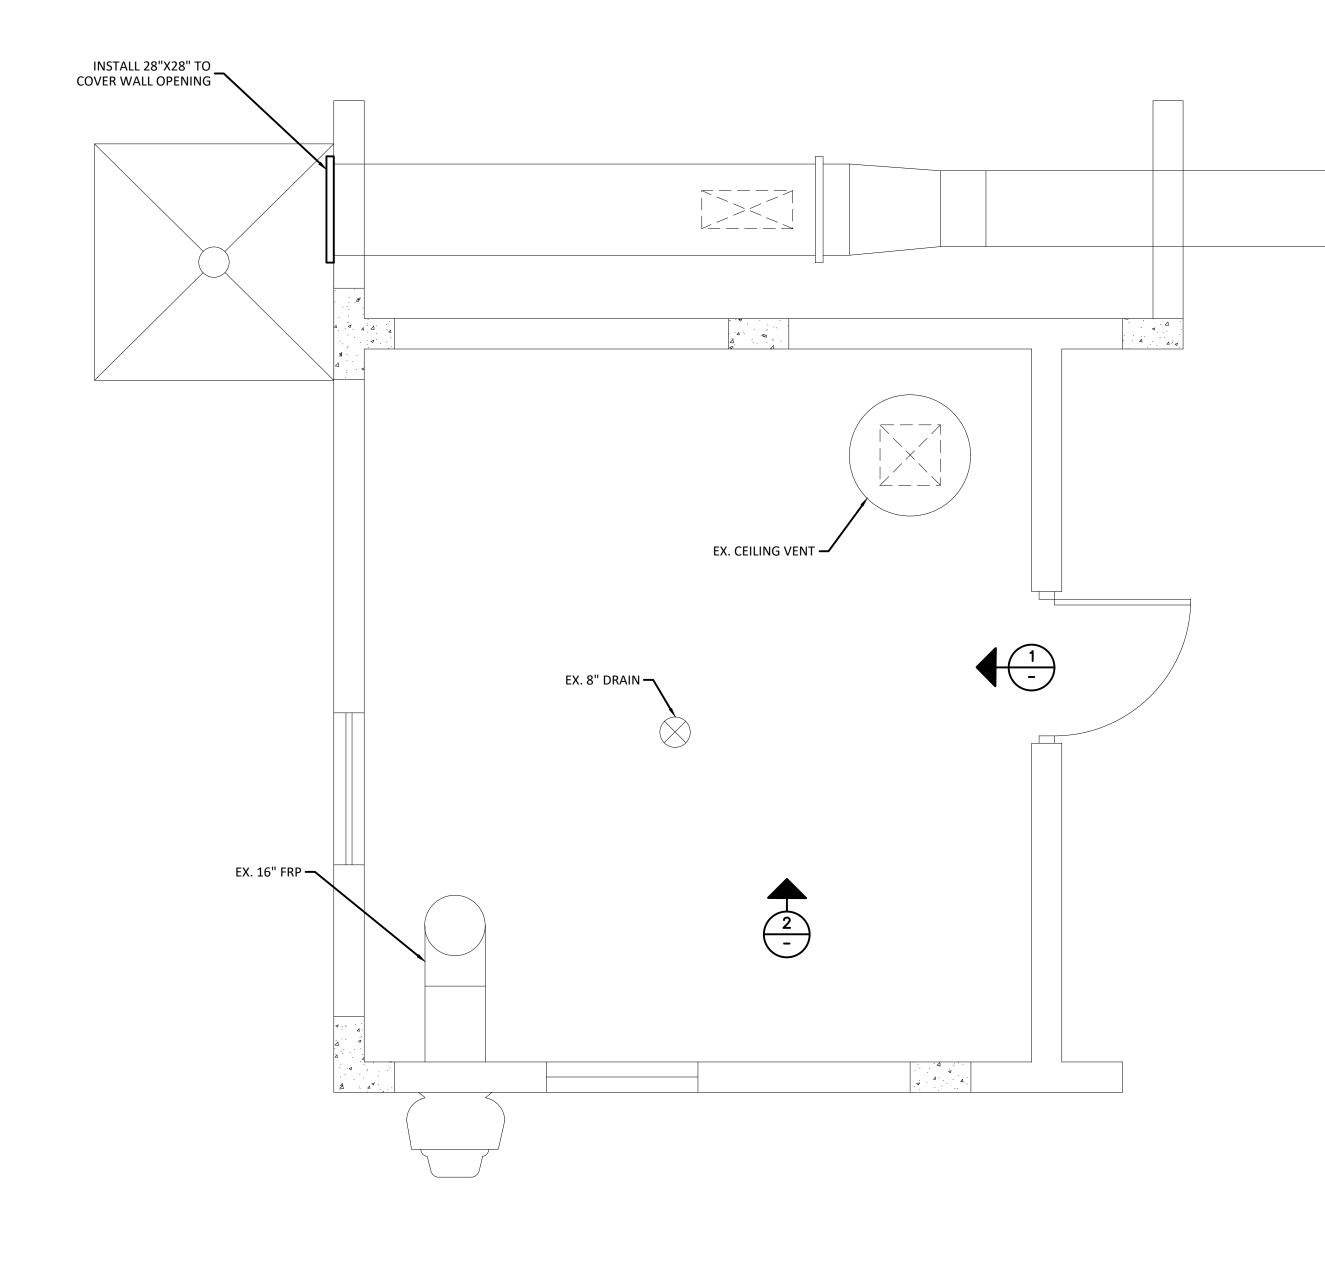

**BLOWER ROOM** 

CHEMICAL PIPING
TO BE DEMOUSHED

ABANDONED AIR COMPRESSOR
TO BE DEMOUSHED

CITY TO RELOCATE
MAINTENANCE EQUIPMENT

EX. 8" DRAIN

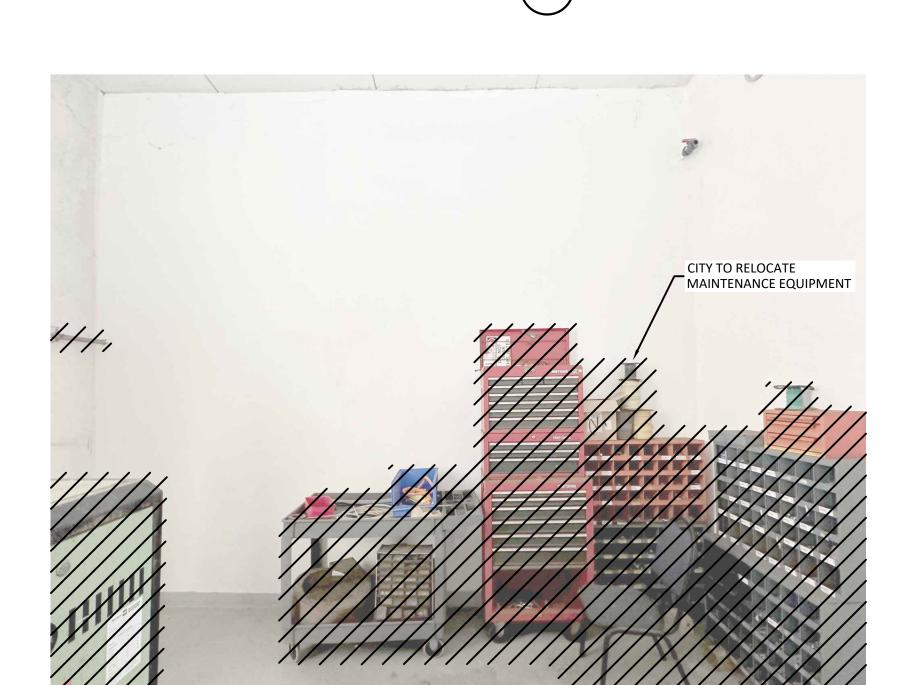


PHOTO 2

EXISTING EAST PLANT BACKGROUND INFORMATION BASED ON BRILEY, WILD & ASSOCIATES RECORD DRAWINGS FOR INFORMATION ONLY.

### NOTES:

1. CITY TO RELOCATE THE STORED MAINTENANCE EQUIPMENT IN THE EXISTING BLOWER ROOM.



4921 Memorial Highway
One Memorial Center, Suite 300
Tampa, Florida 33634
Phone: (813) 880-8881
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License #2610

	RECORD D	PRAWINGS	BID DOCUMENTS	LPT	09/28/23
SURVEYED BY:		DRAWN BY:			
REVIEWED BY:					
	PROJECT ENGINE	EER DATE			
APPROVED BY:					
	ENGINEER	DATE	REVISION	ВУ	DATE

CITY OF CLEARWATER, FLORIDA ENGINEERING DEPARTMENT 100 S. MYRTLE AVE. CLEARWATER, FL 33756 NVESTIGATE BEFORE YOU EXCAVATE

CALL 811

SUNSHINE STATE

ONE CALL

OF FLORIDA

www.callsunshine.com

(800) 432-4770


MIN. 48 HOURS

BEFORE YOU EXCAVATE

EAST WRF INFLUENT PUMP STATION
REHABILITATION PROJECT
SLUDGE HANDLING BUILDING BLOWER ROOM DEMOLITION

DWG NAME:	FIELD BOOK:	SURVEYED BY:	SCALE:		
C1.04.dwg			VERT.	N/A	4
CONTRACT NO.:	DATE DRAWN:	DRAWN BY:			
	9/28/2023	AT	HORIZ.	AS	SHOWN
JOB NO.:	DESIGNED BY:	CHECKED BY:	SHEET NO.:		
2018-1721-01	VH	LPT	9	OF	40



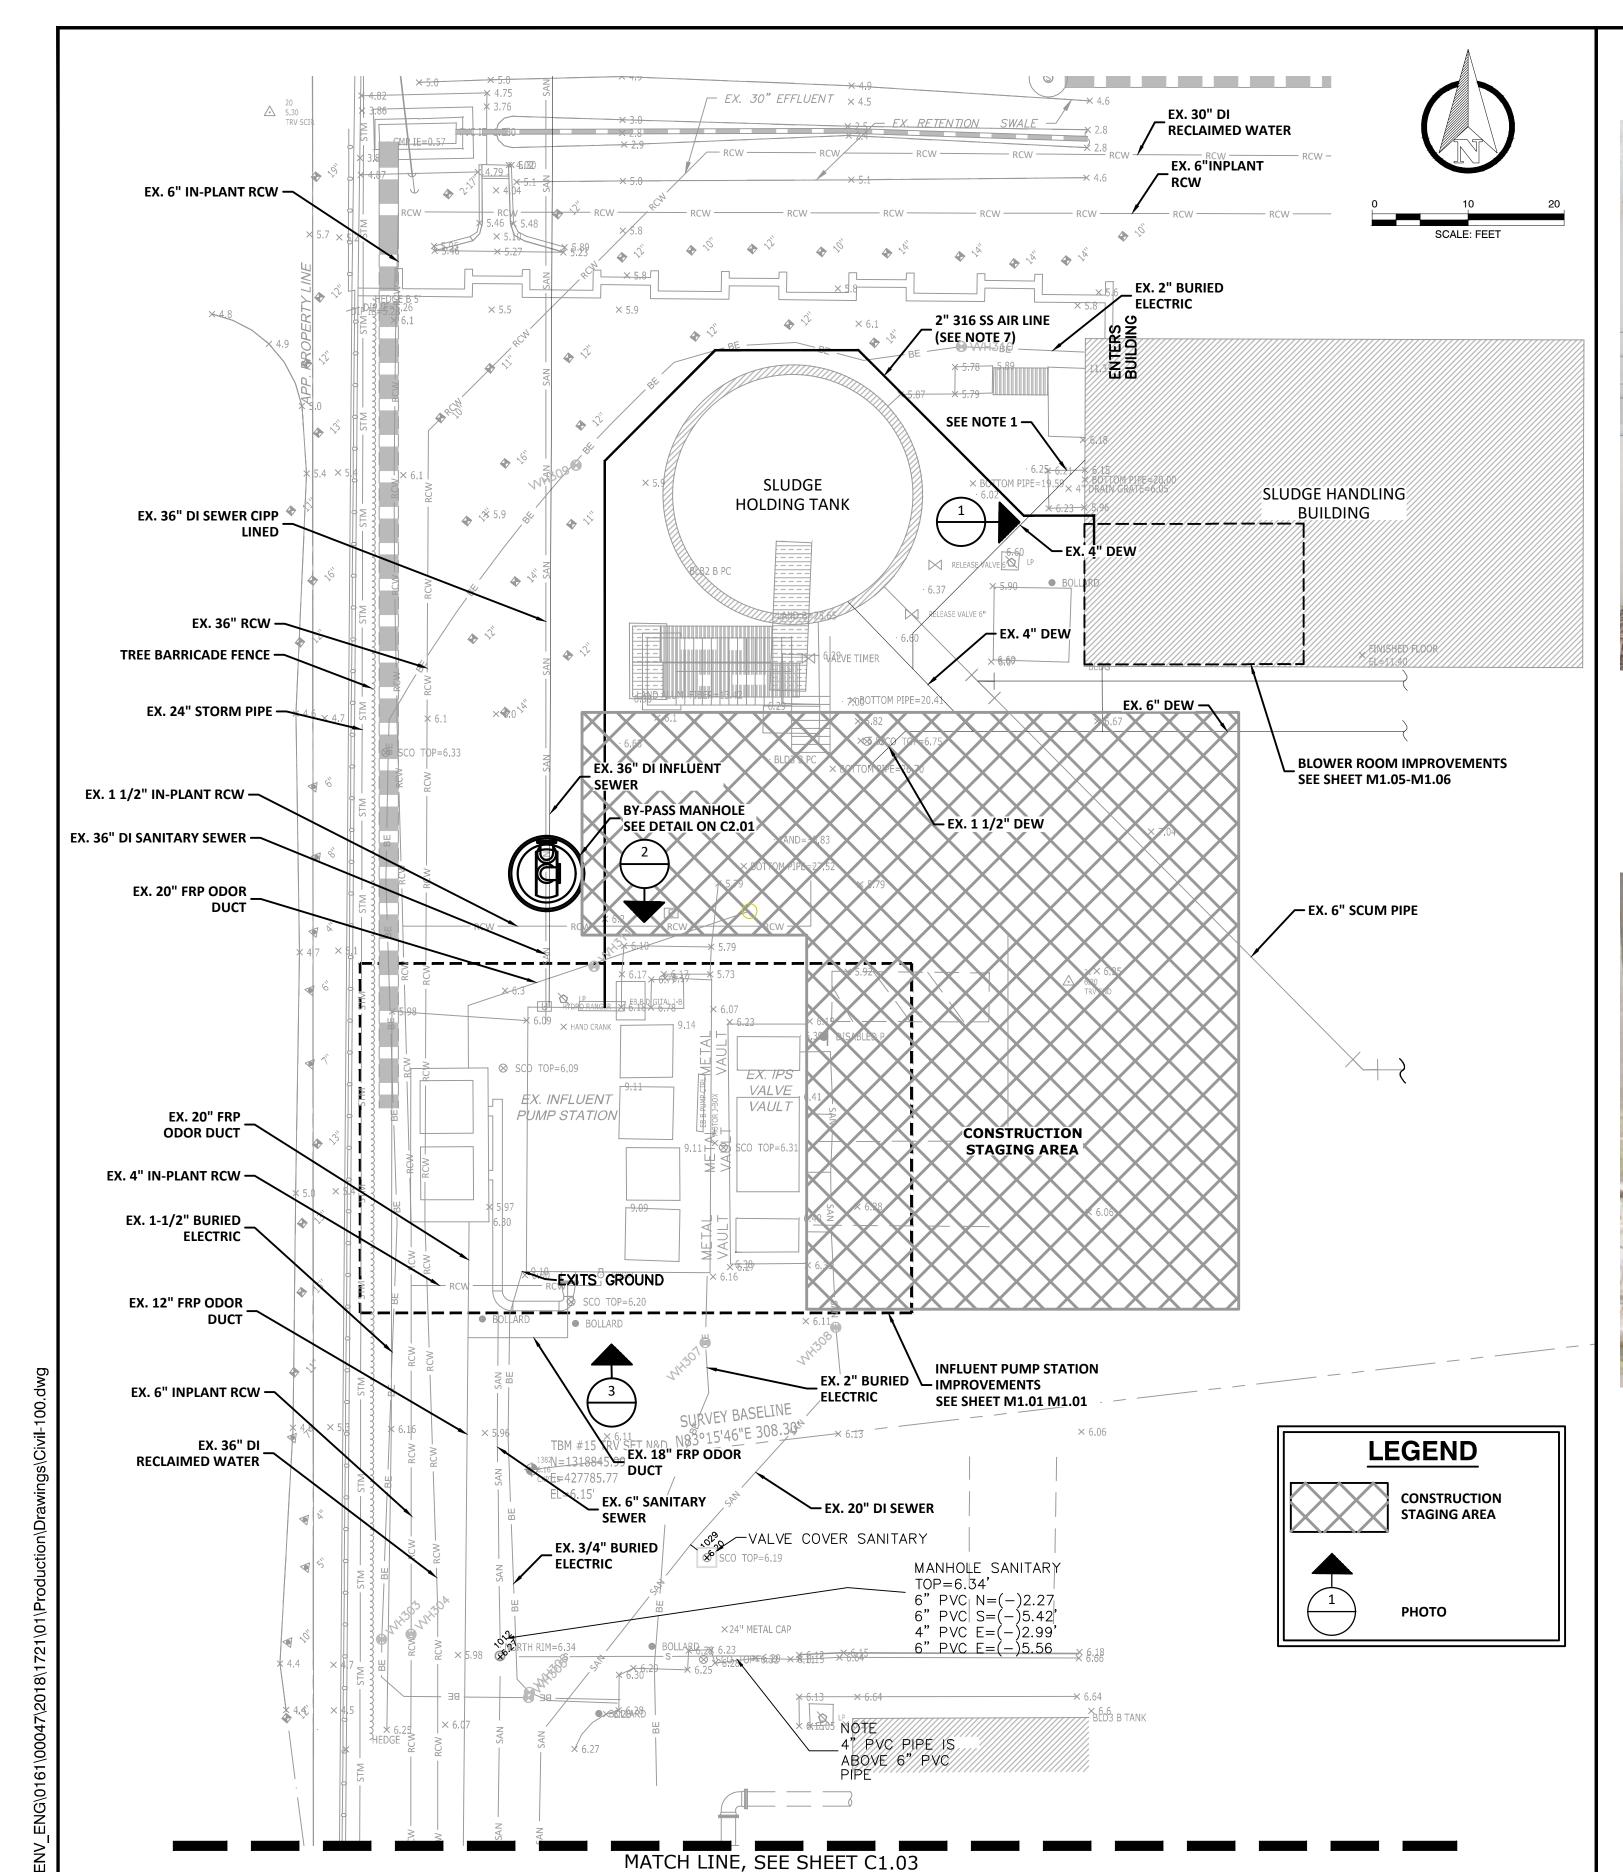

**RECORD DRAWINGS** 

PROJECT ENGINEER

SURVEYED BY:

REVIEWED BY:

BID DOCUMENTS

**REVISION** 

| LPT | 09/28/23

BY DATE




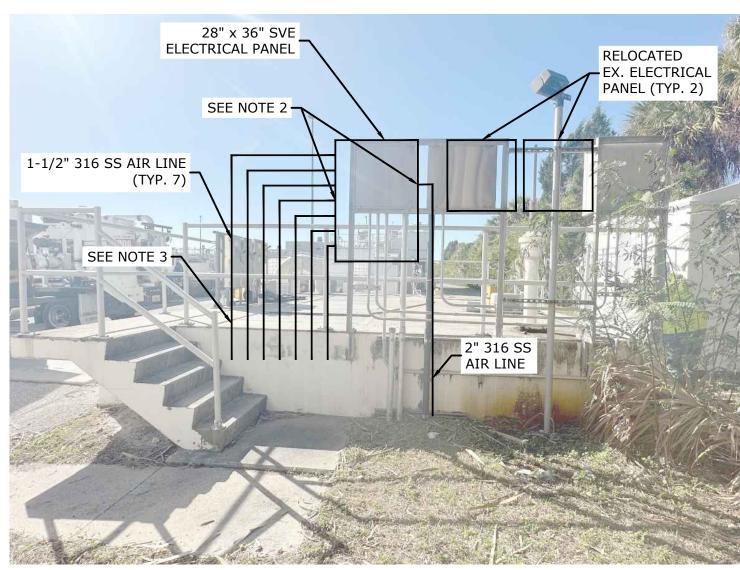


PHOTO 1



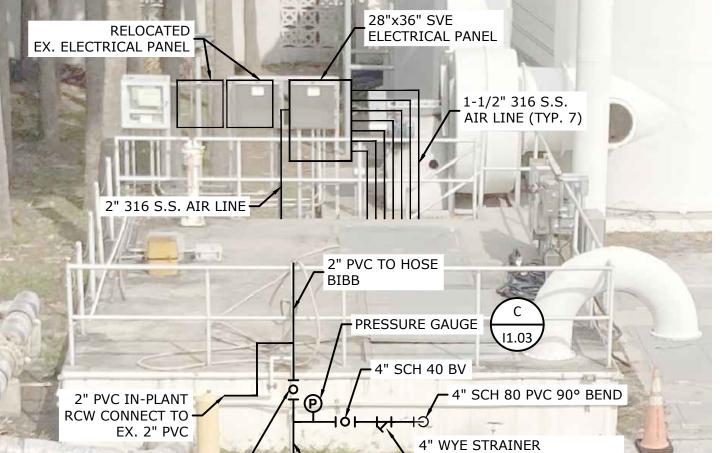

NOTES

- 1. CONTRACTOR SHALL BE AWARE THE EXISTING PIPE BACKGROUND IS FOR INFORMATION ONLY, NOT ALL PIPES HAVE BEEN LOCATED AND VERIFIED BY SUE. CONTRACTOR SHALL USE CAUTION WHEN DIGGING. FIELD VERIFY ALL EXISTING PIPE SIZES AND LOCATIONS.
- 2. SVE ELECTRICAL PANEL CONTAINS (1) 2" INLET AND (7) 1-1/2" OUTLETS, PIPE CONNECTING LOCATIONS PER MANUFACTURER REQUIREMENT.
- 3. CONTRACTOR TO MAINTAIN MINIMUM 3" SEPARATION BETWEEN THE (7) 1-1/2" 316 S.S. AIRLINES PENETRATING THE WET WELL.THE AIR LINE PIPE SCHEMATIC IS FOR DEMONSTRATION ONLY, REFER TO SHEET SX.XX FOR PIPE WALL PENETRATION LOCATIONS. INSTALL LINK SEALS FOR WET WELL WALL PENETRATIONS.
- 1. CONTRACTOR SHALL INSTALL EQUIPMENT RACK FOR THE ELECTRICAL PANELS AND AIR PIPES. INSTALL U-BOLT PIPE SUPPORTS EVERY 4' ON CENTER, AND AT 90° BENDS
- 5. ALL PVC PIPING AND FITTINGS SHALL BE SCH 40, UNLESS SPECIFICALLY NOTED OTHERWISE.
- ALL SMALL DIAMETER PIPING 4" AND BELOW SHALL BE ADEQUATELY SUPPORTED USING 316 S.S. UNISTRUT AND PIPE CLAMPS.
- THE 2" 316 S.S. AIR PIPING SHALL BE INSTALLED AT MINIMUM DEPTH OF 36" BELOW GRADE. CONTRACTOR SHALL FURNISH NECESSARY 316 S.S. BENDS TO ROUTE THE AIR PIPING FROM THE AIR COMPRESSOR TO THE SUE PANEL.

PHOTO 3

4" PVC BV (TYP. 2)

EXISTING EAST PLANT BACKGROUND INFORMATION BASED ON BRILEY, WILD & ASSOCIATES RECORD DRAWINGS FOR INFORMATION ONLY.



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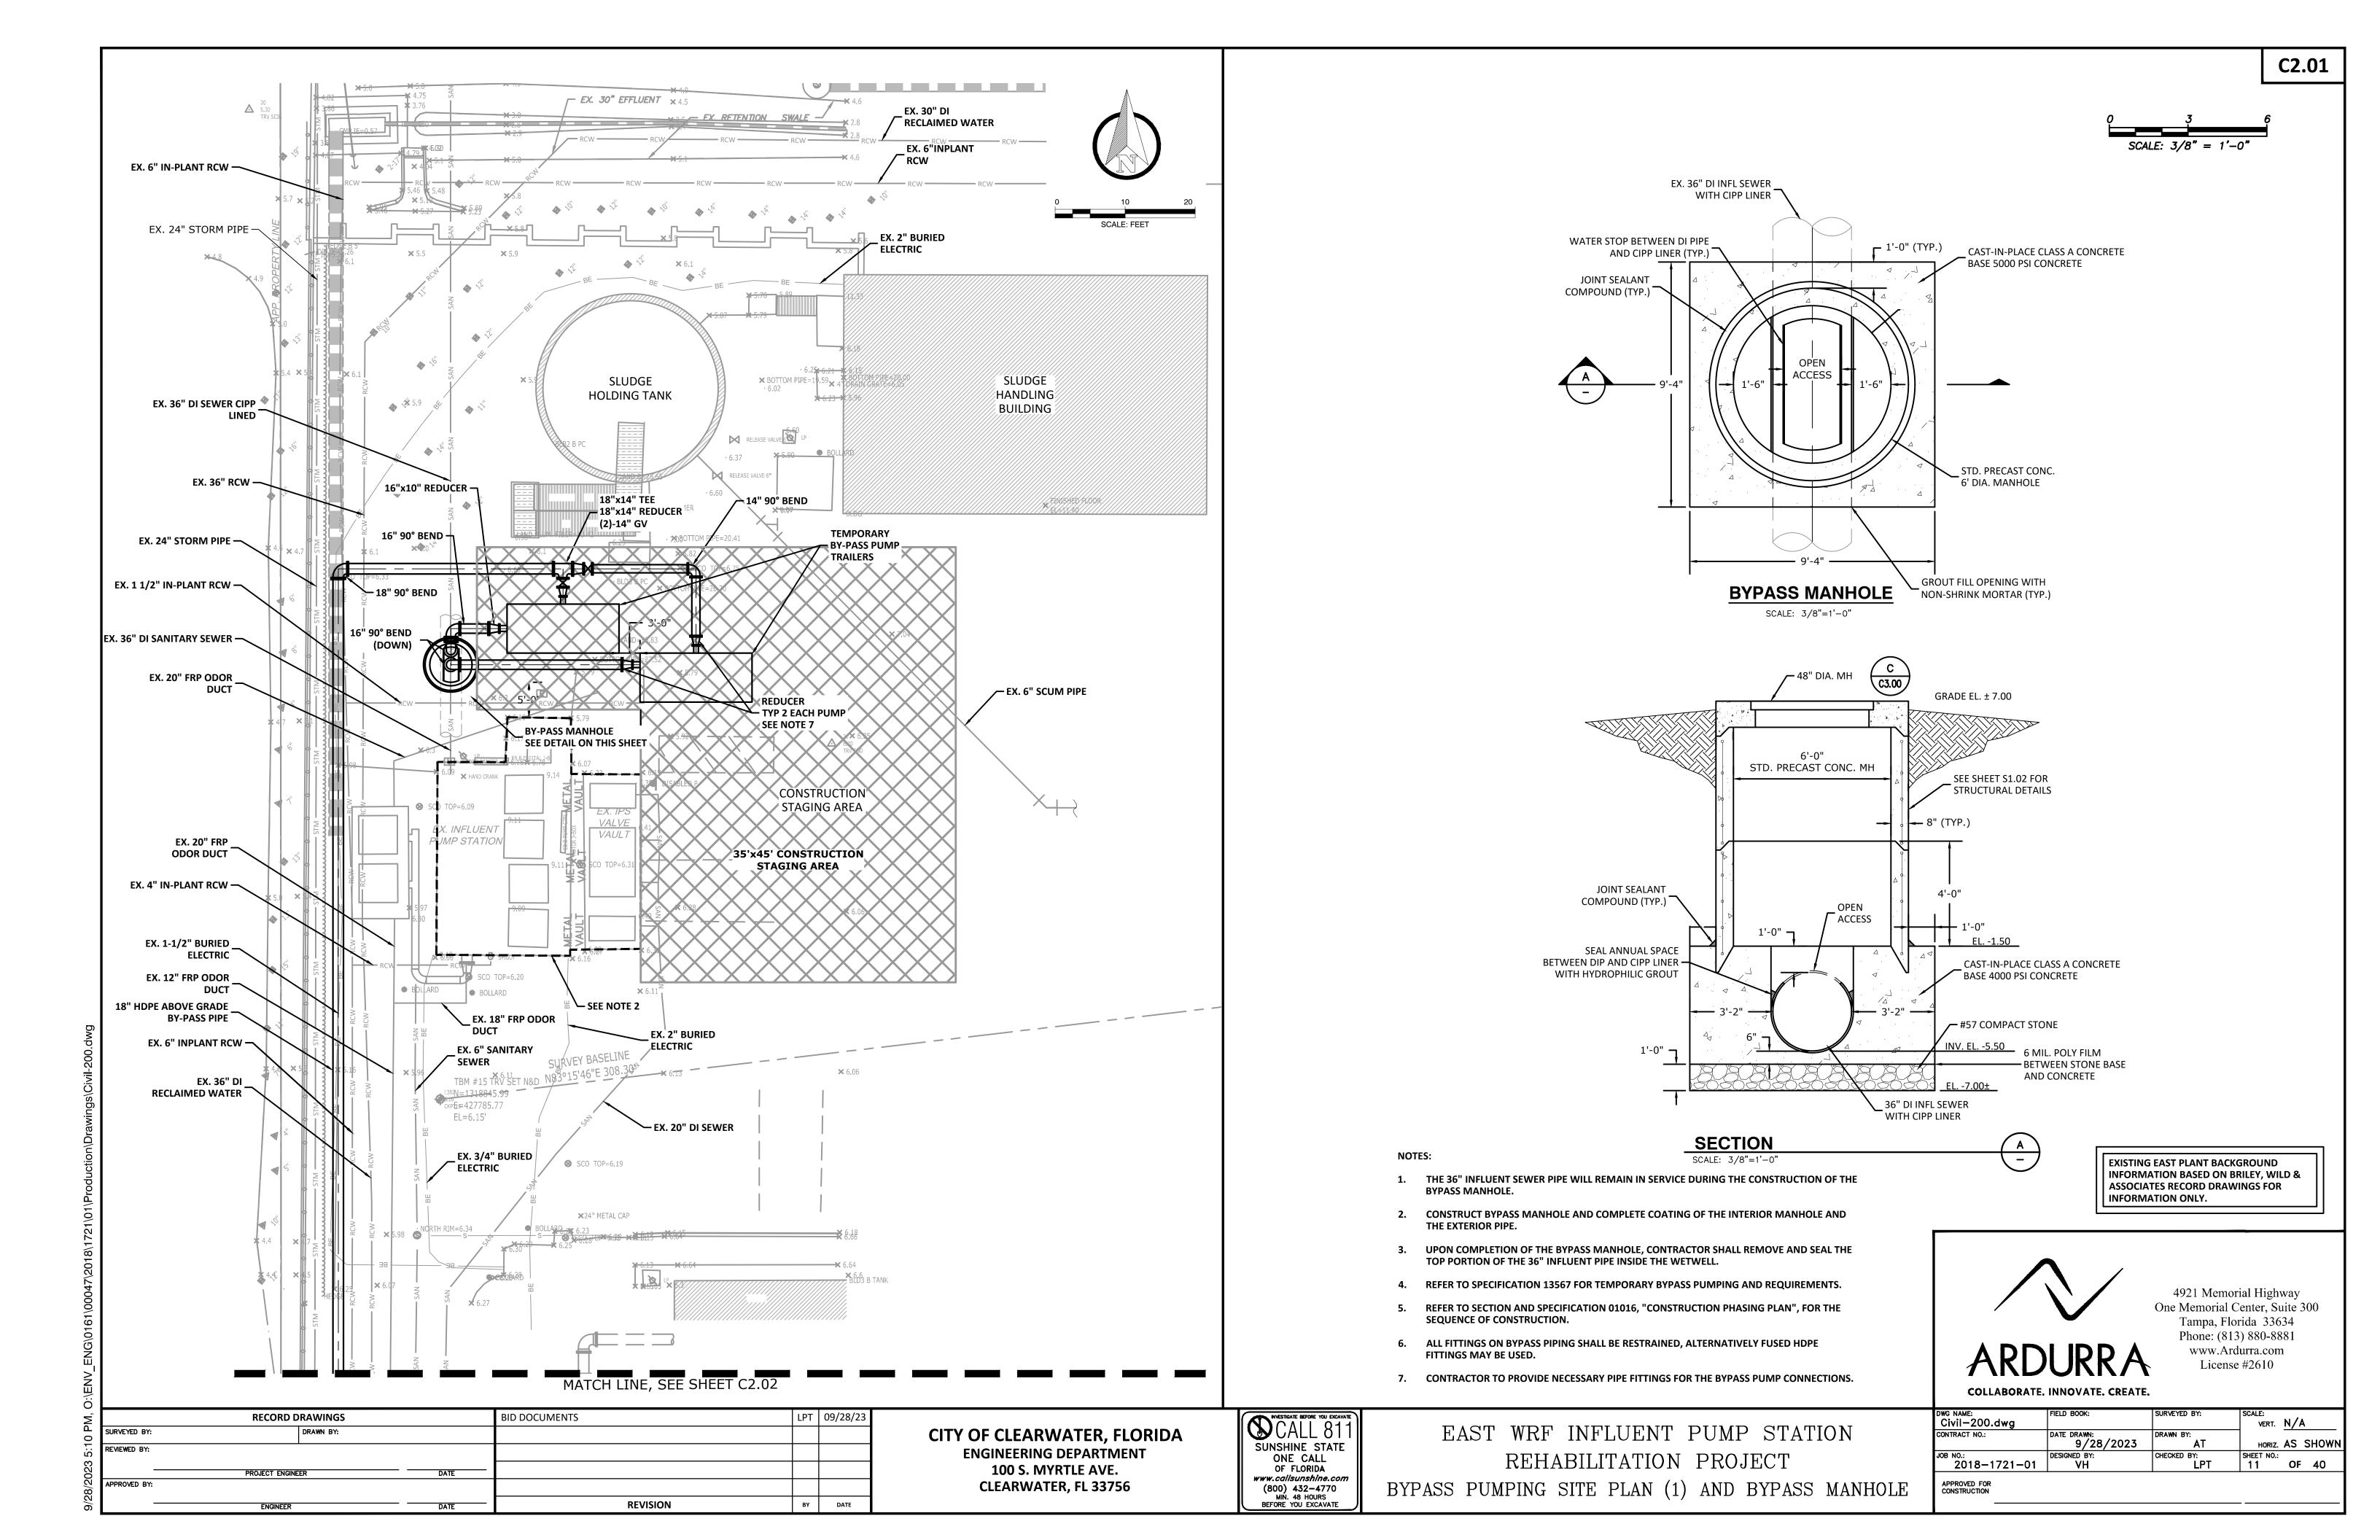
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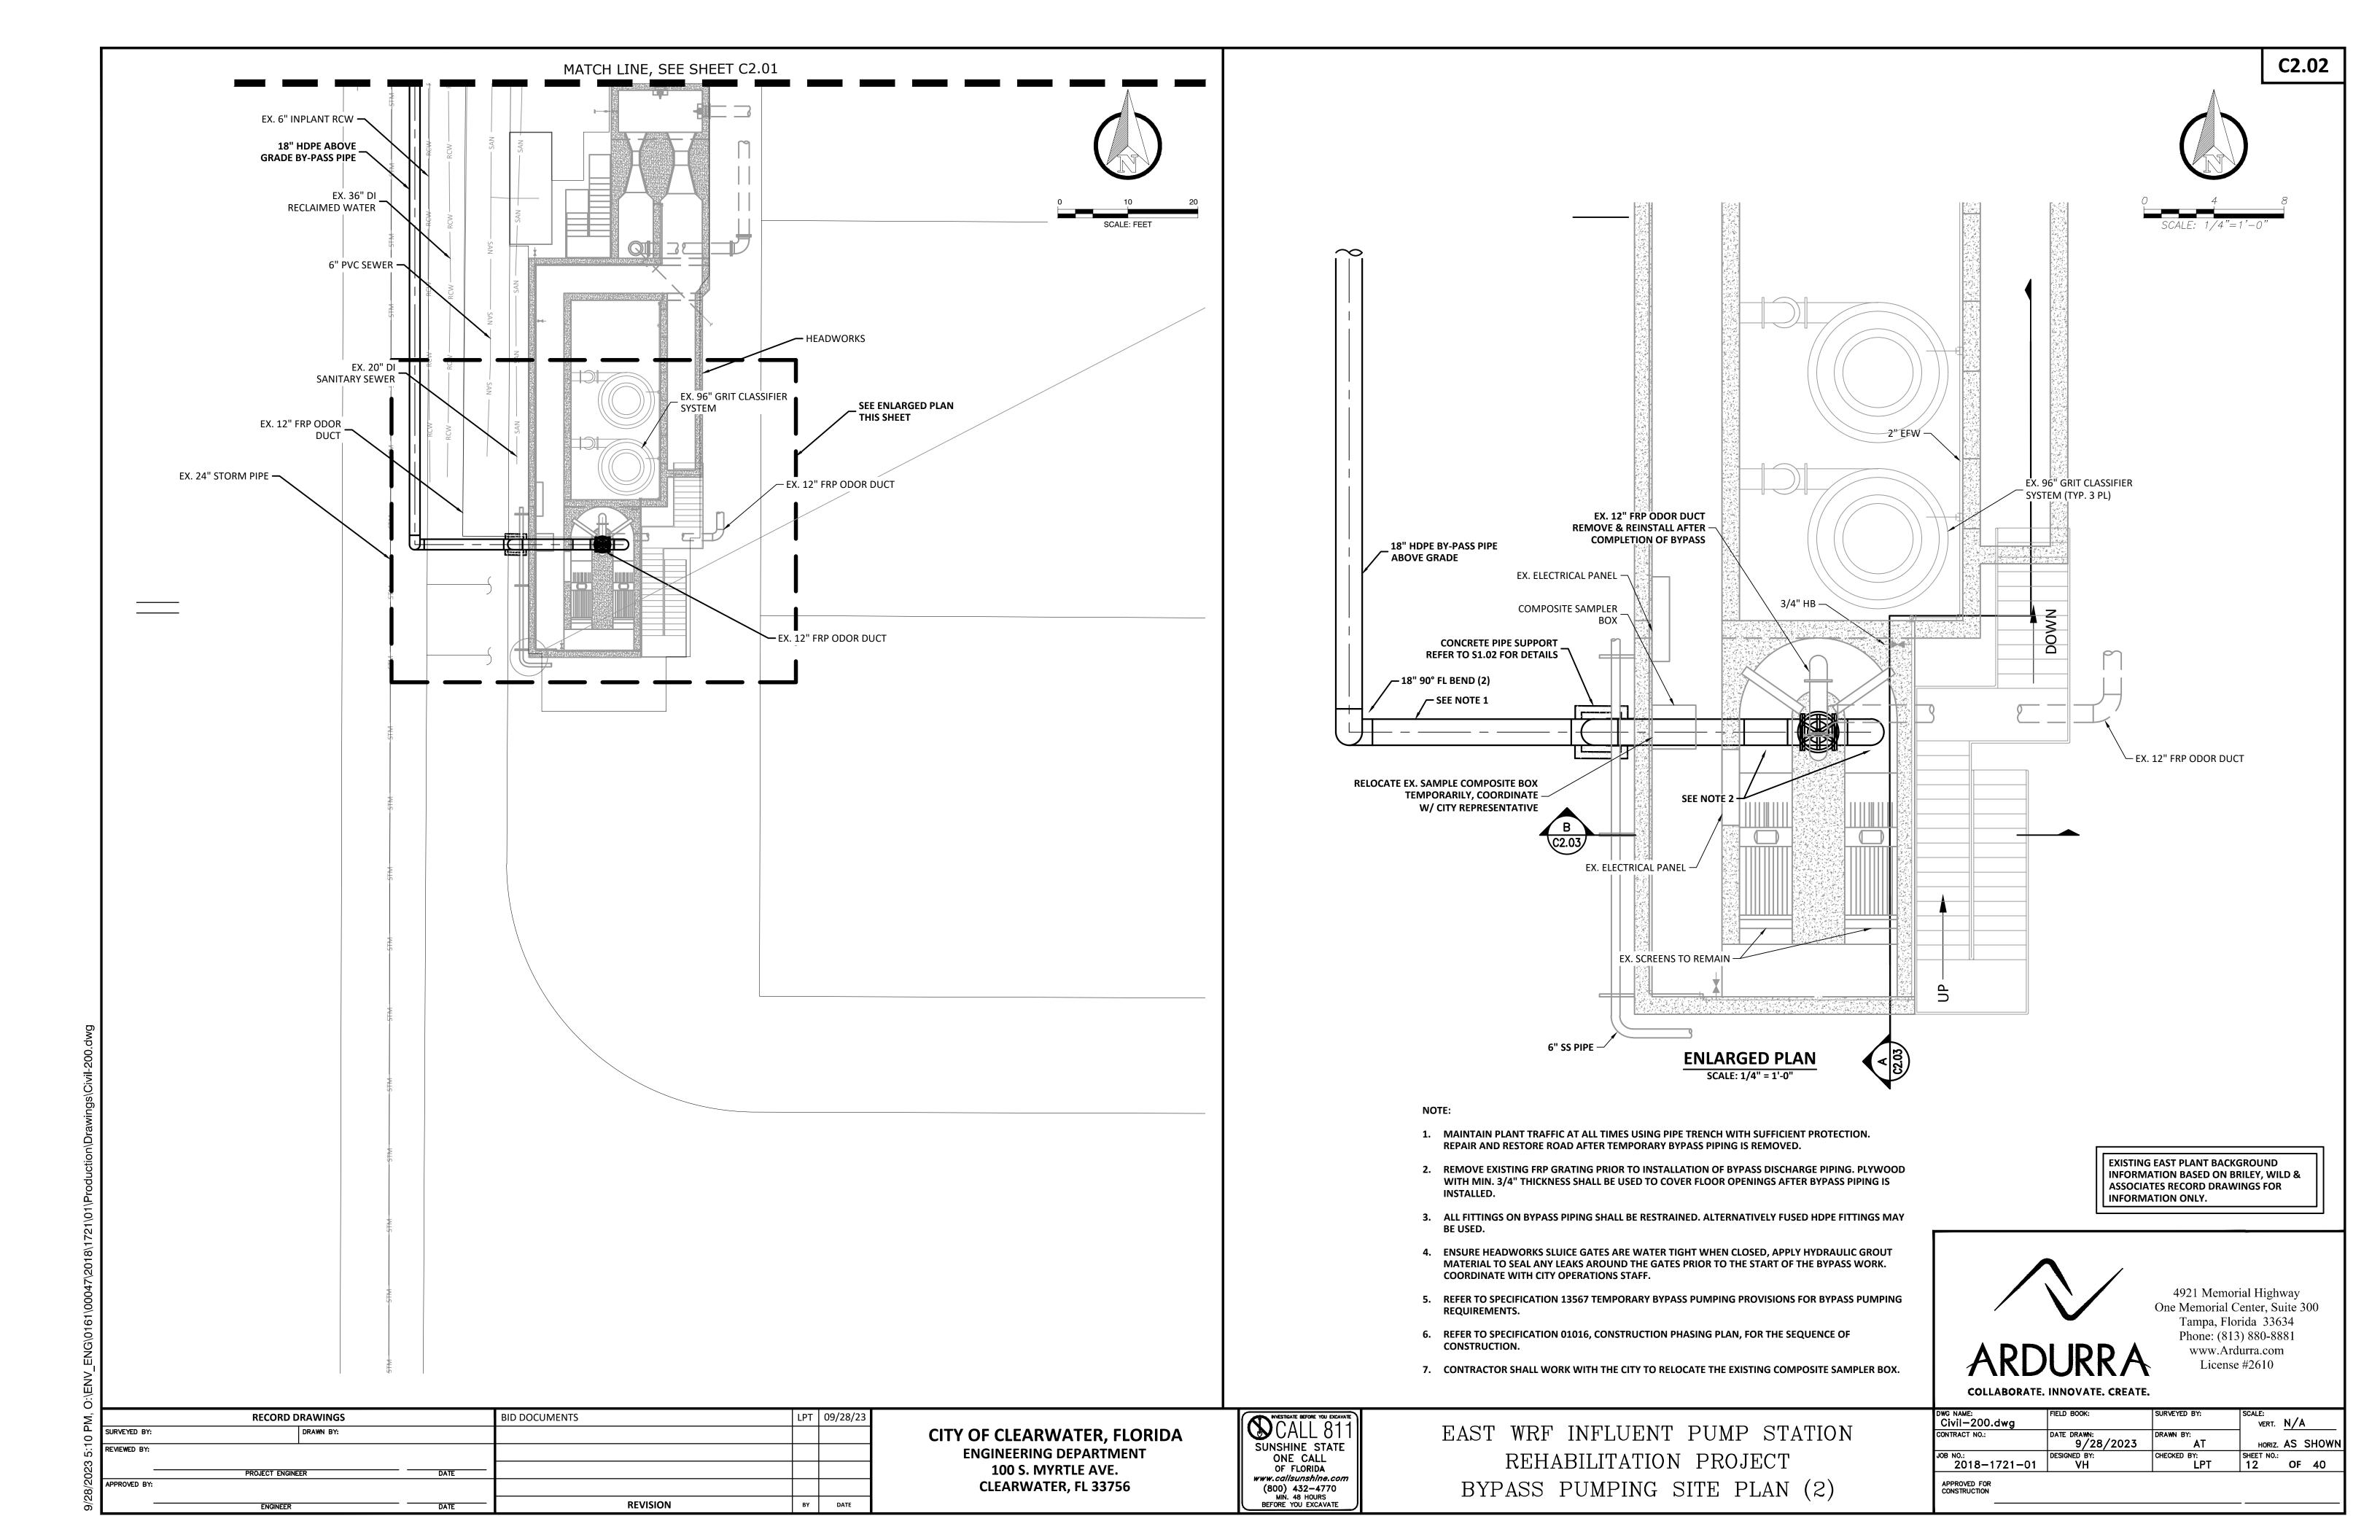
EAST WRF INFLUENT PUMP STATION
REHABILITATION PROJECT
PROPOSED SITE PLAN AND YARD PIPING


MESH SIZE 20 (840 MICRON)

CONNECT TO EX. 4" PVC IN-PLANT RCW

DWG NAME: Civil-100.dwg	FIELD BOOK:	SURVEYED BY:	SCALE:  VERT. N/A
CONTRACT NO.:	DATE DRAWN: 9/28/2023	DRAWN BY:	HORIZ. AS SHOWN
JOB NO.: 2018-1721-01	DESIGNED BY:	CHECKED BY:	SHEET NO.: 10 OF 40





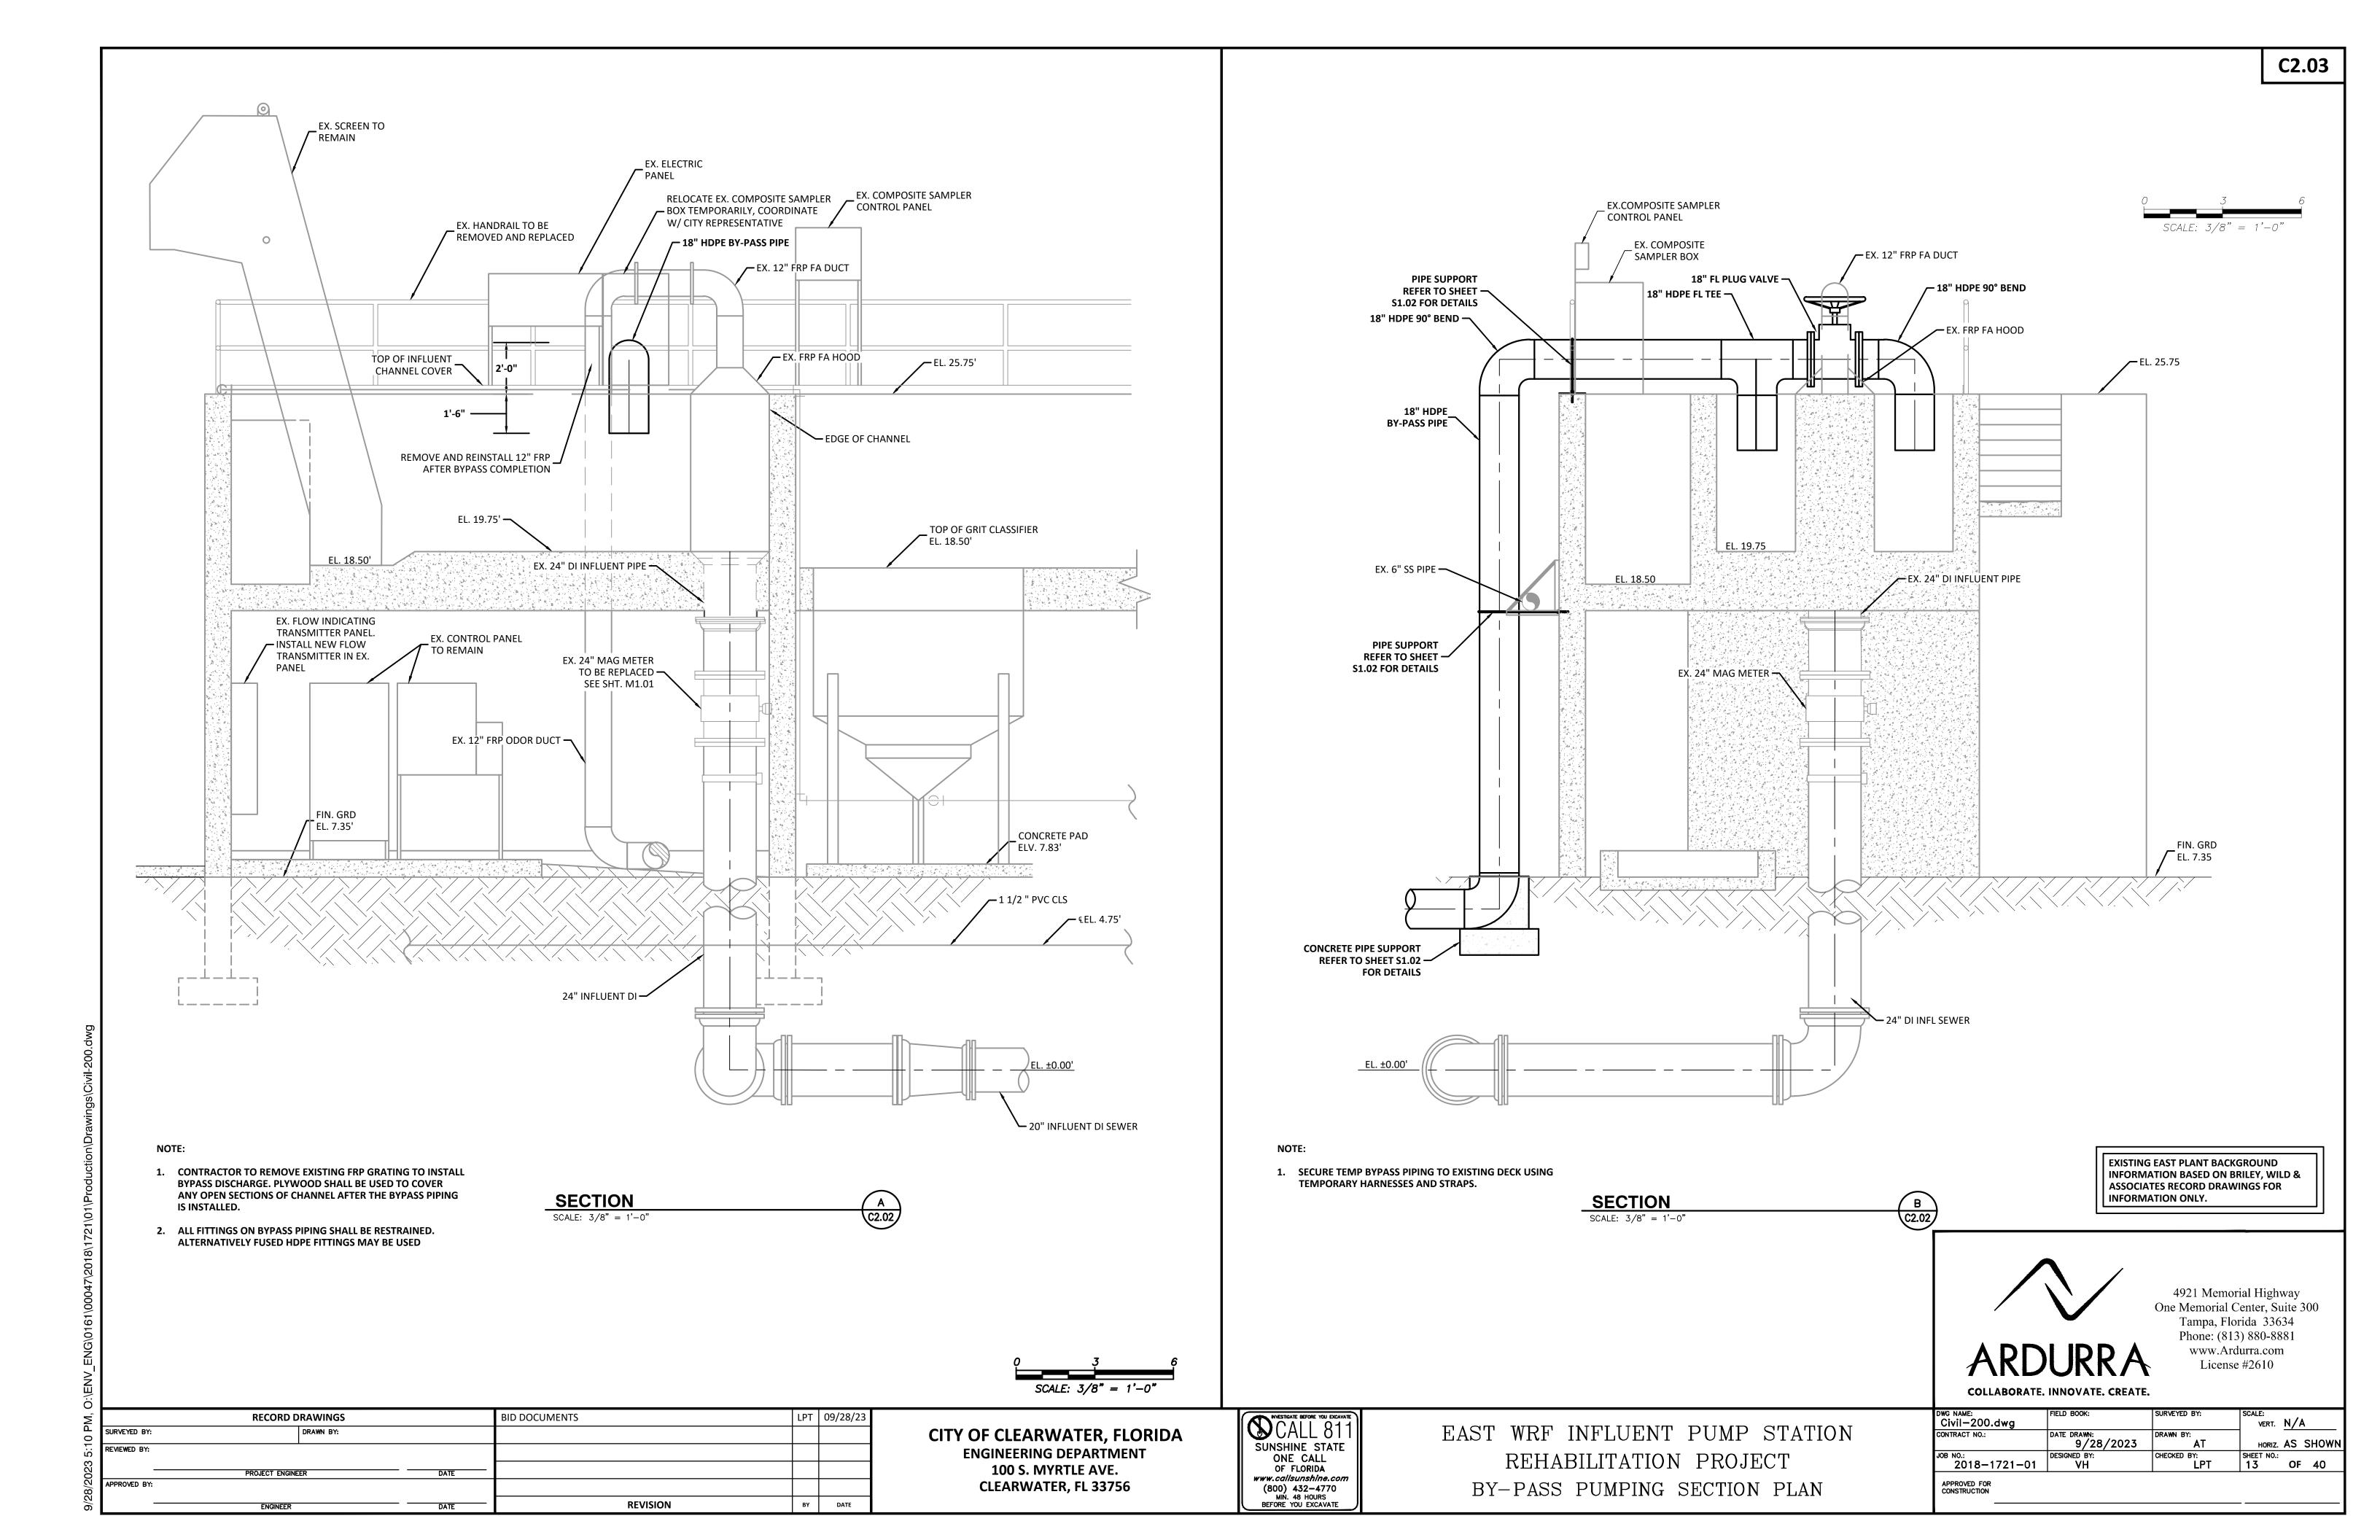

### GENERAL LANDSCAPE NOTES

- . The Landscape Contractor shall grade planting beds, as required, to provide positive drainage and promote optimum plant growth. 2. All recommended trees and plant materials will be graded as Nursery Grade No. 1 or better as outlined by the Florida Department of Agriculture and Consumer Services, Division of Plant Industry "Grades and Standards for Nursery Plants", 7th Edition, 1998 as revised
- 3. All planting shall be done in accordance with the Florida Nurserymen's and Grower's Associations approved practices.
- 4. All plants shall be fertilized with Agriform 20-10-5 tablets as per the manufacturers specifications in conjunction with note # 5. 5. The planting soil shall be the approximate proportions as follows: 50% sand and 50% organic material consisting of native peat, well—decomposed sawdust, leaf mold and top soil. It shall provide a good pliable and thoroughly mixed medium with adequate aeration, drainage and water—holding capacity. It shall also be free of all extraneous debris, such as roots, stones, weeds, etc.
- 6. All planting areas shall receive a 3" layer of recycled hardwood log mulch, which is to be watered—in after installation. 7. The plant material schedule is presented for the convenience of the Landscape Contractor. In the event of a discrepancy between
- the plan and the plant key, the plan shall prevail. 8. Plants shall meet size, container, and spacing specifications. Any material not meeting specifications shall be removed and replaced
- at the contractor's expense. 9. All tree and shrub locations are subject to change. All locations shall be approved by the City Project Manager prior to planting.
- 10. The Landscape Contractor shall be responsible for examining fully both the site and the bid documents. Discrepancies in the documents or the actual site conditions shall be reported to the City Project Manager in writing at the time of bidding or discovery. No account shall be made after contract completion for failure to report such condition, or for errors on the part of the Landscape Contractor at the time of bidding.
- 11. The Landscape Contractor shall be responsible for securing all necessary applicable permits and licenses to perform the work set
- forth in this plan set and the specifications. 12. Plant material shall be bid as specified unless unavailable, at which time the City Project Manager will be notified by telephone and
- in writing of intended changes. 13. Any and all questions concerning the plan set and/or specifications shall be directed to the City Project Manager at (727)
- 14. There shall be no additions, deletions or substitutions without the written approval of the City Project Manager.
- 15. The Landscape Contractor shall guarantee, in writing, plant survivability for a period of twelve (12) months from final acceptance by the City Project Manager.
- 16. All dimensions to be field—checked by the Landscape Contractor prior to landscape material installation. Discrepancies shall be reported immediately to the City Project Manager.
- 17. All materials must be as specified on the landscape plan. If materials or labor do not adhere to specifications, they will be rejected by the City Project Manager with proper installation carried out by Landscape Contractor at no additional cost.
- 18. All permits necessary are to be provided by the installing contractor unless otherwise specifically stated in the specifications.
- 19. No contractor identification signs shall be permitted on the project, except for the project information signs.
- 20. Existing sod shall be removed as necessary to accompdate new plantings.
- 21. Any existing sod areas that are unnecessarily disturbed during the landscape installation shall be resodded to match existing.
- 22. The Landscape Contractor will be responsible for the collection, removal, and proper disposal of any and all debris generated during the installation of this project.

CITY OF CLEARWATER NDEX NO. PAGE NO. GENERAL LANDSCAPING 906 1 of 3 5/17/12 | DEPARTMENT NAME LANDSCAPE NOTES LATEST 2/22/2016 DATE REVISION DESCRIPTION **DETAILS** 

### FERTILIZATION NOTES

#### SHRUBS AND TREES

All trees and shrubs shall be fertilized with "Agriform" 20-15-5 planting tablets at time of installation and prior to completion of pit backfilling. Tablets shall be placed uniformly around the root mass at a depth that is between the middle and bottom of the root mass.

#### APPLICATION RATE:


1 Gallon can: 1 — 21 gram tablet 3 Gallon can: 2 - 21 gram tablets 5 Gallon can: 3 - 21 gram tablets 7 Gallon can: 4 - 21 gram tablets


Trees: 3 - 21 gram tablets each 1/2" of caliper 7 — 21 gram tablets Palms:

#### **GROUNDCOVER AREAS**

All groundcover areas shall receive fertilization with "Ozmocote" time release fertilizer as per manufacturer's specifications.

CITY OF CLEARWATER INDEX NO. PAGE NO. **FERTILIZATION** ENGINEERING DEPARTMENT 906 3 of 3 5/17/12 DEPARTMENT NAME LANDSCAPE NOTES LATEST 2/22/2016 DATE REVISION DESCRIPTION DETAILS

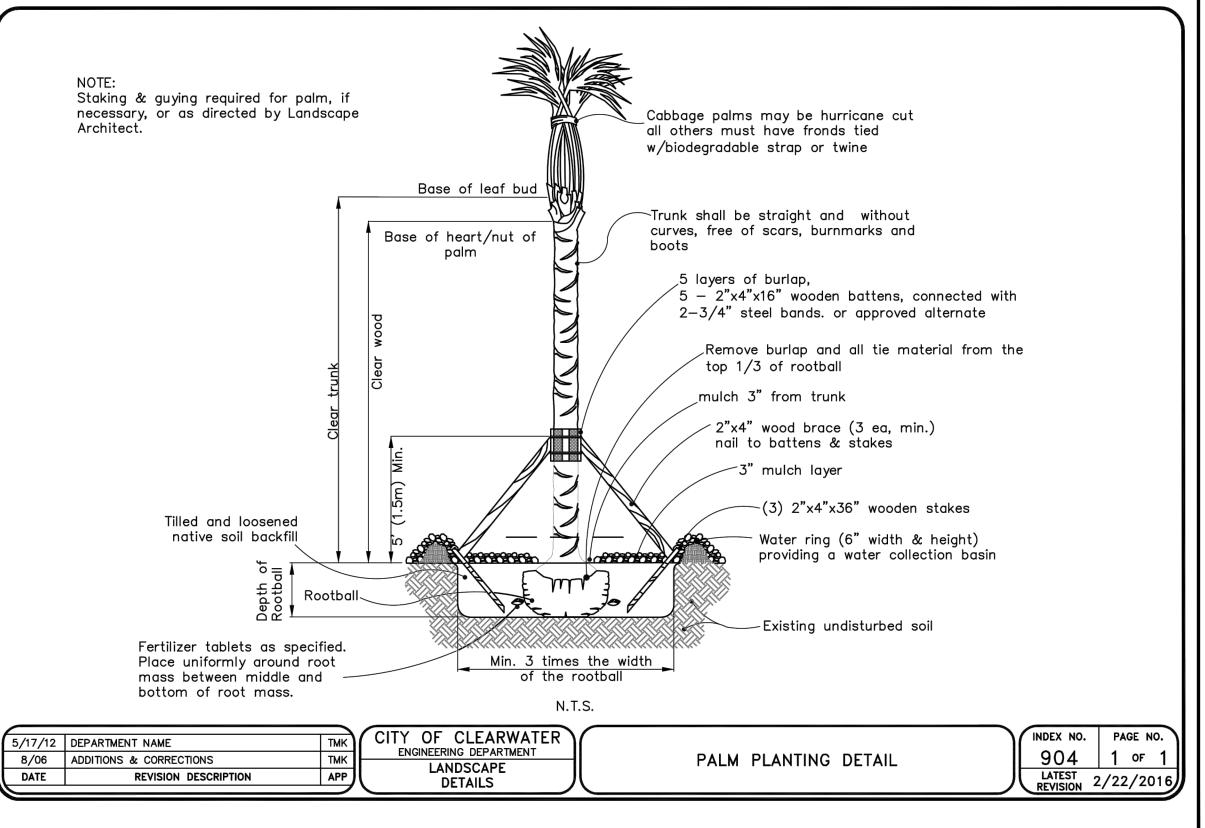

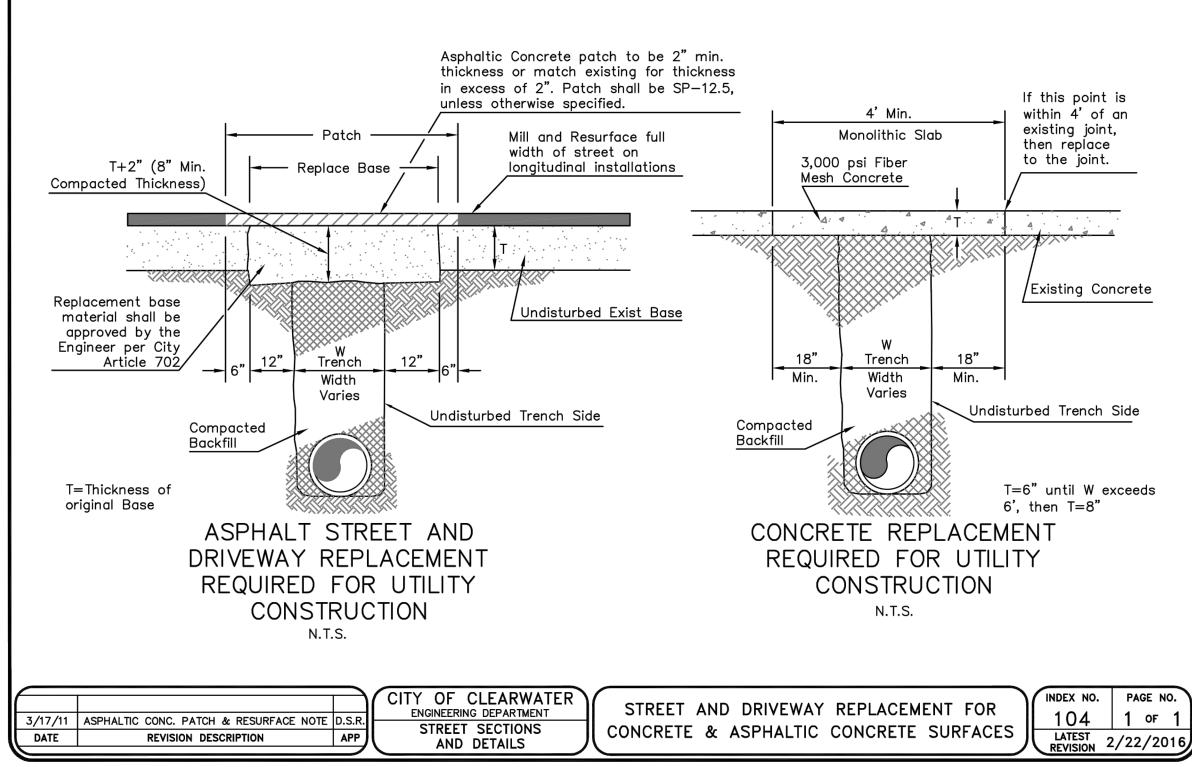



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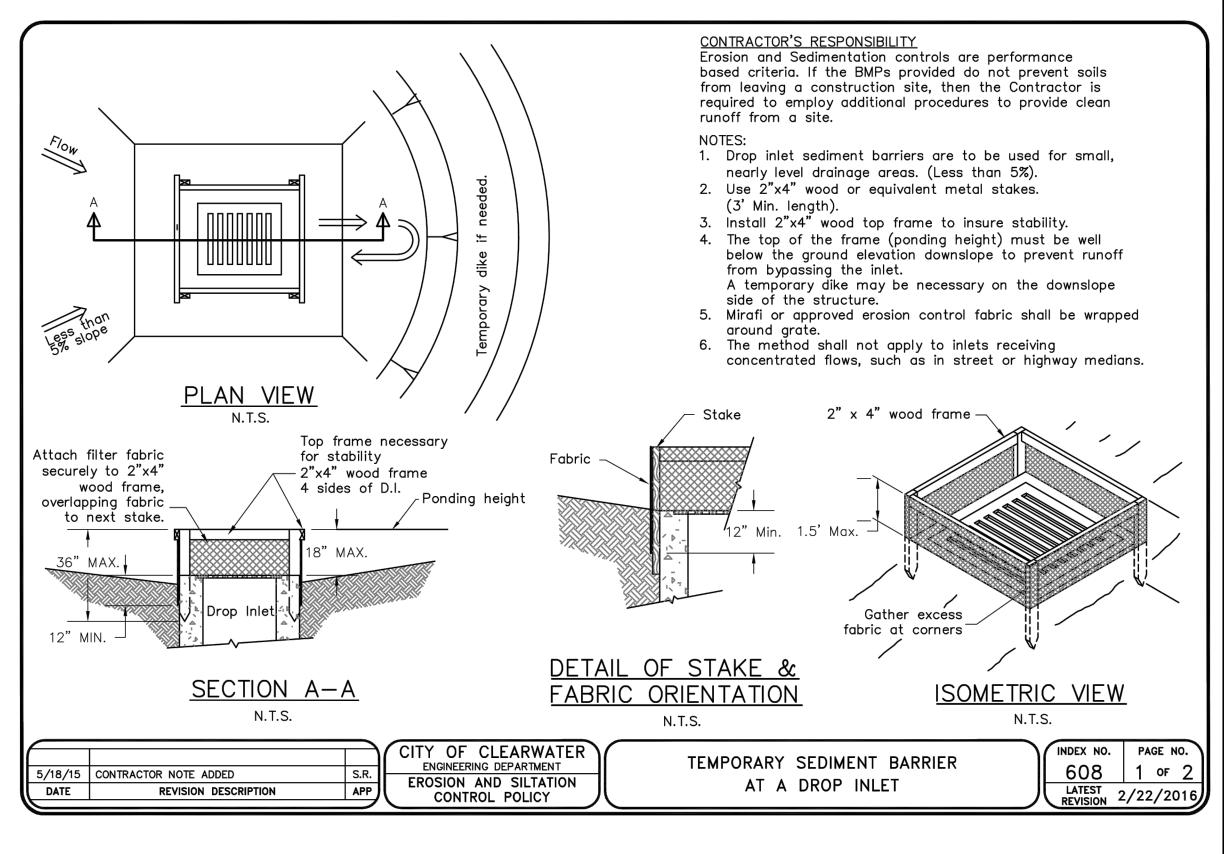
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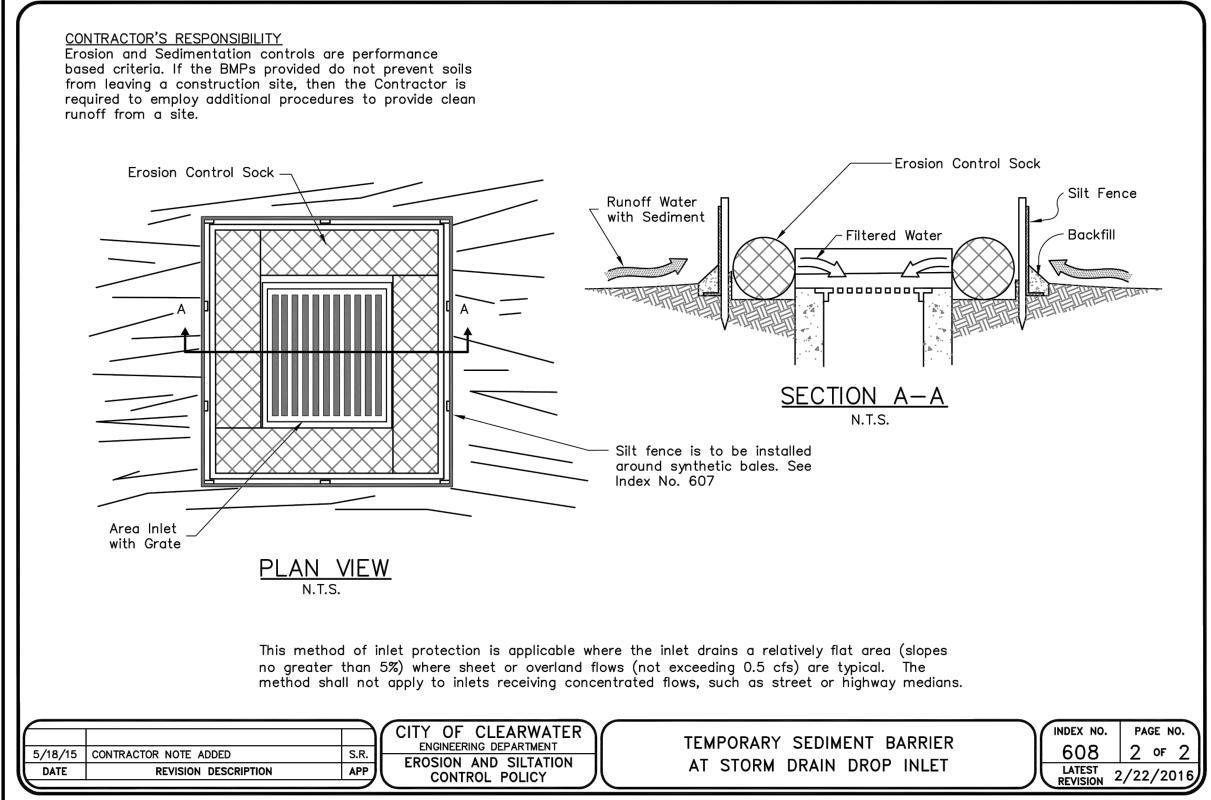
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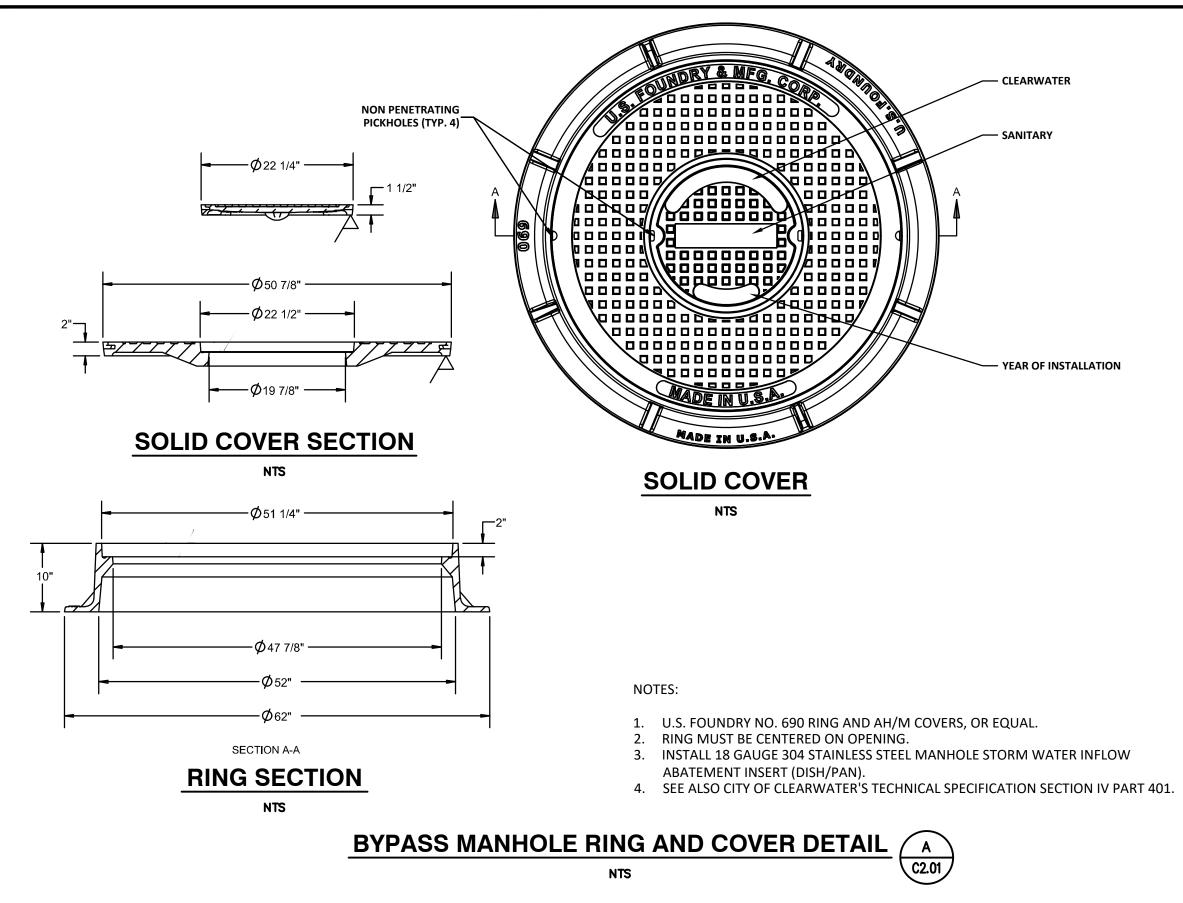
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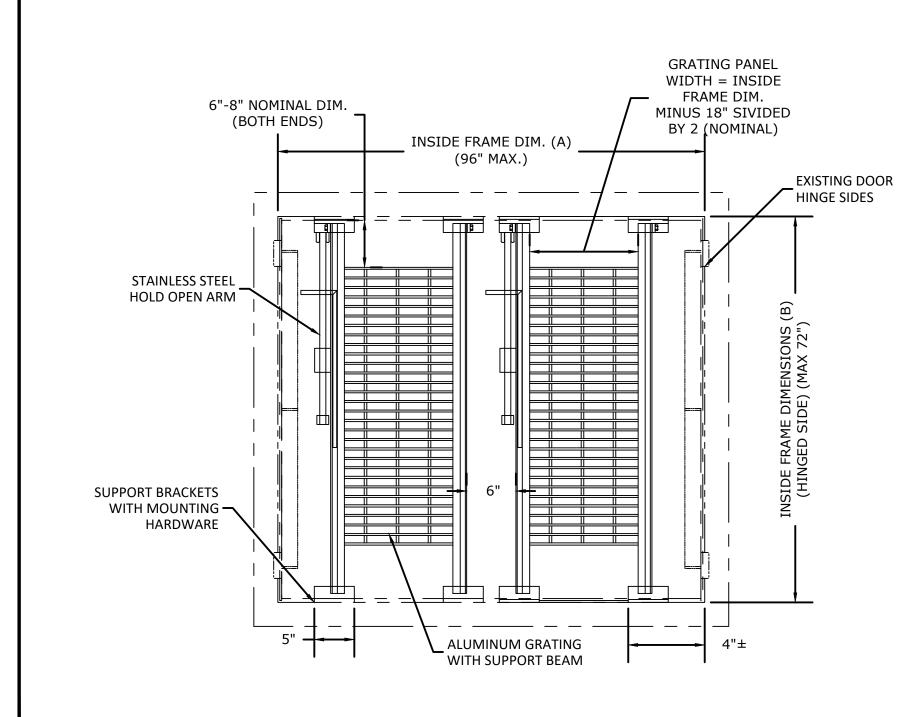
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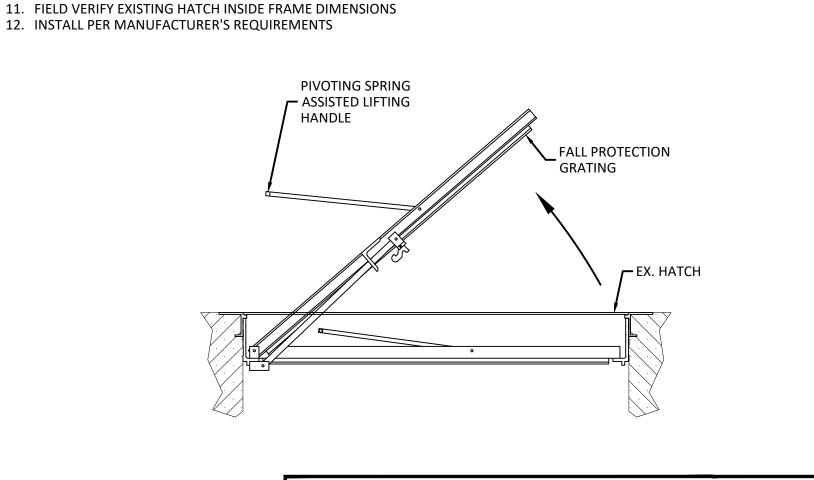
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CONTRACT NO.:	DATE DRAWN: 9/28/2023	DRAWN BY:	HORIZ. AS SHOV
JOB NO.: 2018-1721-01	DESIGNED BY: VH	CHECKED BY: LPT	SHEET NO.: 14 <b>OF</b> 40













NOTES:

1. HALIDAY SERIES X RETRO-GRATING OR APPROVED EQUAL

7. HINGED WITH POSITIVE LATCH TO MAINTAIN UPRIGHT POSITION

8. VIEWING AREA FOR OBSERVATION AND LIMITED MAINTENANCE

9. SUPPLIED WITH T-316 STAINLESS STEEL MOUNTING HARDWARE

ALUMINUM "I" BAR CONSTRUCTION
 T-316 STAINLESS STEEL HARDWARE

5. LOCKABLE WITH OWNER SUPPLIED PADLOCK

10. SAFETY ORANGE POWDER COATING FINISH

4. SPRING LOADED LIFTING HANDLE

6. 300 LBS. PER SQ. FT. LOAD RATING




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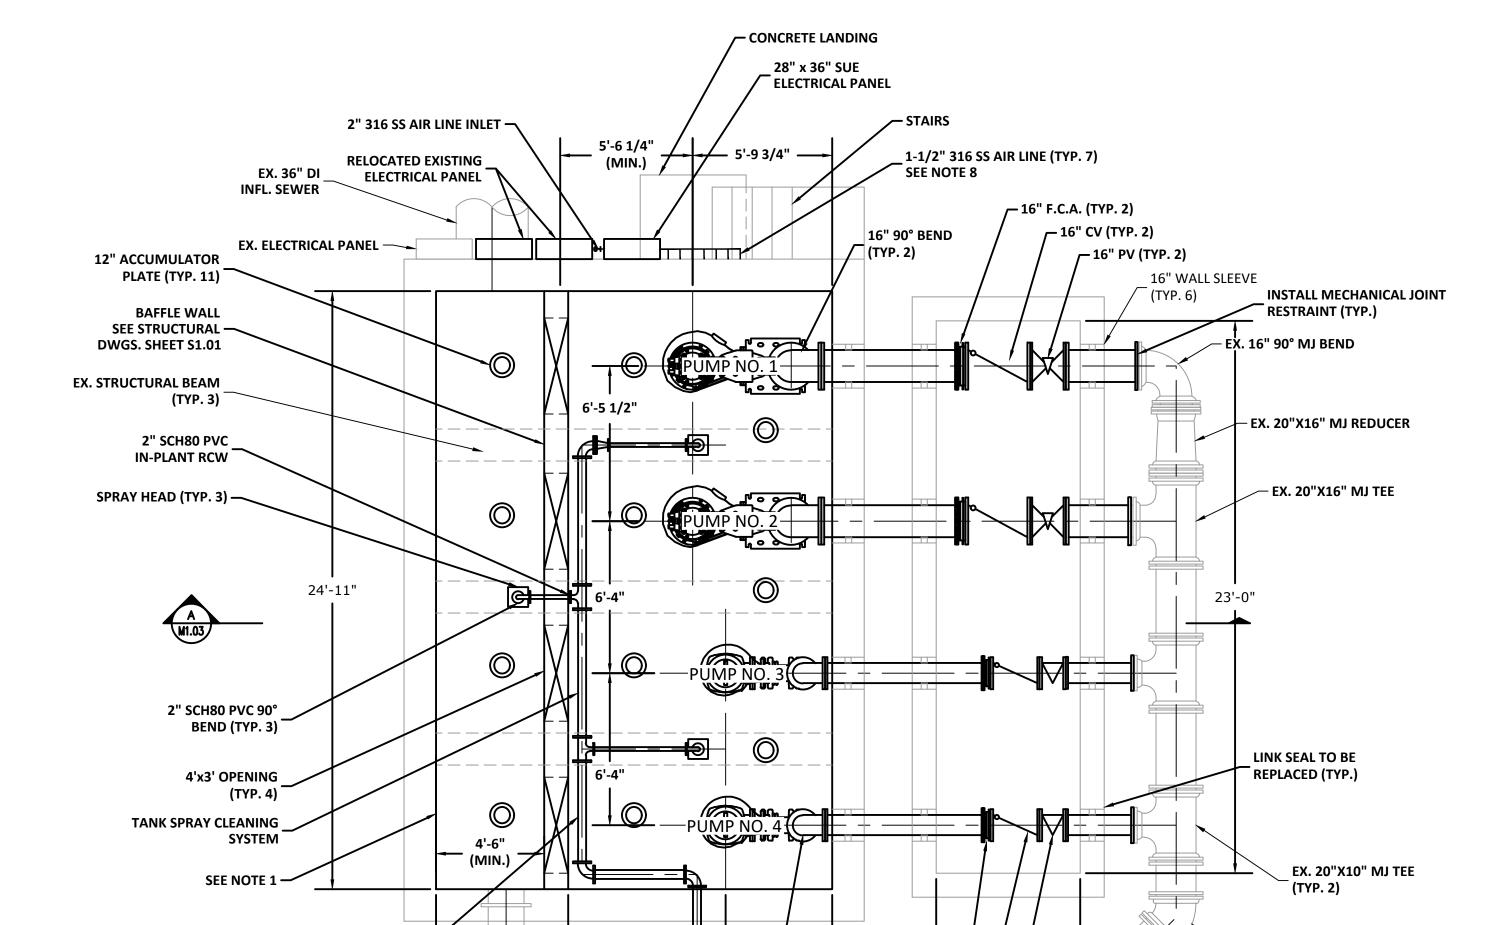
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	9/28/2023 DESIGNED BY:	9/28/2023 AT DESIGNED BY: CHECKED BY:







SEE NOTE 9 10" 90 BEND

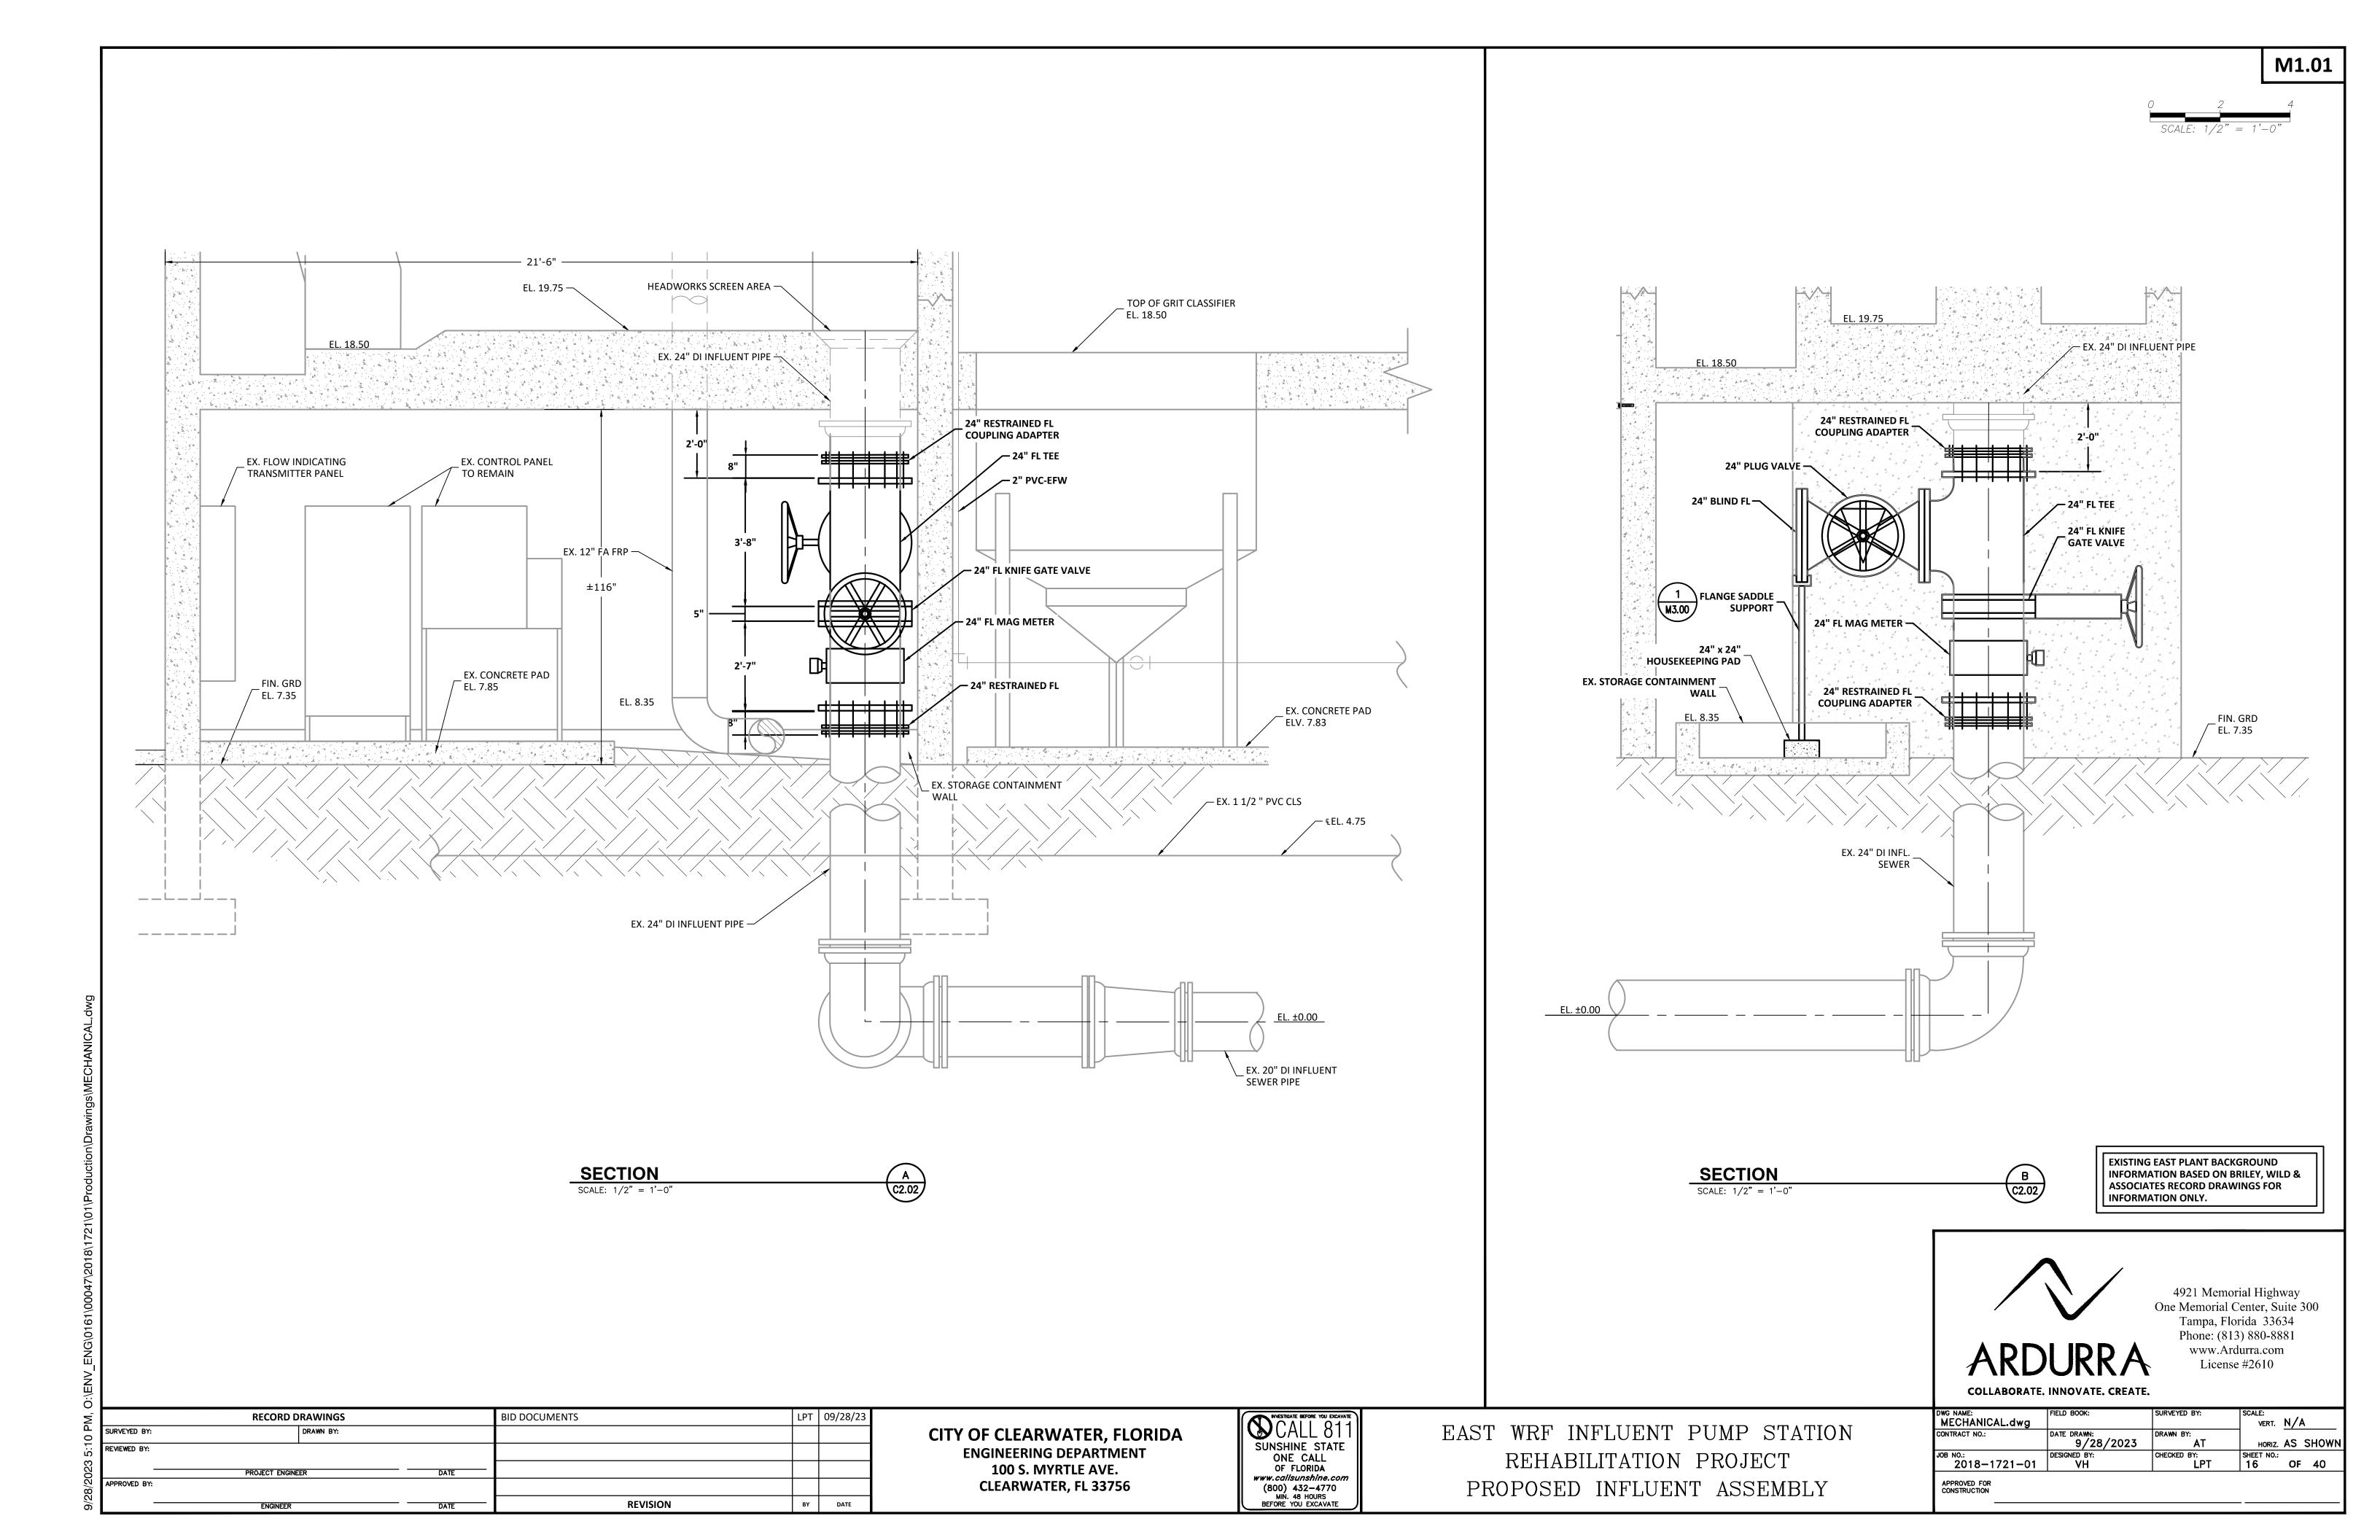4" SCH80 PVC RCW -

EX. 18" SS TO ODOR CONTROL SYSTEM

APPROVED BY:

- CONCRETE LANDING 28" x 36" SUE ELECTRICAL PANEL 1-1/2" 316 SS AIR LINE (TYP. 7) SEE NOTE 8 2" 316 SS AIR LINE -RELOCATED EXISTING FALL PROTECTION A **ELECTRICAL PANEL** GRATING (TYP. 4) EX. ELECTRICAL PANELS —— SEE NOTE 2 22"x22" 316 SS **DIAMOND PLATE COVER GENERAL LOCATION OF —** ELECTRICAL EQUIPMENT. **SEE SHEET EX.XX FOR DETAILS** 24" FRP **180° GOOSENECK** W/ INSECT SCREEN **SEE NOTE 10** SEE NOTE 11 -SEE NOTE 4 — **EX. STRUCTURAL BEAM** (TYP. 3) <del>-----</del> - DIAMOND PLATE EX. 18" SS TO ODOR \_ **CONTROL SYSTEM** 

TOP SLAB PLAN

SCALE: 1/4"=1'-0"

**BELOW TOP SLAB PLAN** 

10" FCA (TYP. 2) -

10" CV (TYP. 2)

10" PV (TYP. 2) –

DATE

SCALE: 1/4"=1'-0"

- 1. CONTRACTOR SHALL CLEAN AND REPAIR EXISTING CONCRETE SURFACE IN WET WELL, PRIOR TO APPLICATION OF CONCRETE COATING/LINER. COATING SHALL BE SPRAY ROC OR RAUEN 405.
- 2. CONTRACTOR SHALL INSTALL FALL PROTECTION GRATINGS UNDER (4) EXISTING WET WELL HATCH COVERS.
- 3. CONTRACTOR SHALL INSTALL LINK SEALS AT ALL WALL PENETRATIONS.
- 4. REPLACE EX. ULTRASONIC LEVEL SENSOR WITH NEW RADAR LEVEL DETECTOR, INCLUDING THE NEMA 3X ENCLOSURE WITH A LOCK. CONTRACTOR SHALL COORDINATE THE EXACT LOCATION OF AIR PIPING TO ALLOW RADAR LEVEL SENSOR TO PROPOSE FUNCTION.
- 5. ALL HARDWARE FOR FLANGED AIR PIPE AND FITTINGS SHALL BE 316 STAINLESS STEEL. ALL HARDWARE FOR TANK SPRAY CLEANING SYSTEM, INCLUDING PIPE AND FITTINGS SHALL BE SCH 80 PVC INSIDE THE WET WELL.
- 6. TANK SPRAY CLEANING SYSTEM SPRAY HEAD SHOULD BE MANUFACTURED BY SPRAYING SYSTEMS CO. MODEL TANKJET 180, OR APPROVED EQUAL.
- 7. CONTRACTOR SHALL INSTALL 316 S.S. PIPE SUPPORTS TO SECURE THE 316 S.S. AIRLINES AND THE TANK SPRAY CLEANING SYSTEM TO THE WET WELL BEAMS AND WALLS. INSTALL PIPE SUPPORTS 4' ON CENTER AND AT FITTINGS.
- 8. CONTRACTOR TO MAINTAIN MINIMUM 3" SEPARATION BETWEEN THE (7) 1-1/2" 316 SS AIR LINES. REFER TO SHEET S1.01 FOR PIPE WALL PENETRATION DETAILS.
- 9. CONTRACTOR SHALL COORDINATE PIPE WALL PENETRATION LOCATION WITH C2.00.
- 10. CONTRACTOR SHALL COORDINATE WITH S1.01 FOR 24" FRP GOOSENECK CORING LOCATION. GPR THE TOP SLAB PRIOR TO CORING HOLE TO CENTER BETWEEN THE SLAB REINFORCEMENT.
- 11. CONTRACTOR SHALL REMOVE THE EX. ULTRASONIC LEVEL SENSOR, THE EX. NEM 3X ENCLOSURE TO REMAIN IN PLACE.
- 12. ALL PUMP DISCHARGE PIPING AND FITTINGS SHALL BE DIP.

EXISTING EAST PLANT BACKGROUND INFORMATION BASED ON BRILEY, WILD & ASSOCIATES RECORD DRAWINGS FOR INFORMATION ONLY.



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— EX. 20" 45° MJ BEND

**NOTES:** 


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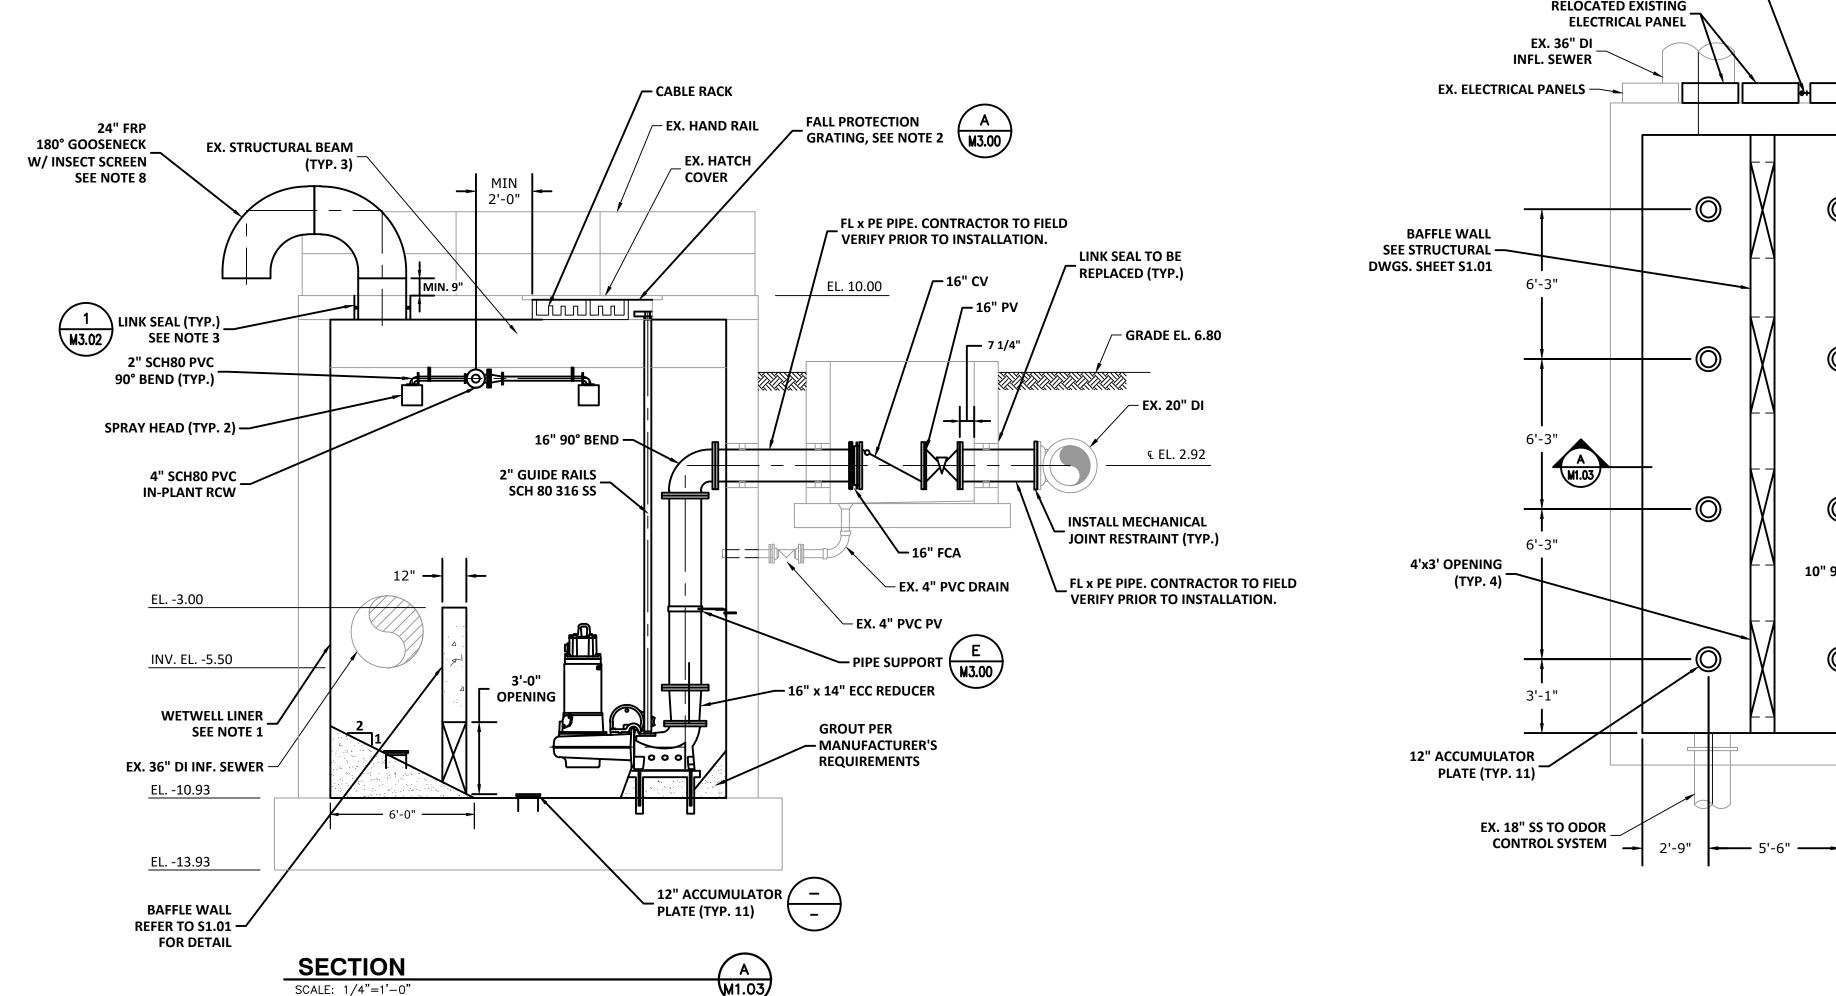
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CONTRACT NO.:	DATE DRAWN: 9/28/2023	DRAWN BY:	HORIZ.	AS	SHOWN
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\_ 28" x 36" SUE ELECTRICAL PANEL 2" 316 SS AIR LINE — 1-1/2" 316 SS AIR LINE (TYP. 7) SEE NOTE 7 RELOCATED EXISTING \_\_ 16" F.C.A. (TYP. 2) - 16" CV (TYP. 2) 16" 90° BEND (TYP. 2) \_\_ 16" PV (TYP. 2) 16" WALL SLEEVE INSTALL MECHANICAL JOINT RESTRAINT (TYP.) EX. 16" 90° MJ BEND EX. 20"X16" REDUCER – 20"X16" MJ 10" 90° BEND (TYP. 2) LINK SEAL TO BE REPLACED (TYP.) 5'-9 1/2" -PUMP NO EX. 20"X10" MJ TEE \_ (TYP. 2) 10" FCA (TYP. 2) — 10" CV (TYP. 2) — 10" PV (TYP. 2) -EX. 20" DI TO - INFLUENT STRUCTURE

WET WELL BOTTOM PLAN

SCALE: 1/4"=1'-0"

NOTES:

- 1. CONTRACTOR SHALL CLEAN AND REPAIR EXISTING CONCRETE SURFACE IN WET WELL, PRIOR TO APPLICATION OF CONCRETE COATING/LINER. COATING SHALL BE SPRAY ROC OR RAUEN 405.
- 2. CONTRACTOR SHALL INSTALL FALL PROTECTION GRATINGS UNDER (4) EXISTING WET WELL HATCH COVERS.
- 3. CONTRACTOR SHALL INSTALL LINK SEALS AT ALL WALL PENETRATIONS.
- 4. ALL HARDWARE FOR FLANGED AIR PIPE AND FITTINGS SHALL BE 316 STAINLESS STEEL. ALL HARDWARE FOR TANK SPRAY CLEANING SYSTEM, INCLUDING PIPE AND FITTINGS SHALL BE SCH 80 PVC INSIDE THE WET WELL.
- 5. TANK SPRAY CLEANING SYSTEM, SPRAY HEAD SHOULD BE MANUFACTURED BY SPRAYING SYSTEMS CO. MODEL TANKJET 180, OR APPROVED EQUAL.
- 6. CONTRACTOR SHALL INSTALL 316 S.S. PIPE SUPPORTS TO SECURE THE 316 S.S. AIRLINES AND THE TANK SPRAY CLEANING SYSTEM TO THE WET WELL BEAMS AND WALLS. INSTALL PIPE SUPPORTS 4' ON CENTER AND AT FITTINGS.
- 7. CONTRACTOR TO MAINTAIN MINIMUM 3" SEPARATION BETWEEN THE (7) 1-1/2" 316 SS AIR LINES. REFER TO SHEET S1.01 FOR PIPE WALL PENETRATION DETAILS.
- 8. CONTRACTOR SHALL COORDINATE WITH S1.01 FOR 24" FRP GOOSENECK CORING LOCATION. GPR THE TOP SLAB PRIOR TO CORING HOLE TO CENTER BETWEEN THE SLAB REINFORCEMENT.
- 9. ALL PUMP DISCHARGE PIPING AND FITTINGS SHALL BE DIP.

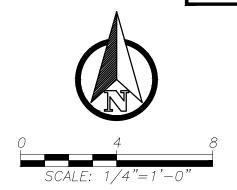EXISTING EAST PLANT BACKGROUND INFORMATION BASED ON BRILEY, WILD & ASSOCIATES RECORD DRAWINGS FOR INFORMATION ONLY.



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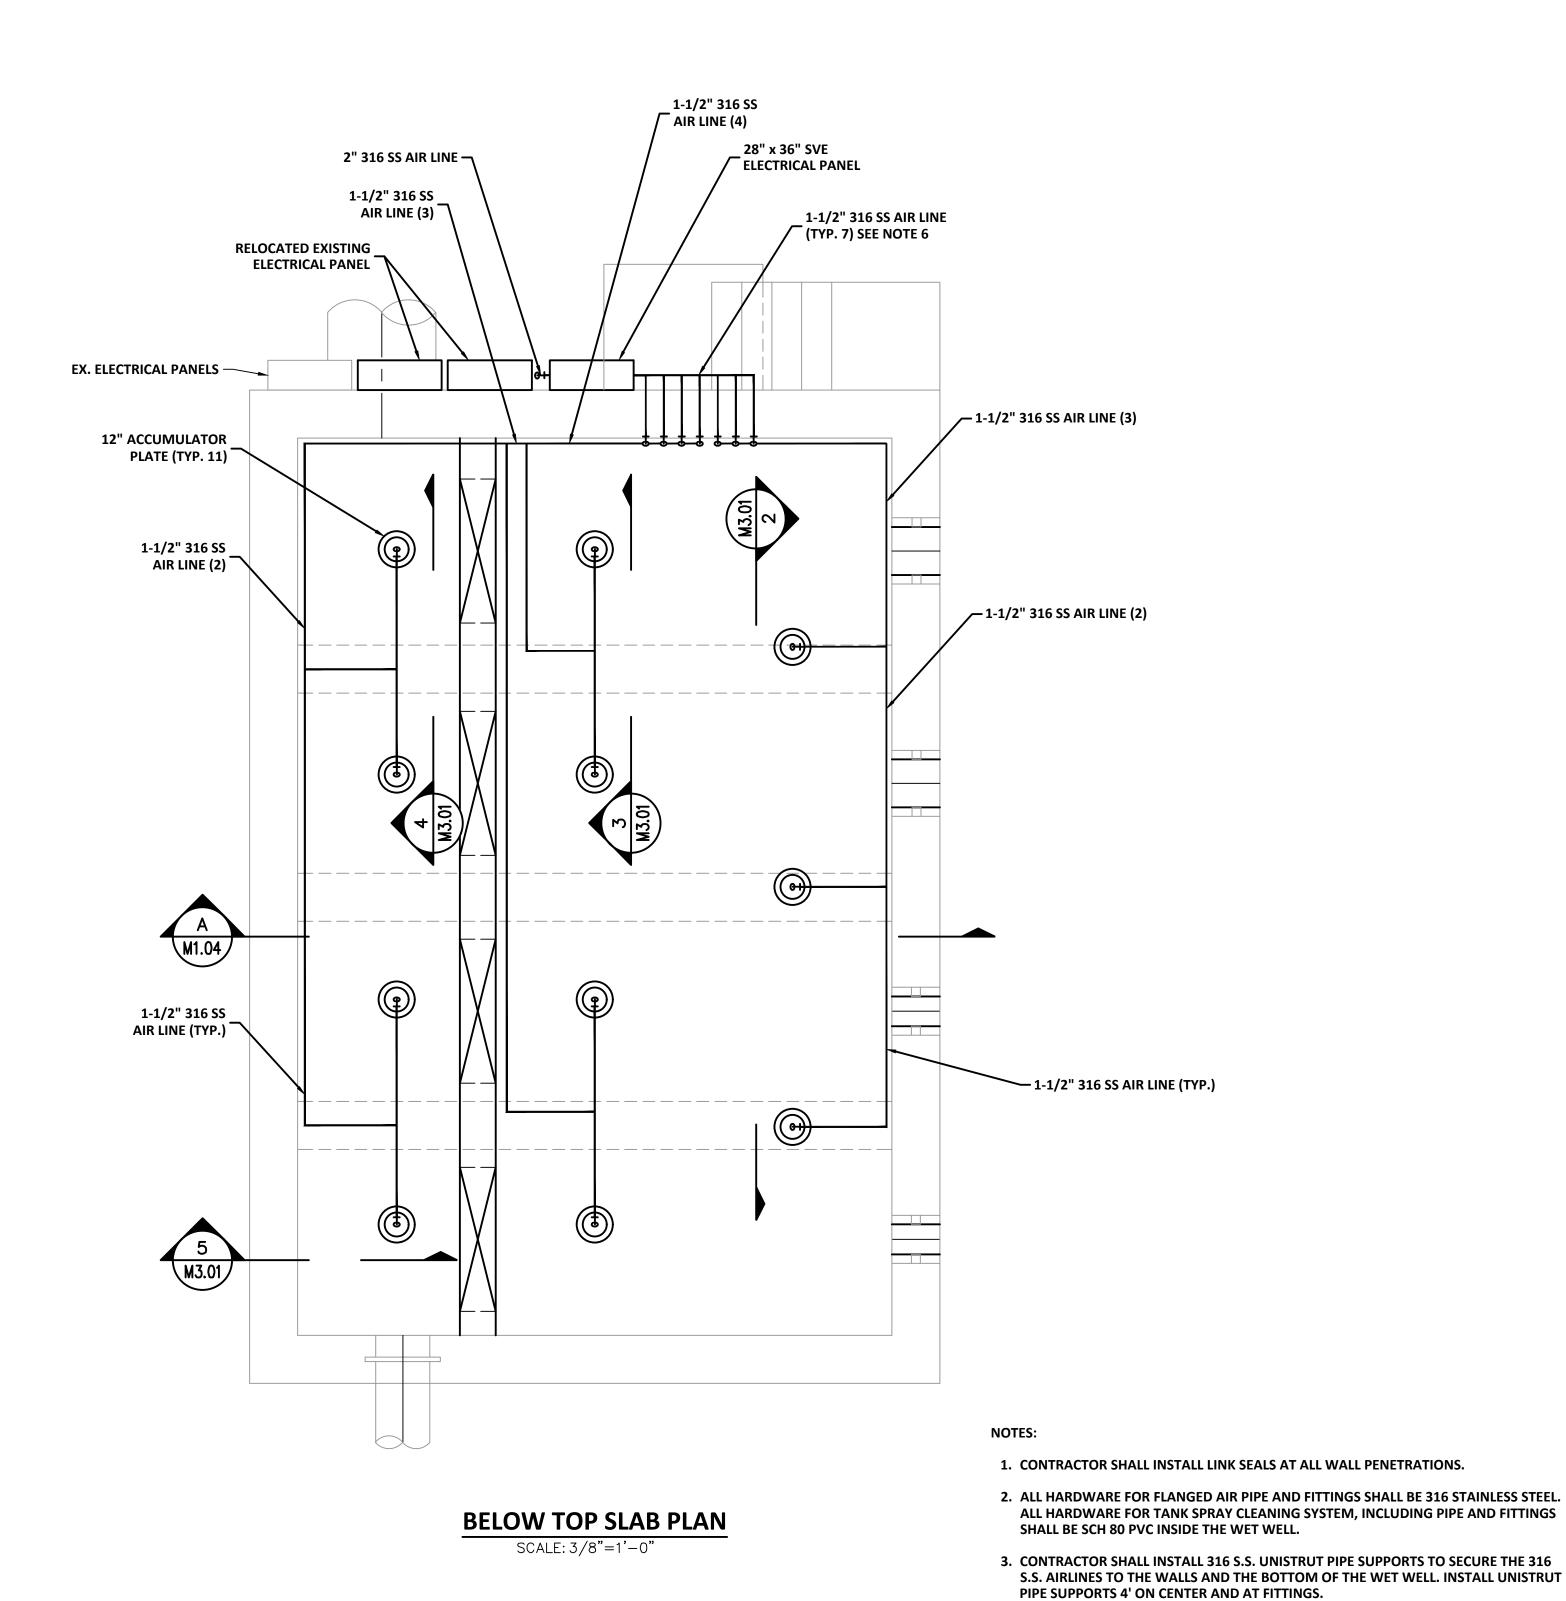
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CONTRACT NO.:	DATE DRAWN:	DRAWN BY:		•	
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JOB NO.:	DESIGNED BY:	CHECKED BY:	SHEET NO.:		
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EX. HATCH WITH NEW FALL PROTECTION GRATING 24" FRP 180° GOOSENECK W/ INSECT SCREEN ¬ **SEE NOTE 7** / LINK SEAL SEE NOTE 4 EL. 10.00 **1-1/2" 316 SS AIR LINE (TYP.)** EL. -3.00 1-1/2" 316 SS INV. EL. -5.50 **7** 90° BEND (TYP.) EX. 36" DI INF SEWER —

> SECTION M1.04 SCALE: 3/8"=1'-0"

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**─** 1-1/2" 316 SS AIR LINE (2)



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M1.04

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EAST WRF INFLUENT PUMP STATION REHABILITATION PROJECT PROPOSED LARGE BUBBLE MIXING SYSTEM LAYOUT SCHEMATIC

**BAFFLE WALL REFER** TO S1.01 FOR DETAIL

5 12" ACCUMULATOR PLATE (TYP. 11)

EL. -10.93

EL. -13.93

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DATE

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4. CONTRACTOR TO MAINTAIN MINIMUM 3" SEPARATION BETWEEN THE (7) 1-1/2" 316


5. CONTRACTOR SHALL MAINTAIN MINIMUM 3" SPACING BETWEEN THE 1-1/2" 316 SS AIR LINE, WHEN INSTALLING TO THE WALLS AND THE BOTTOM OF THE WET WELL.

6. THE AIR LINE PIPE LAYOUT INSIDE THE WET WELL IS FOR SCHEMATIC ONLY, NOT DRAWN TO SCALE. CONTRACTOR SHALL COORDINATE AIR PIPING LAYOUT WITH M1.03


LOCATION. GPR THE TOP SLAB PRIOR TO CORING HOLE TO CENTER BETWEEN THE SLAB

7. CONTRACTOR SHALL COORDINATE WITH \$1.01 FOR 24" FRP GOOSENECK CORING

SS AIR LINES. REFER TO SHEET S1.01 FOR PIPE WALL PENETRATION DETAILS.

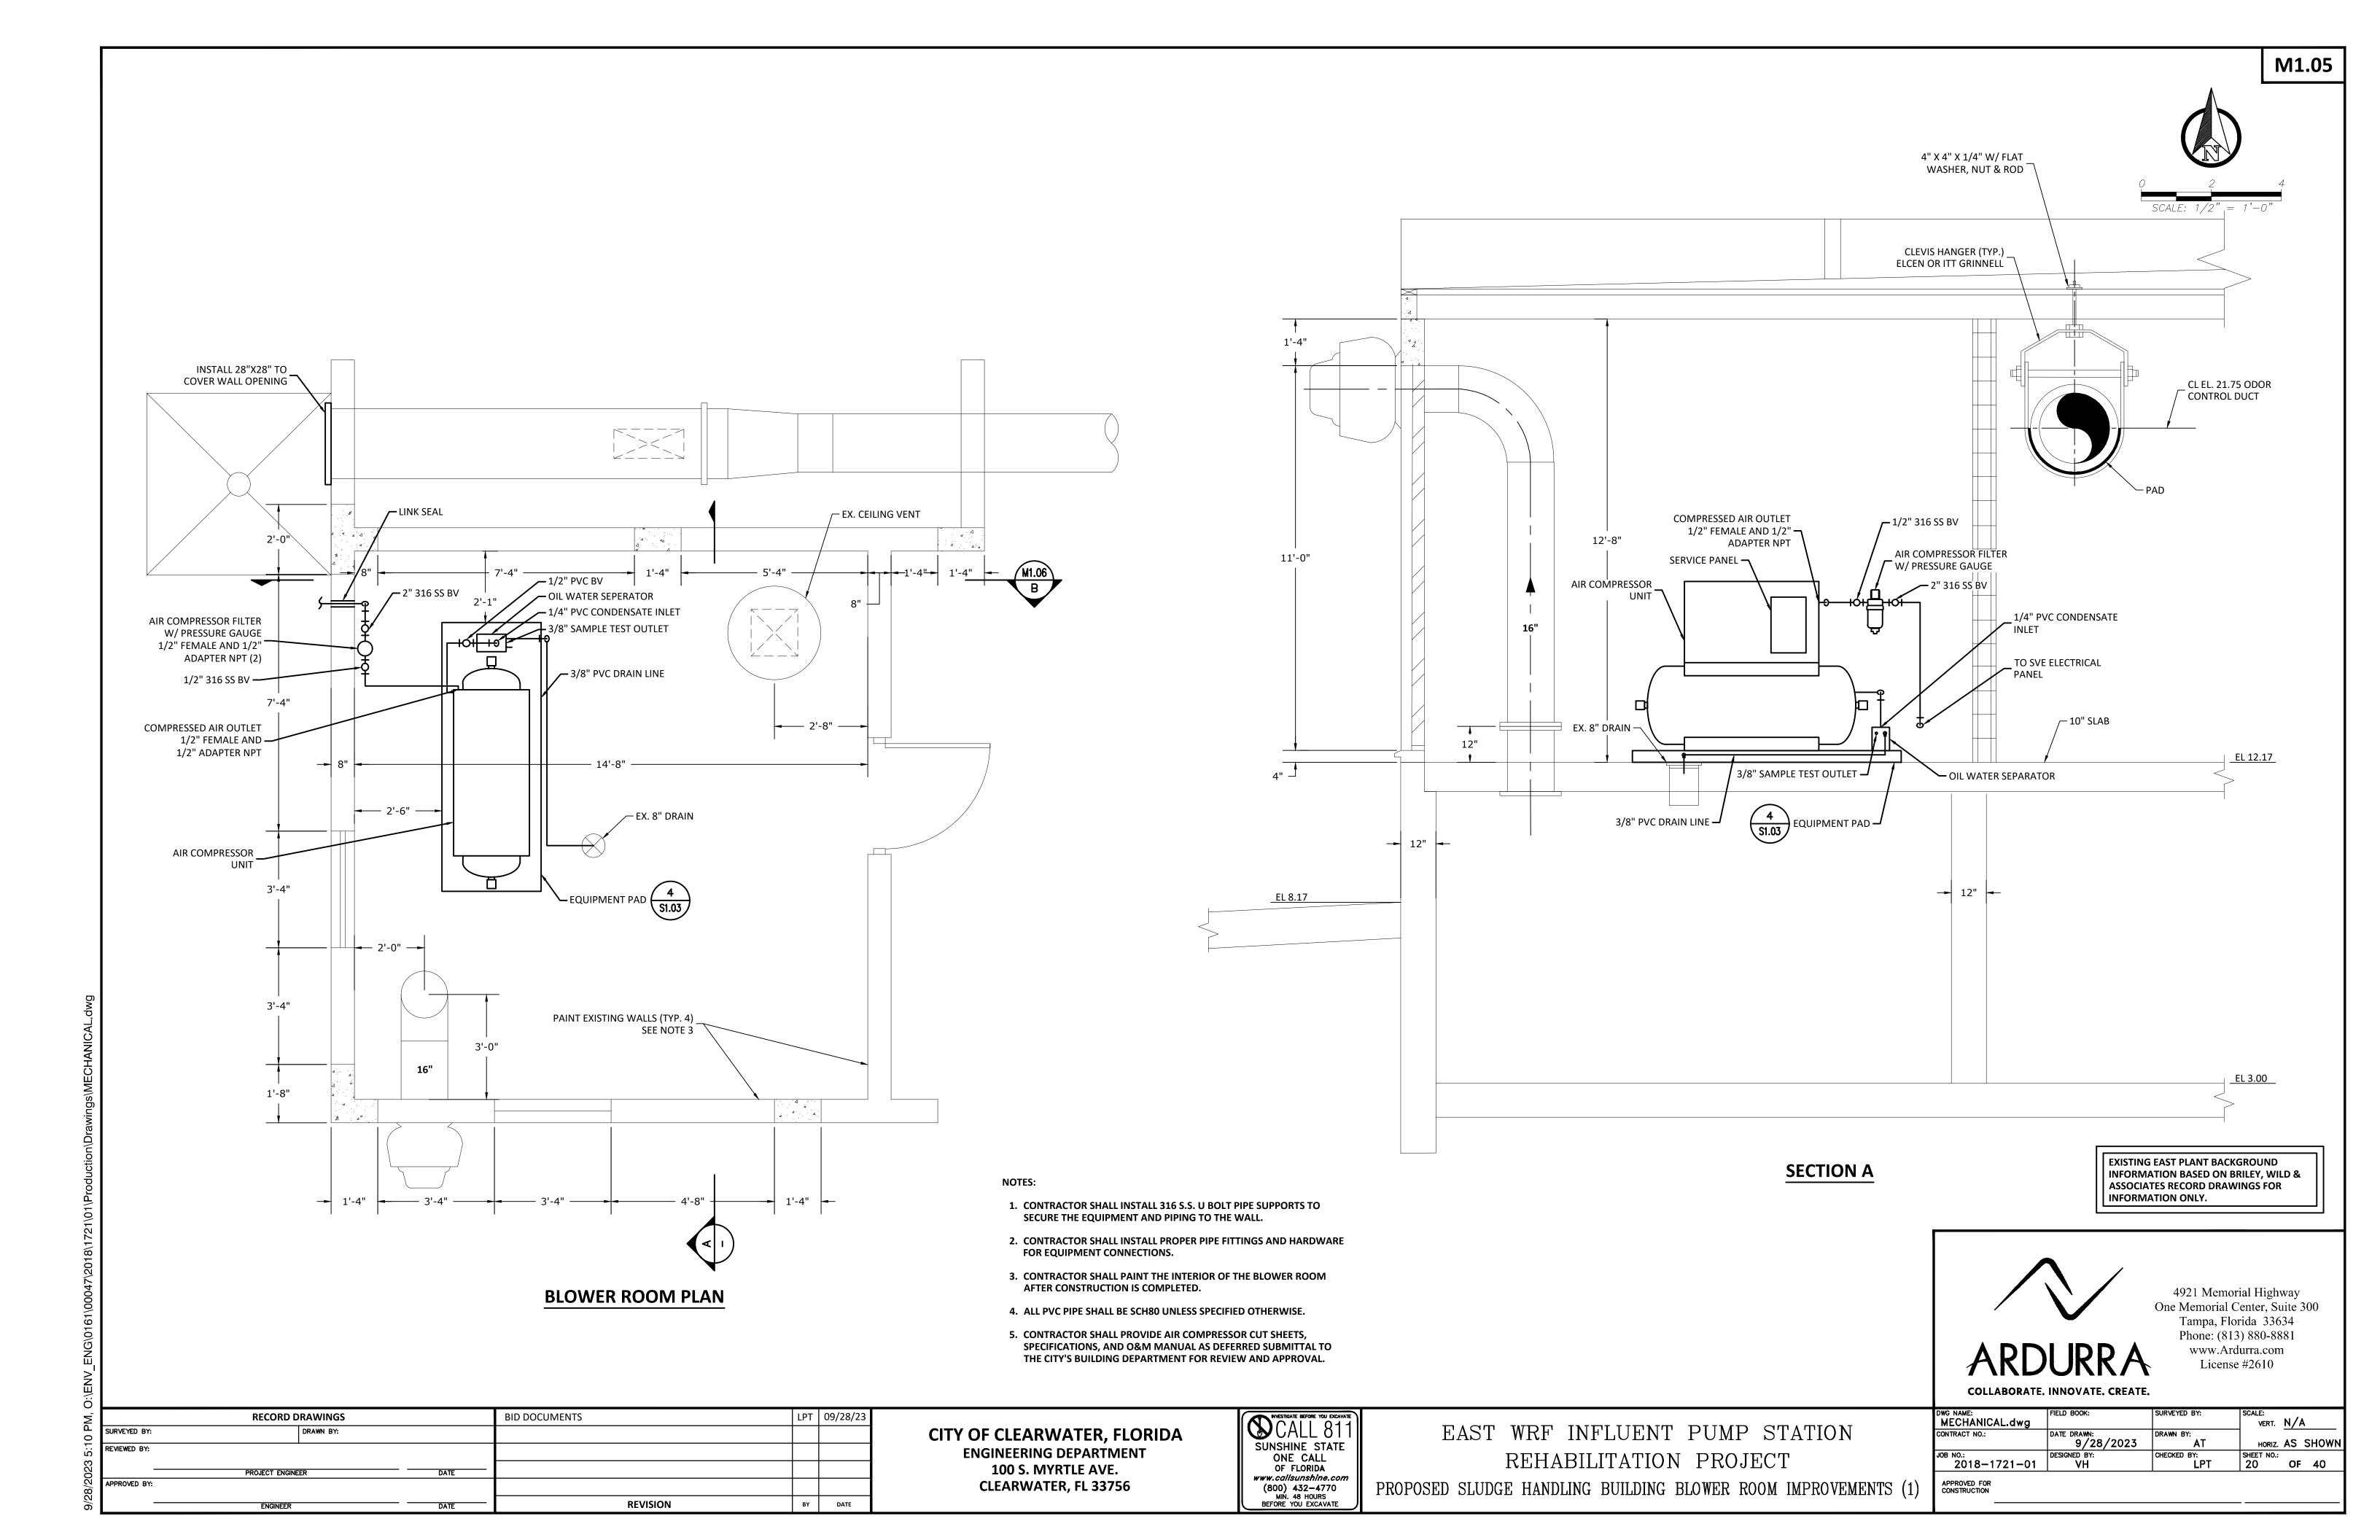

M1.06

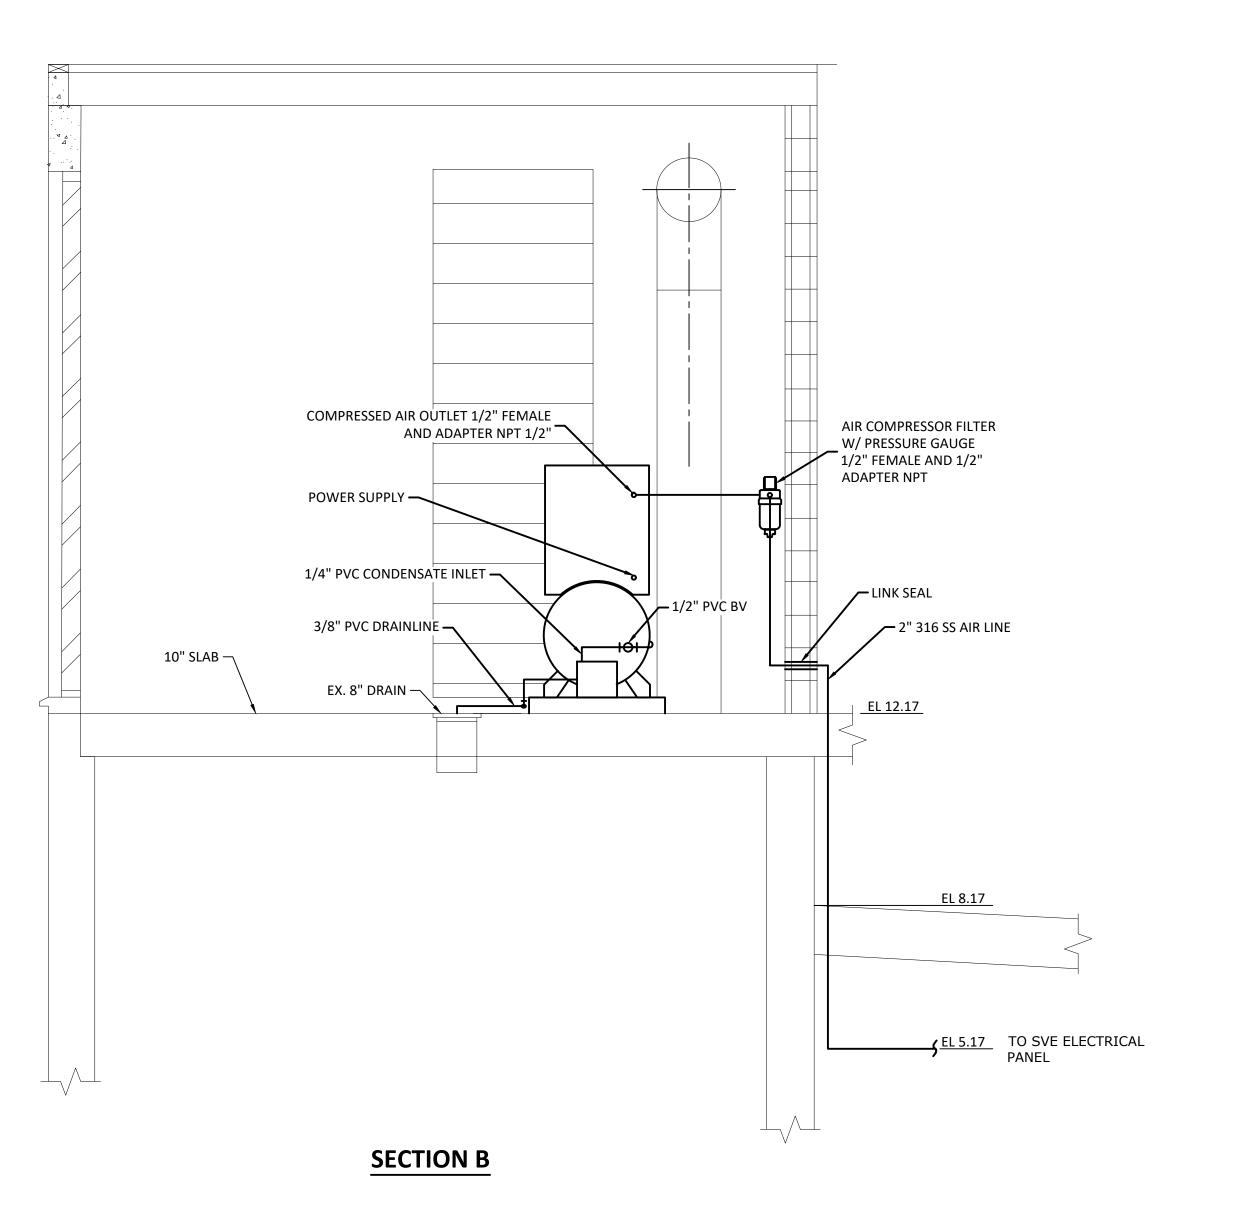

NOTES:

- 1. CONTRACTOR SHALL INSTALL U BOLT PIPE SUPPORTS TO SECURE THE EQUIPMENT AND PIPING TO THE WALL.
- 2. CONTRACTOR SHALL INSTALL PROPER PIPE FITTINGS AND HARDWARE FOR EQUIPMENT CONNECTIONS.
- 3. CONTRACTOR SHALL PAINT THE INTERIOR OF THE BLOWER ROOM AFTER CONSTRUCTION IS COMPLETED.
- 4. ALL PVC PIPE SHALL BE SCH80 UNLESS SPECIFIED OTHERWISE.

EXISTING EAST PLANT BACKGROUND INFORMATION BASED ON BRILEY, WILD & ASSOCIATES RECORD DRAWINGS FOR INFORMATION ONLY.



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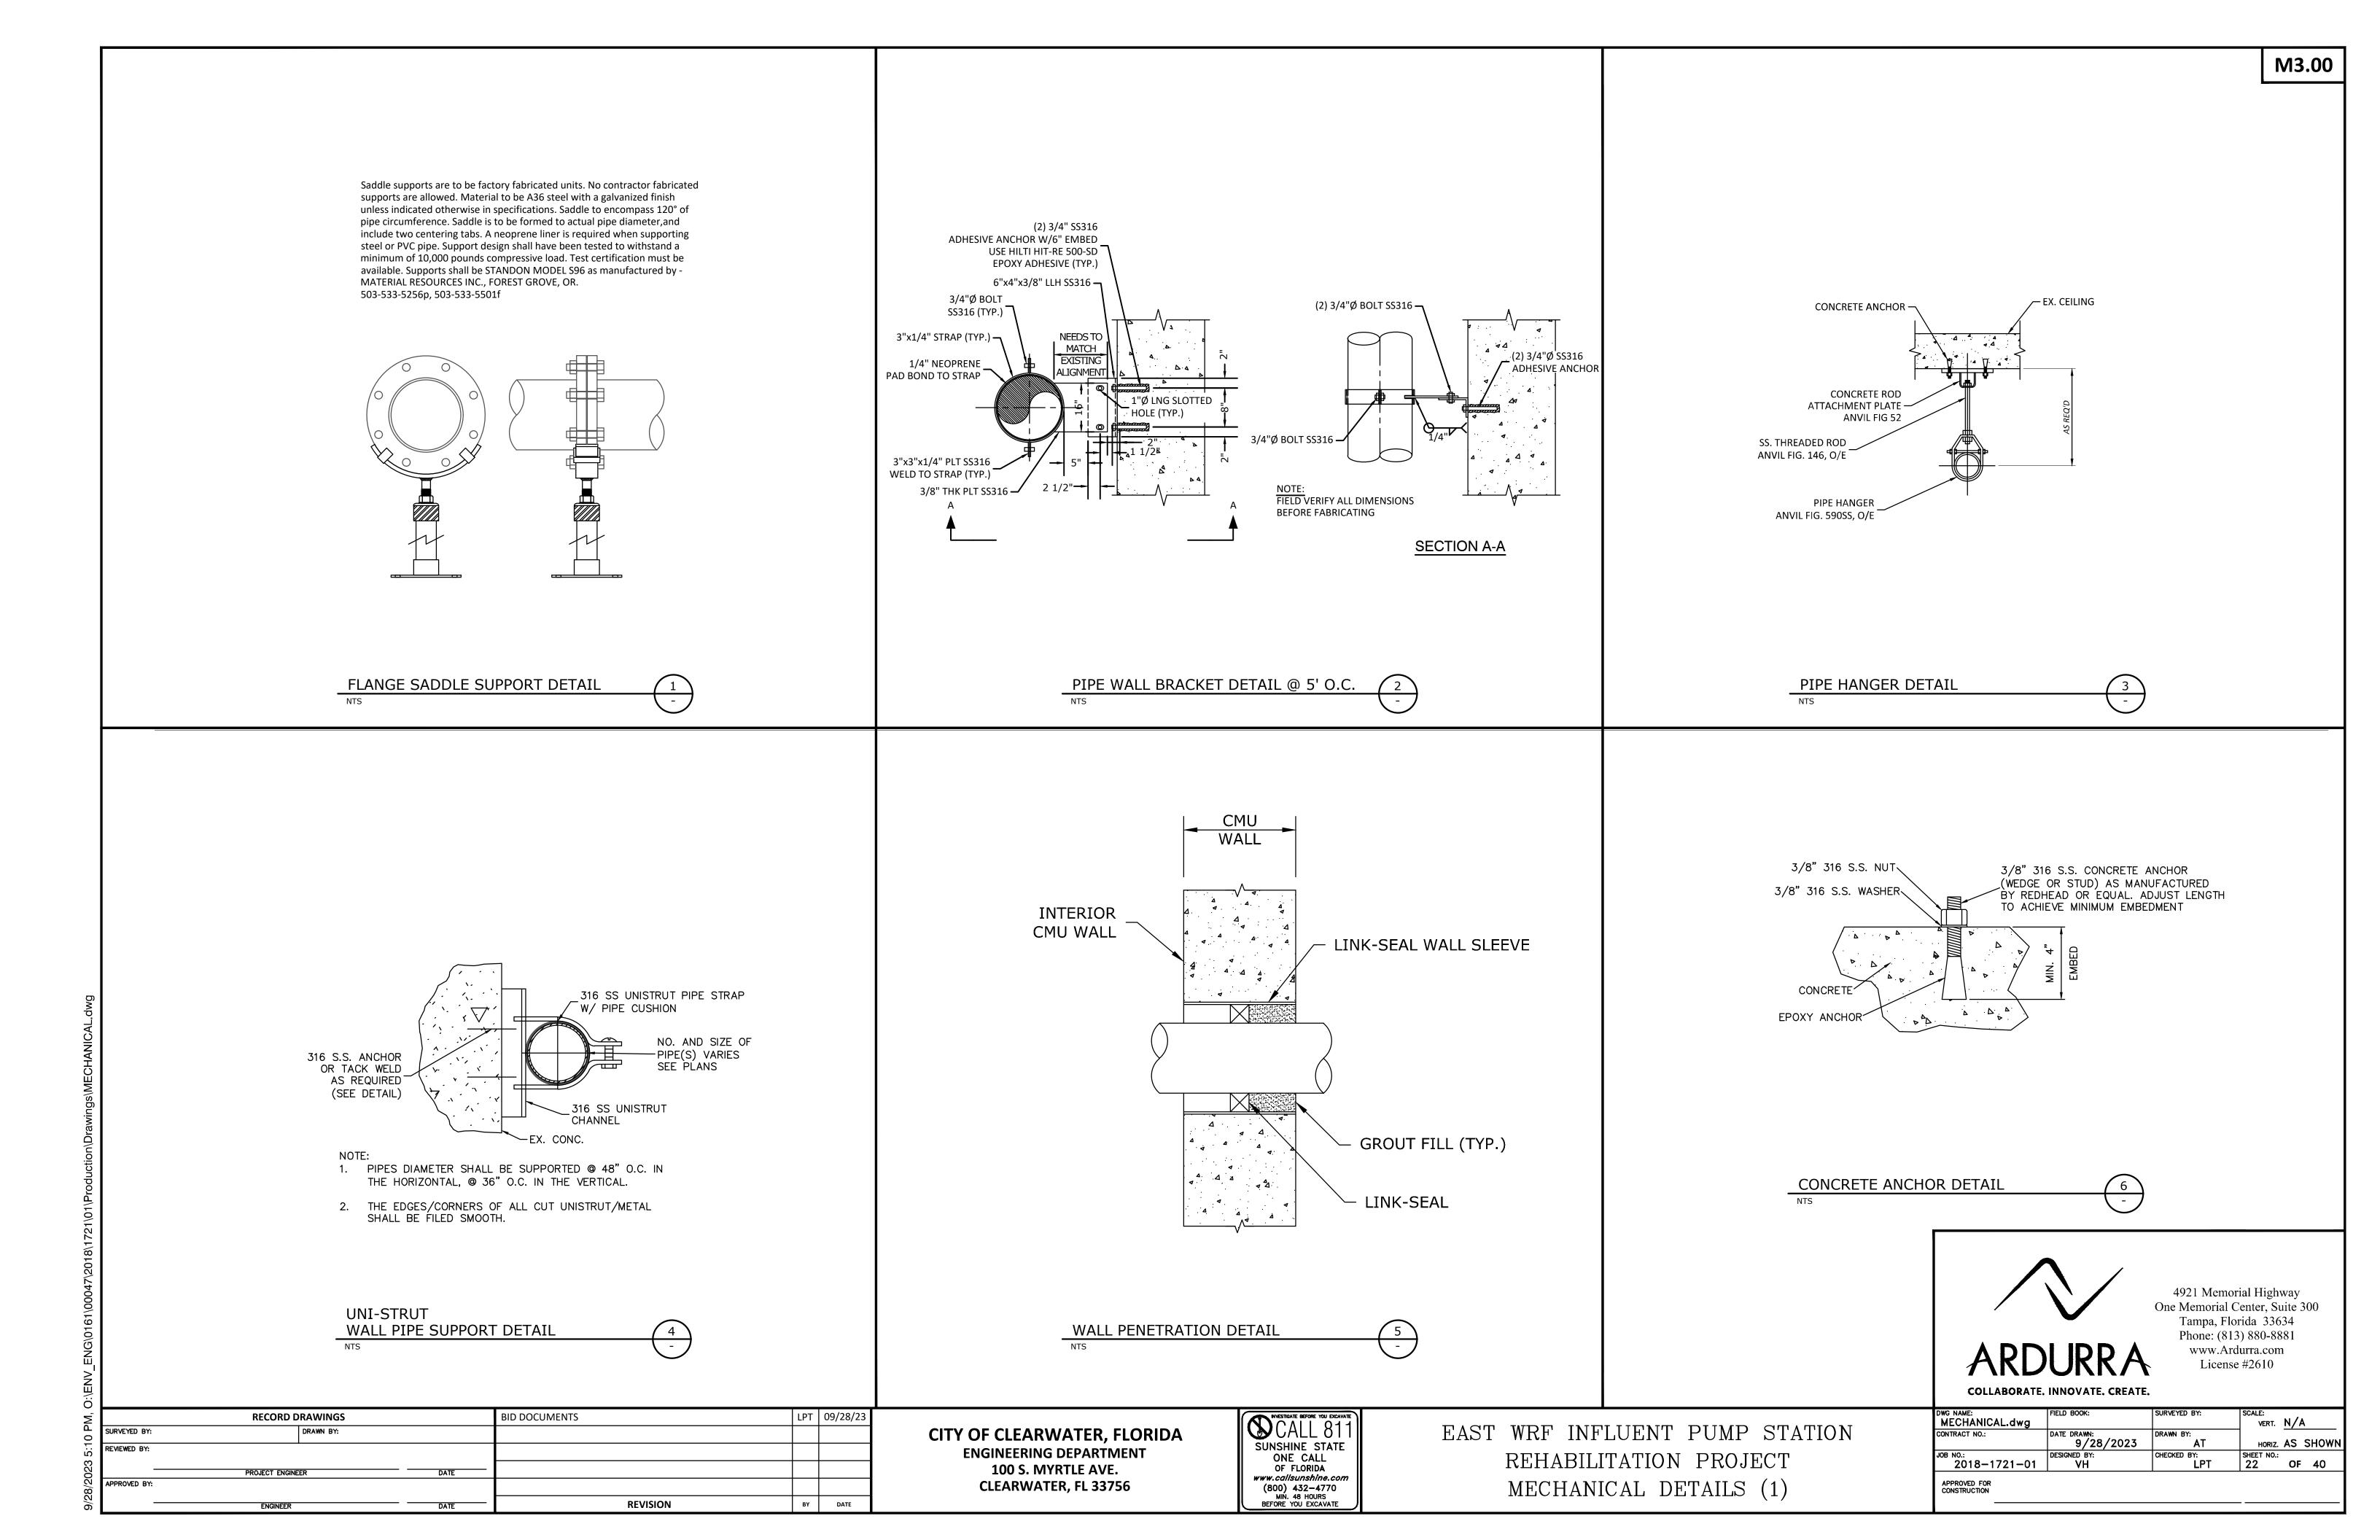
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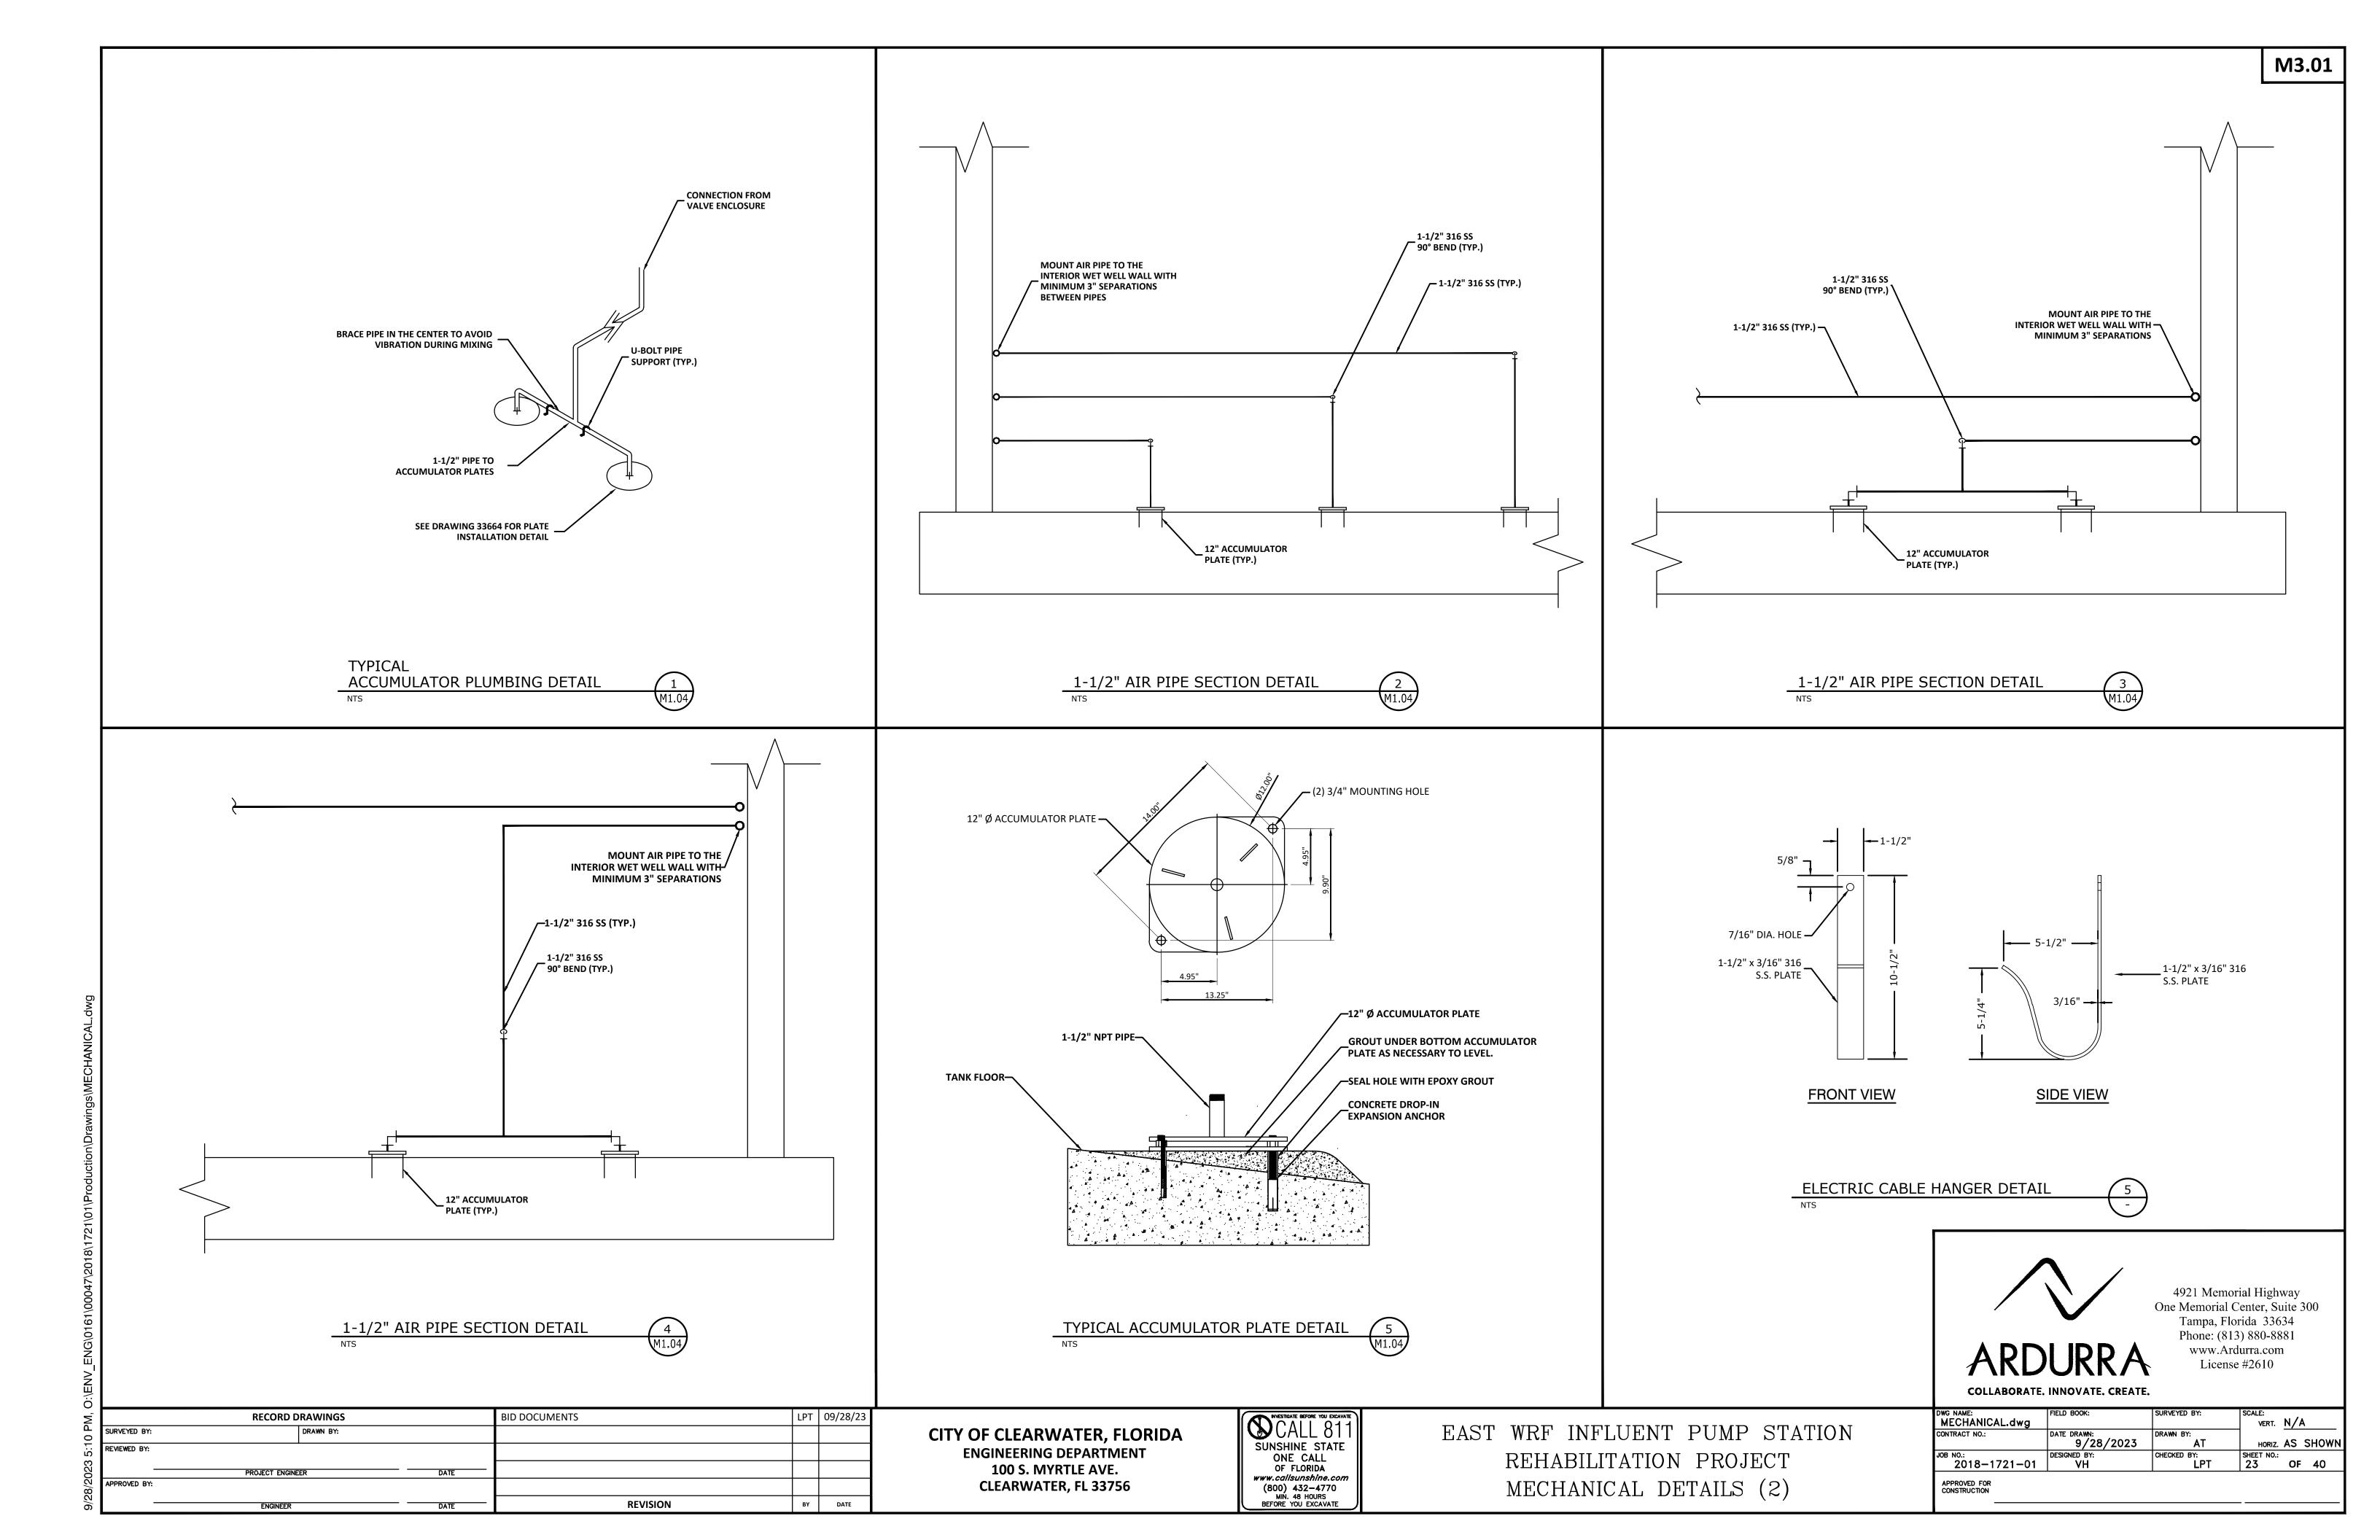
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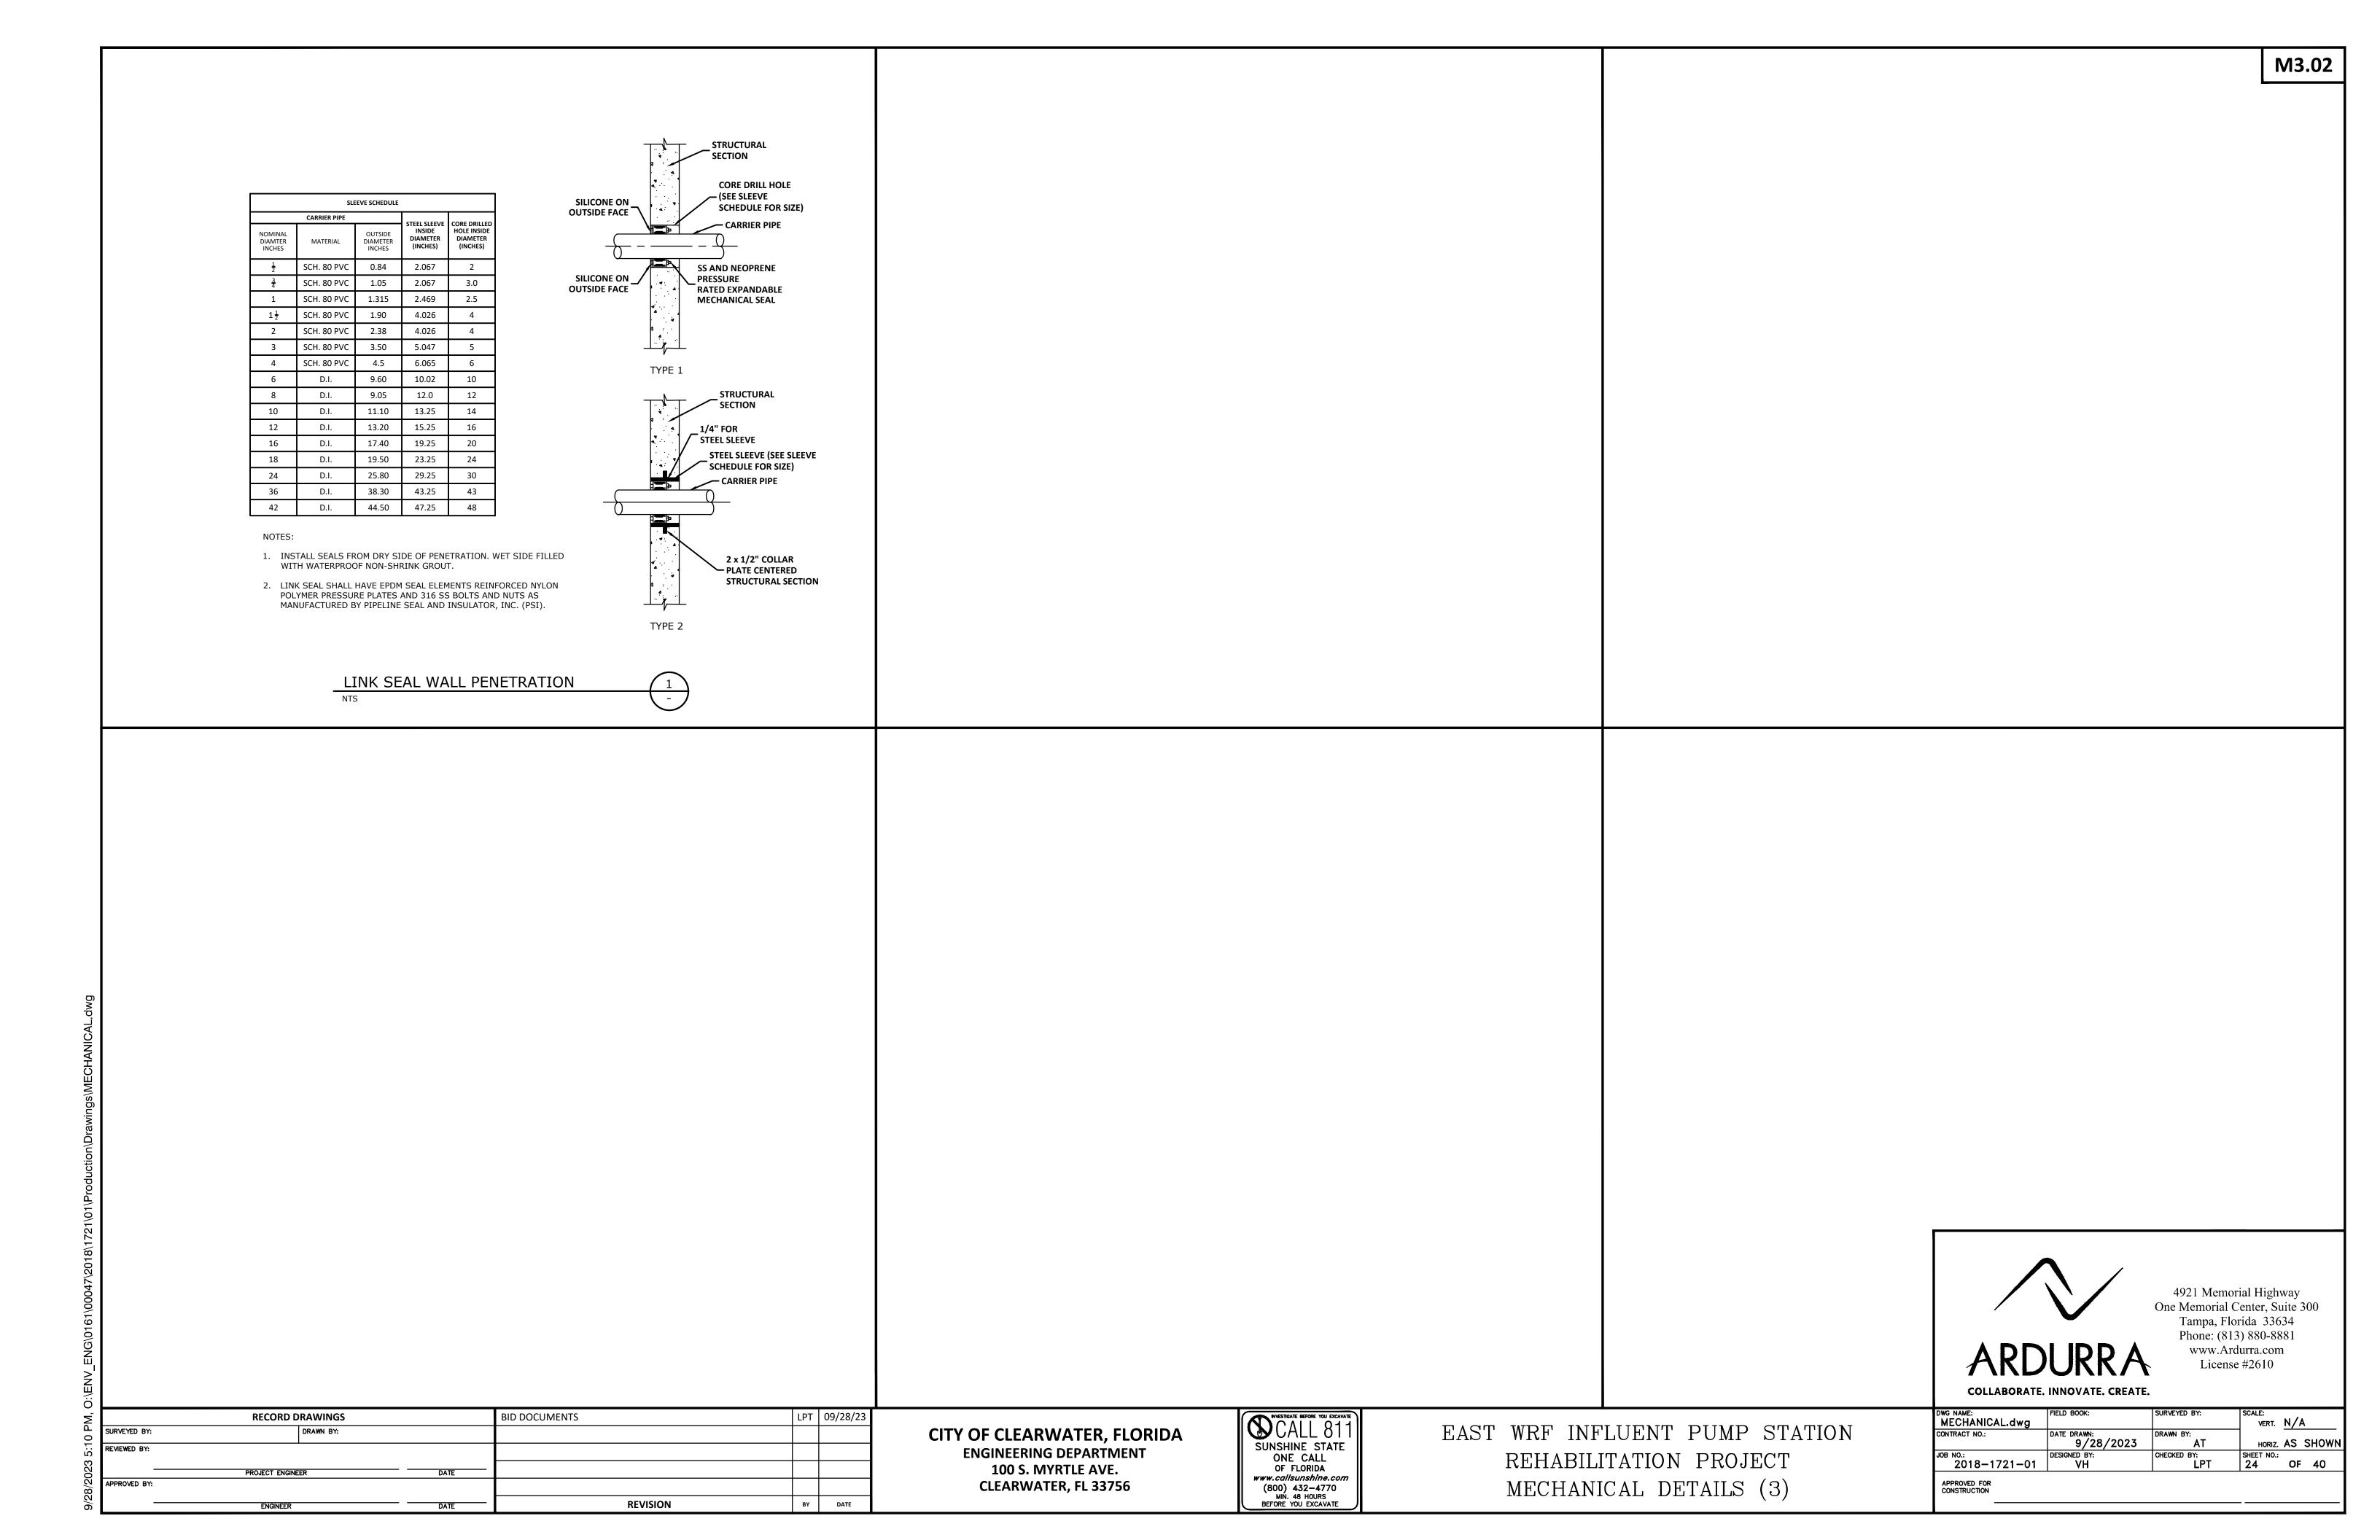


EAST WRF INFLUENT PUMP STATION
REHABILITATION PROJECT
PROPOSED SLUDGE HANDLING BUILDING BLOWER ROOM IMPROVEMENTS (2)

DWG NAME:	FIELD BOOK:	SURVEYED BY:	SCALE:
MECHANICAL.dwg			VERT. N/A
CONTRACT NO.:	DATE DRAWN:	DRAWN BY:	1
	9/28/2023	AT	HORIZ. AS SHOWI
JOB NO.:	DESIGNED BY:	CHECKED BY:	SHEET NO.:
2018-1721-01	VH	LPT LPT	21 OF 40
APPROVED FOR CONSTRUCTION			







**PILOT LIGHT** 

COMMON HOUSING

**INSTRUMENTS SHARING** 


DENOTES EQUIPMENT PROVIDED BY VENDOR

DENOTES EXISTING EQUIPMENT OR EQUIPMENT PROVIDED BY OTHERS UNDER A SEPARATE CONTRACT

### **GENERAL NOTES**

- THIS LEGEND APPLIES TO P&IDS ONLY AND MAY DIFFER FROM LEGENDS FOR OTHER SHEETS.
- IN GENERAL THIS LEGEND SHEET AND THE P&IDS ARE BASED ON THE INTERNATIONAL SOCIETY OF AUTOMATION (ISA) STANDARDS FOR PRACTICES FOR INSTRUMENTATION. SOME MODIFICATIONS, ADDITIONS AND ALTERATIONS HAVE BEEN MADE AS REQUIRED TO ACCOMMODATE PROJECT
- CONTRACTOR SHALL PROCURE THE SERVICES OF A SYSTEM INTEGRATOR TO FURNISH AND INSTALL ALL MATERIALS, EQUIPMENT, LABOR, AND SERVICES, REQUIRED TO ACHIEVE A FULLY INTEGRATED AND OPERATIONAL SYSTEM AS SPECIFIED AND SHOWN ON THE DRAWINGS.
- 4. SEE ELECTRICAL AND MECHANICAL SHEETS AND SPECIFICATIONS FOR ADDITIONAL CONTROL AND INTERLOCK REQUIREMENTS.
- 5. LIGHTER WEIGHT LINES, SHOWN AS —, INDICATE EQUIPMENT, INSTRUMENTS OR PIPING THAT ARE EXISTING. WEIGHTED LINES, SHOWN AS — OR HEAVIER — , INDICATE EQUIPMENT, INSTRUMENTS OR PIPING THAT ARE NEW. DASHED WEIGHTED LINES, SHOWN AS ————, INDICATED EQUIPMENT, INSTRUMENTS OR PIPING THAT ARE GROUPED AS A PACKAGE.

# TYPICAL TAG NUMBERS & DESIGNATION

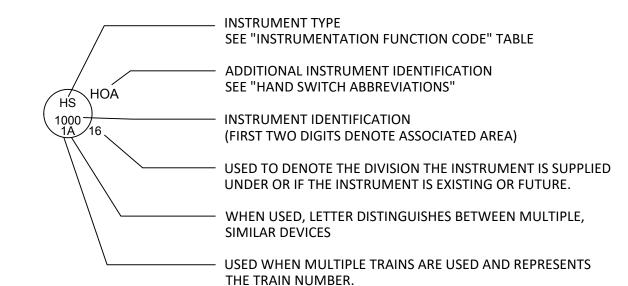

# HAND SWITCH ABBREVIATIONS

A/O = AUTO/OFFA/M = AUTO/MANUAL C/M = COMPUTER/MANUAL C/L = COMPUTER/LOCAL D/S = DUTY/STANDBY F/R = FORWARD/REVERSE F/O/R = FORWARD/OFF/REVERSE F/S = FAST SLOW F/O/S = FAST/OFF/SLOW H/O/A = HAND/OFF/AUTO

L/L/S = LEAD/LAG/STANDBY

L/O/R = LOCAL/OFF/REMOTE L/O/S = LOCKOUT/STOP L/A = LOCAL/AUTO L/R = LOCAL/REMOTE O/C = OPEN/CLOSE O/C/A = OPEN/CLOSE/AUTO O/O = ON/OFFO/A/O = ON/AUTO/OFFO/S/C = OPEN/STOP/CLOSE R/S/L = RAISE/STOP/LOWER S/S = START/STOP S/O/R = START/OFF/RESET

# INSTRUMENTATION FUNCTION CODE

	FIRST L	ETTERS	SUCCEEDING LETTERS			
	COLUMN 1	COLUMN 2	COLUMN 3	COLUMN 4	COLUMN 5	
	MEASURE/INITIATING VARIABLE	VARIABLE MODIFIER	READOUT/PASSIVE FUNCTION	OUTPUT/ACTIVE FUNCTION	FUNCTION MODIFIER	
Α	ANALYSIS		ALARM			
В	BURNER COMBUSTION		USER'S CHOICE	USER'S CHOICE	USER'S CHOICE	
С	USER'S CHOICE			CONTROL	CLOSED	
D	USER'S CHOICE	DIFFERENCE DIFFERENTIAL			DEVIATION	
E	VOLTAGE		SENSOR, PRIMARY ELEMENT			
F	FLOW, FLOWRATE	RATIO				
G	USER'S CHOICE		GLASS, GAUGE, VIEWING DEVICE			
Η	HAND				HIGH	
I	CURRENT		INDICATE			
J	POWER		SCAN			
К	TIME, SCHEDULE	TIME RATE OF CHANGE		CONTROL STATION		
L	LEVEL		LIGHT		LOW	
М	MOISTURE				MIDDLE, INTERMEDIATE	
N	USER'S CHOICE		USER'S CHOICE	USER'S CHOICE	USER'S CHOICE	
0	USER'S CHOICE		ORIFICE, RESTRICTION		OPEN	
Р	PRESSURE		POINT (TEST CONNECTION)			
Q	QUANTITY	INTEGRATE, TOTALIZE	INTEGRATE, TOTALIZE			
R	REDIATION		RECORD		RUN	
S	SPEED, FREQUENCY	SAFETY		SWITCH	STOP	
Т	TEMPERATURE			TRANSMIT		
U	MULTIVARIABLE		MULTIFUNCTION	MULTIFUNCTION		
V	VIBRATION, MECHANICAL, ANALYSIS			VALVE, DAMPER, LOUVER		
W	WEIGHT, FORCE		WELL, PROBE			
Х	UNCLASSIFIED (1)	X-AXIS	ACCESSORY DEVICES, UNCLASSIFIED (1)	UNCLASSIFIED (1)	UNCLASSIFIED (1)	
Υ	EVENT, STATE, PRESENCE	Y-AXIS		AUXILIARY DEVICES		
Z	POSITION, DIMENSION	Z-AXIS, SAFETY INSTRUMENT SYSTEM		DRIVER, ACTUATOR, UNCLASSIFIED, FINAL CONTROL ELEMENT		

**TABLE NOTES:** 

(1) WHEN USED SYMBOL OR SIGNAL LINE IS ANNOTATED.

### **INSTRUMENT LINE SYMBOLS**

	ELECTRICAL SIGNAL
-0-0-0-0-0-	ETHERNET CAT 6 CABLI
FOC	FIBER-OPTIC CABLE
	COLLIVABE

# MISCELLANEOUS SYMBOLS

ASD	ADJUSTABLE SPEED DRIVES
MCC	INDICATES INTERLOCK OR LOGIC IN A MOTOR CONTROL CENTER
$\langle 1 \rangle$	INDICATES GENERAL OR MISCELLANEOUS HARDWIRED INTERLOCK
MS	MOTOR STARTER
VFD	VARIABLE FREQUENCY DRIVE
$\bigcirc$ M	CONSTANT SPEED MOTOR

**VARIABLE SPEED MOTOR** 

BEACON

HORN

# **ELECTRICAL / AIR SOURCES**

**GENERAL ABBREVIATIONS** 

AUTOMATIC TEMPERATURE CONTROL

**COMBUSTIBLE GAS DETECTOR** 

**CHLORINE GAS VACUUM** 

CHLORINE GAS SOLUTION

CENTRAL PROCESSING UNIT

**CONTROL ETHERNET SWITCH** DIGITAL OR DISCRETE INPUT

ANALOG IN

DIVISION

FAIL CLOSE

FLOW METER

DRAIN

PUMP

PROCESS AIR

SWITCH GEAR

**DIGITAL OUTPUT** 

**EMERGENCY STOP** 

ETHERNET SWITCH

NORMALLY CLOSED

NORMALLY OPEN

FAIL OPEN OR FIBER OPTIC

MOTOR CONTROL CENTER

**OPERATOR WORKSTATION** 

PUMP PROTECTION MODULE

UNINTERRUPTED POWER SUPPLY

VARIABLE FREQUENCY DRIVE

POWER QUALITY METER

REMOTE INPUT/OUTPUT

**HUMAN MACHINE INTERFACE** 

**OPERATOR INTERFACE TERMINAL** 

PROGRAMMABLE AUTOMATION CONTROLLER

PROGRAMMABLE LOGIC CONTROLLER

**ANALOG OUT** 

**BEYOND LIMITS** 

ΑO

B/L

CGD

CLG

CLS

CPU

DIV

DO

DR

**ESW** 

FC **FMM** 

FO

HMI

MCC

NO

OIT

PΑ

PAC

PLC

PPM

PQM

RIO

**SWGR** 

UPS

VFD


OWS

**ESTOP** 


**CESW** 

UPS — UPS POWERED ELECTRICAL SOURCE → ELECTRICAL SOURCE INSTRUMENT AIR SOURCE

## I/O SIGNALS

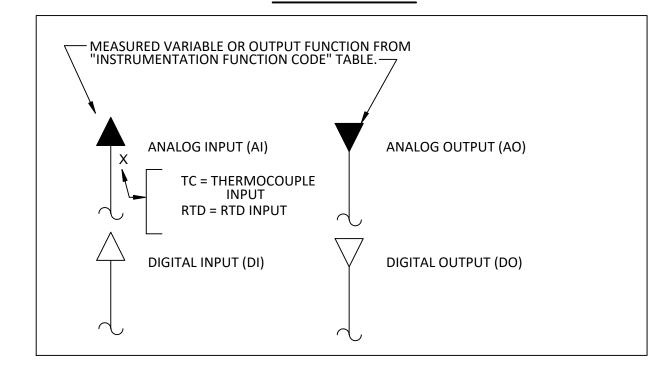

## PRIMARY ELEMENTS

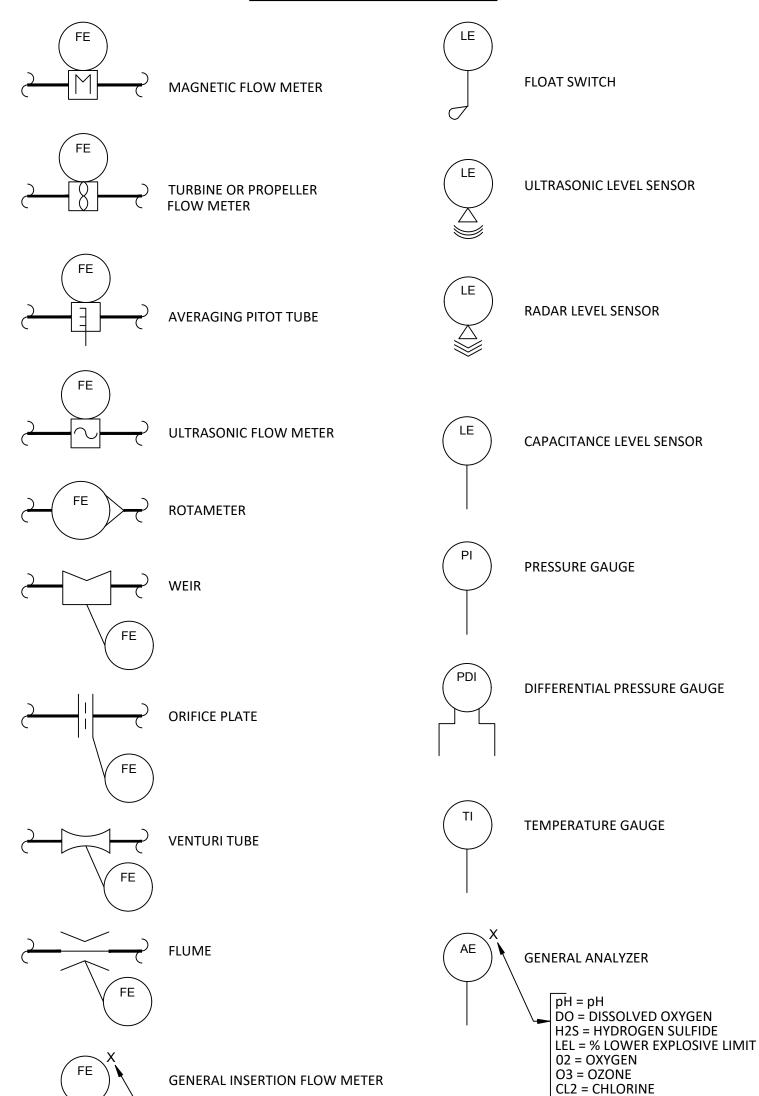



4921 Memorial Highway One Memorial Center, Suite 300 Tampa, Florida 33634 Phone: (813) 880-8881 www.Ardurra.com License #2610

**COLLABORATE. INNOVATE. CREATE.** 

TURB = TURBIDITY

FL = FLUORIDE

VERT. N/A 9/28/2023 CW HORIZ. AS SHOWN SHEET NO.: 37 OF 40 LPT

L/O/C = LOCAL/OFF/COMPUTER BID DOCUMENTS LPT 09/28/23 **RECORD DRAWINGS** SURVEYED BY: DRAWN BY: REVIEWED BY: PROJECT ENGINEER **REVISION** DATE

CITY OF CLEARWATER, FLORIDA **ENGINEERING DEPARTMENT** 100 S. MYRTLE AVE. **CLEARWATER, FL 33756** 


SUNSHINE STATE ONE CALL OF FLORIDA www.callsunshine.com (800) 432-4770 MIN. 48 HOURS BEFORE YOU EXCAVATE

REHABILITATION PROJECT

I-100.dwg EAST WRF INFLUENT PUMP STATION JOB NO.: DESIGNED BY 2018-1721-01 ME APPROVED FOR CONSTRUCTION INSTRUMENTATION LEGENDS, SYMBOLS & ABBREVIATIONS I

THERMAL MASS FLOW METER

IM=INSERT MAG

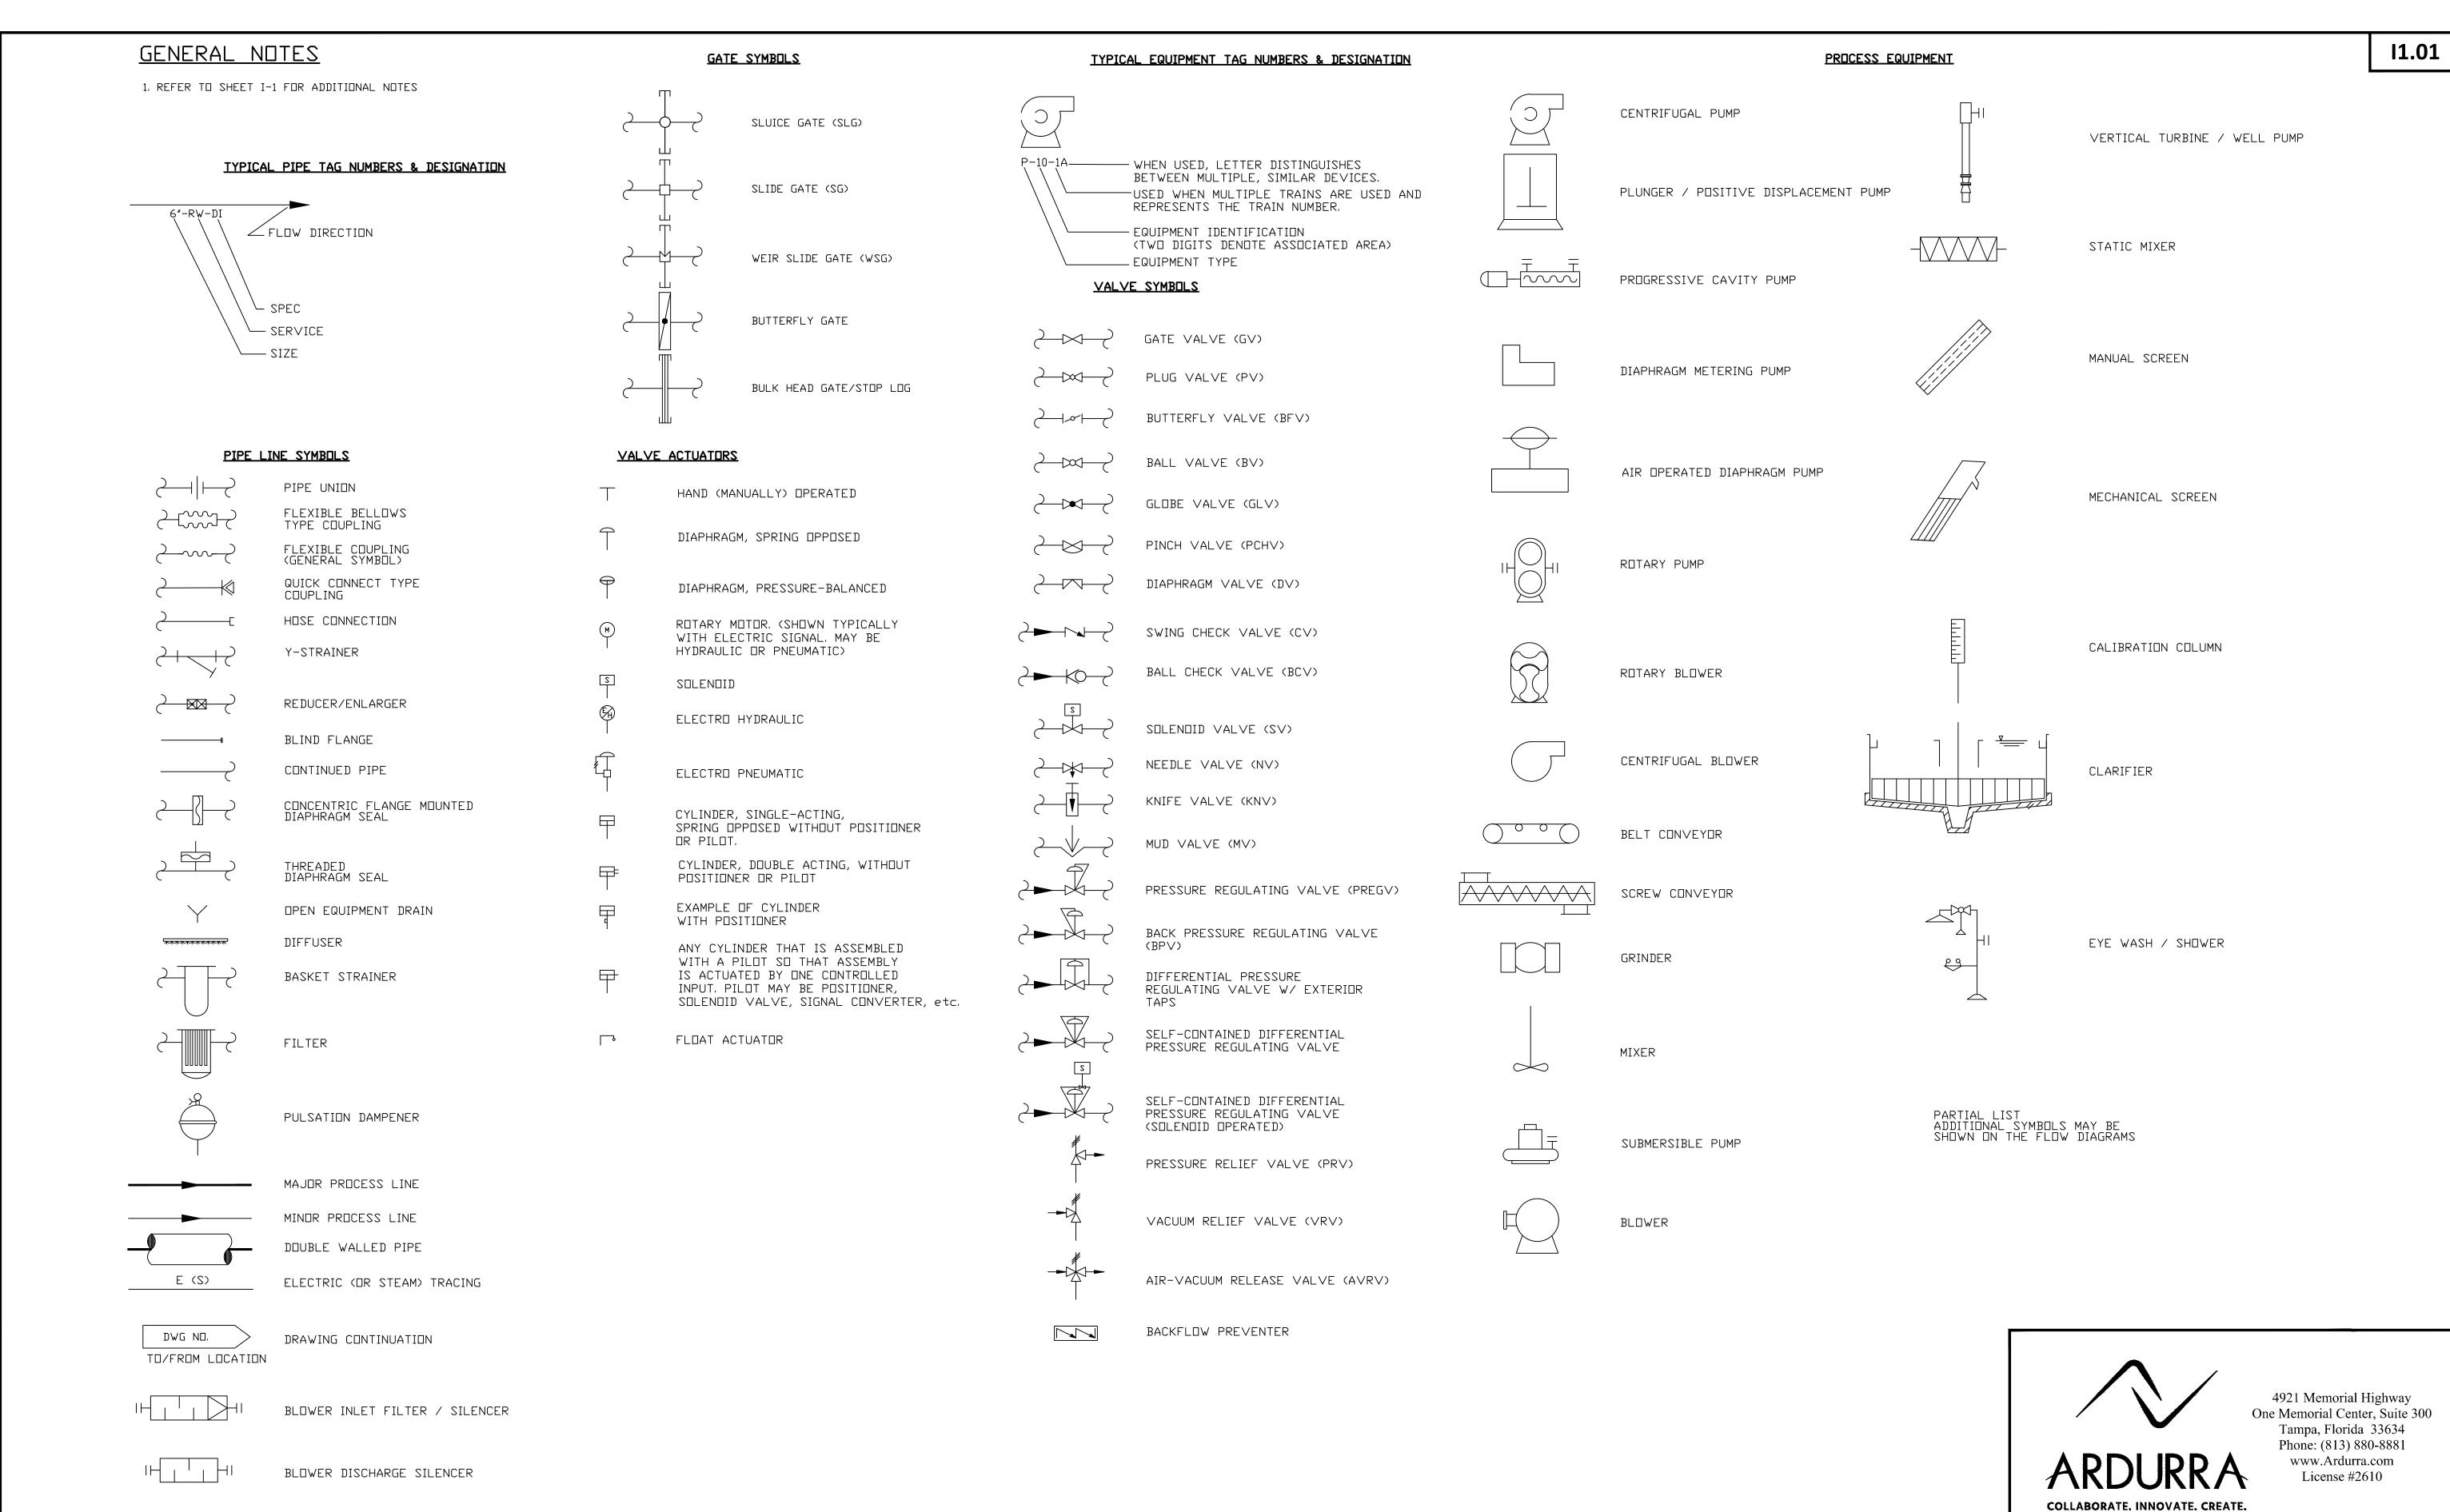

CITY OF CLEARWATER, FLORIDA ENGINEERING DEPARTMENT 100 S. MYRTLE AVE. CLEARWATER, FL 33756 NVESTIGATE BEFORE YOU EXCAVATE

CALL 811

SUNSHINE STATE

ONE CALL

OF FLORIDA

www.callsunshine.com


(800) 432-4770


MIN. 48 HOURS

BEFORE YOU EXCAVATE

EAST WRF INFLUENT PUMP STATION
REHABILITATION PROJECT
INSTRUMENTATION LEGENDS, SYMBOLS & ABBREVIATIONS I

CONTRACT NO.:	DATE DRAWN: 9/28/2023	DRAWN BY:	HORIZ.	AS	SHO
JOB NO.: 2018-1721-01	DESIGNED BY: ME	CHECKED BY:	SHEET NO.:	OF	

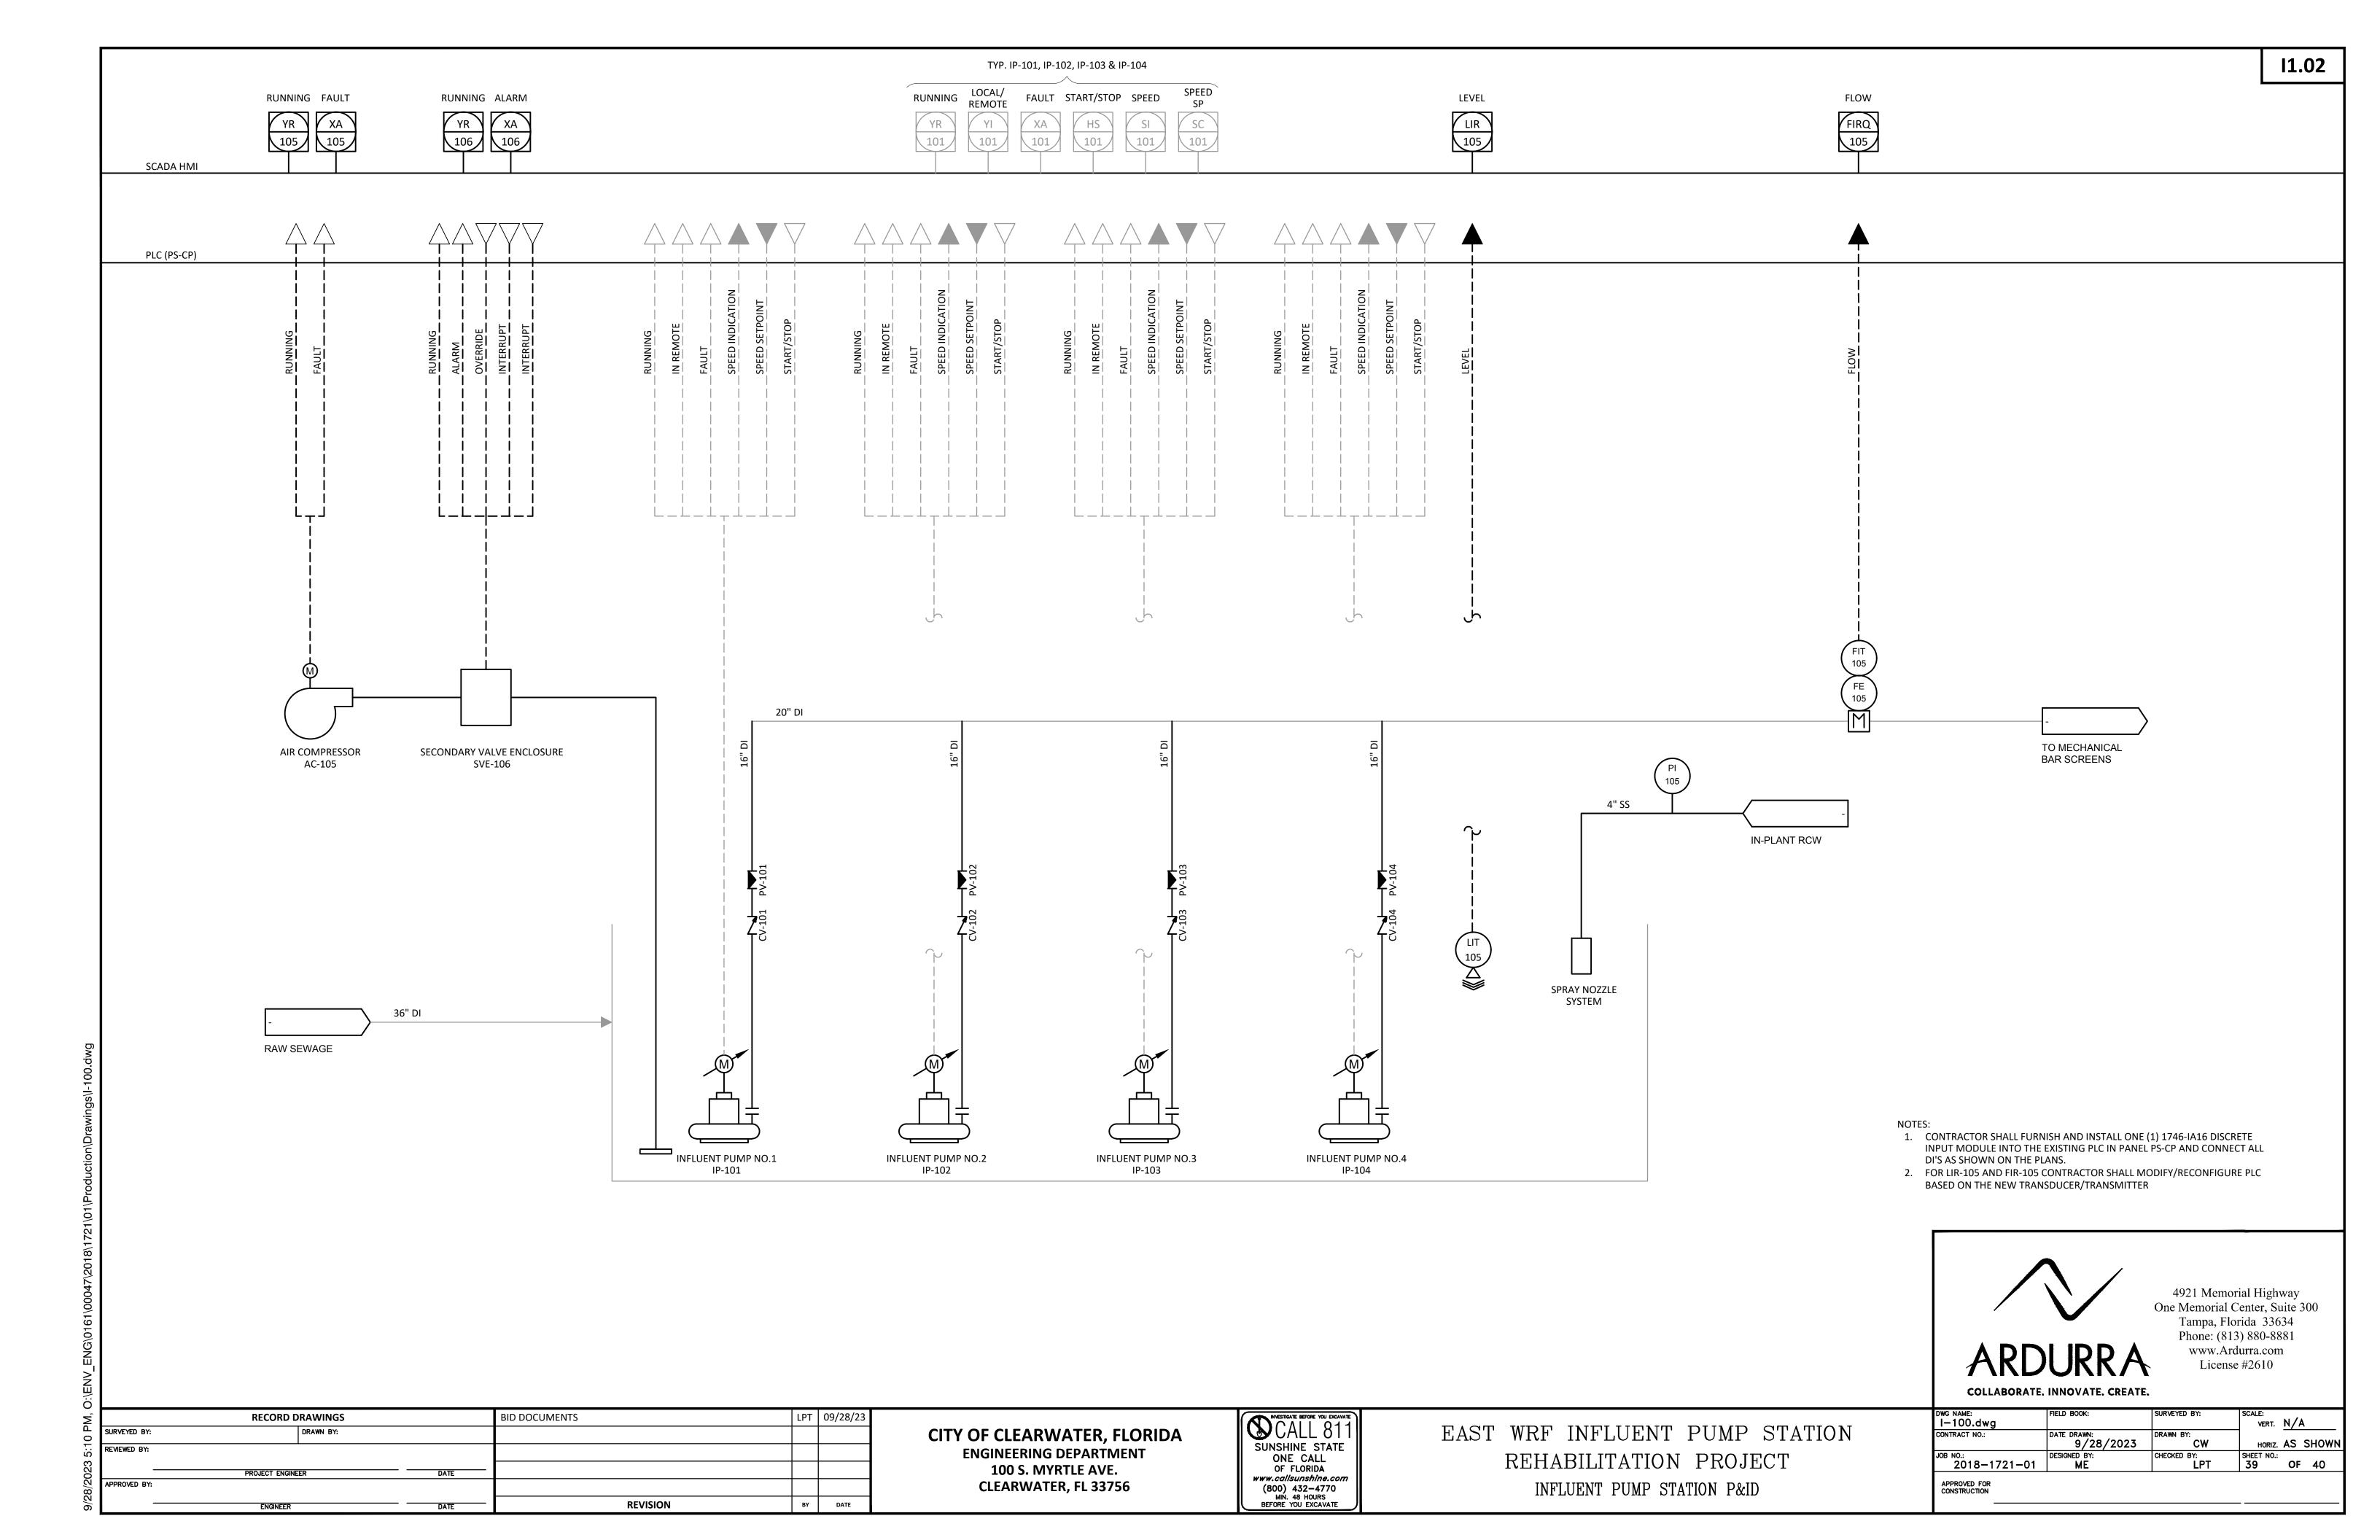

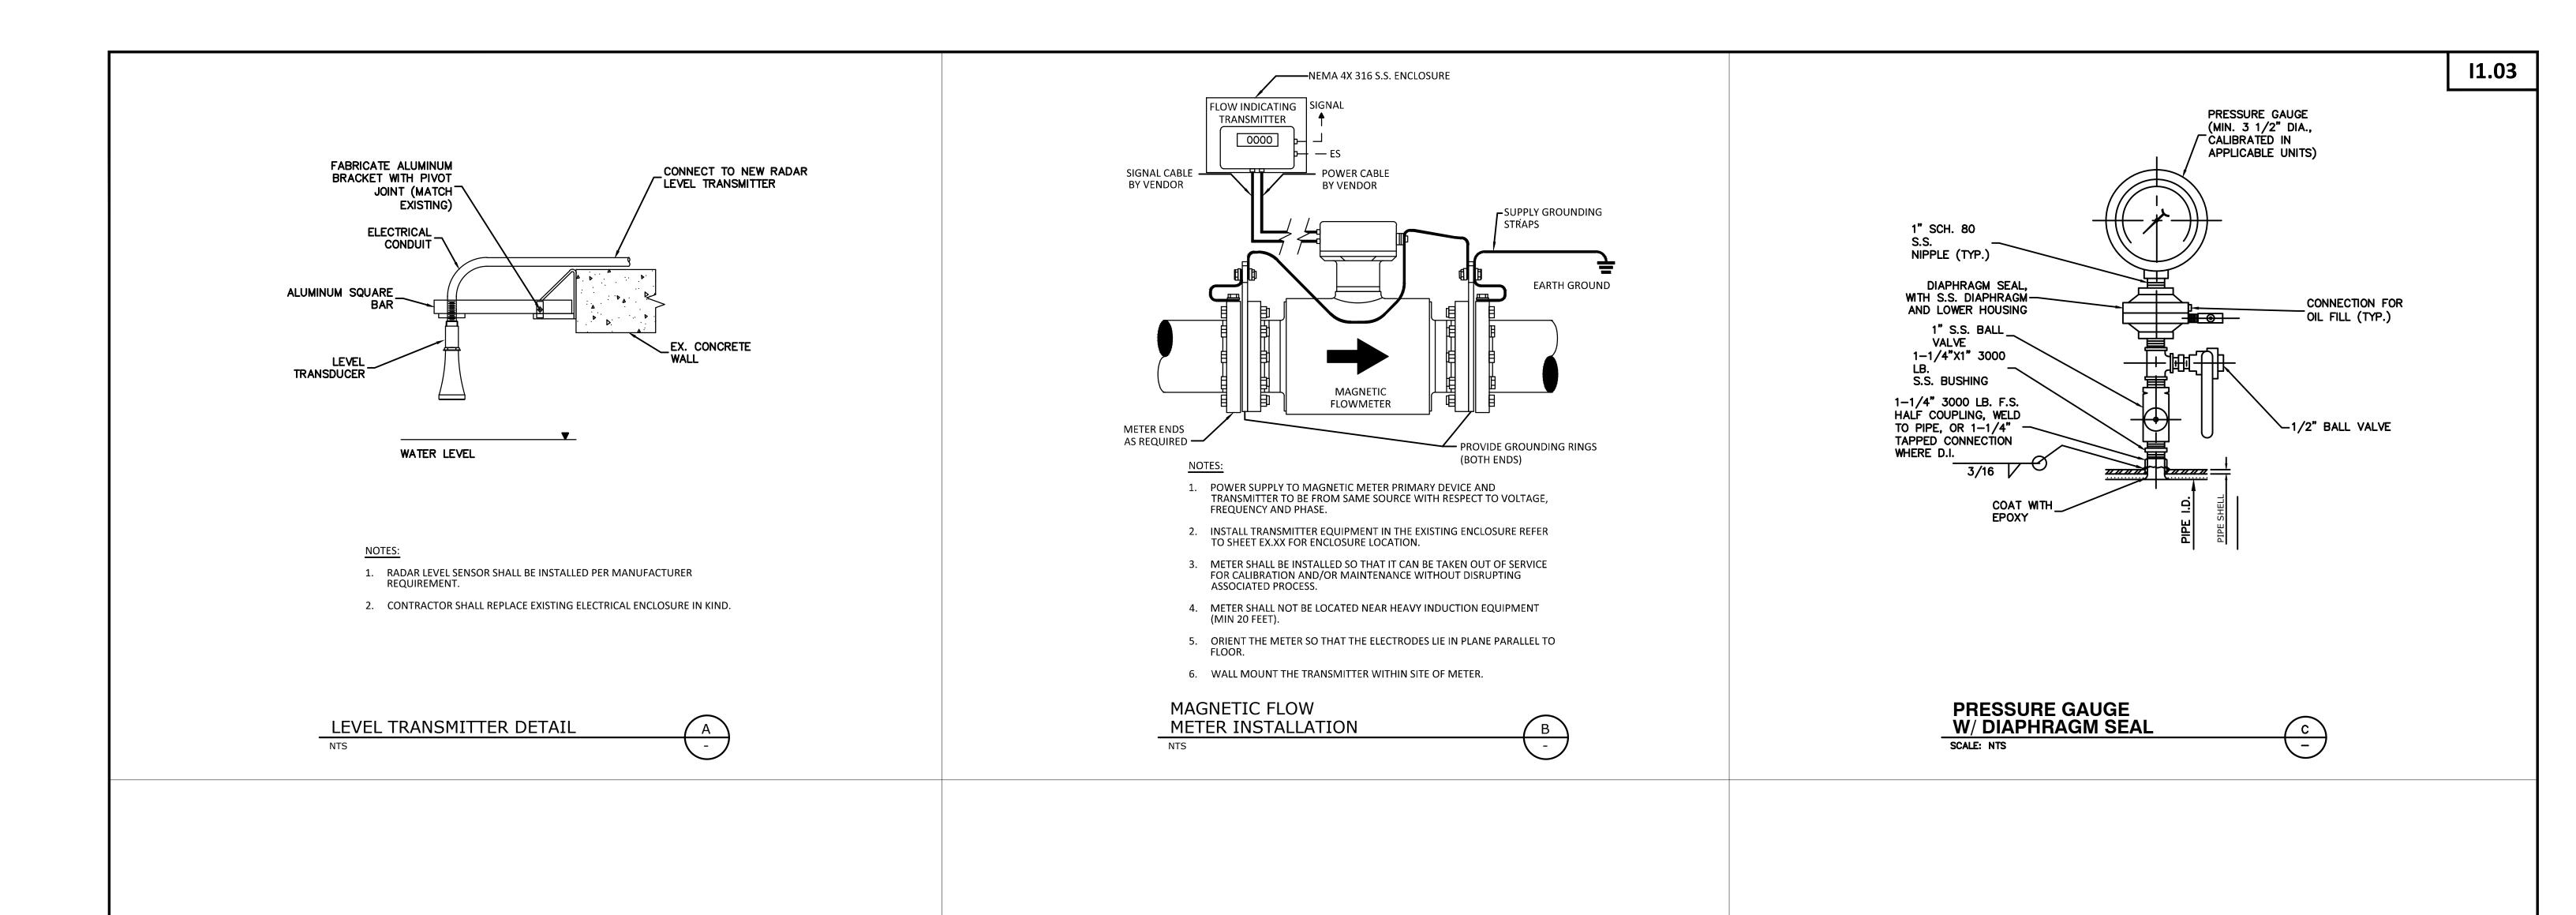



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One Memorial Center, Suite 300
Tampa, Florida 33634
Phone: (813) 880-8881
www.Ardurra.com
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RECORD DRAWINGS			BID DOCUMENTS	LP.	т 09/	/28/23	
SURVEYED BY:		DRAWN BY:					
REVIEWED BY:							
	PROJECT ENGINE	ER	DATE				
APPROVED BY:							
	ENGINEED		DATE	REVISION	BY	,	DATE

CITY OF CLEARWATER, FLORIDA ENGINEERING DEPARTMENT 100 S. MYRTLE AVE. CLEARWATER, FL 33756 SUNSHINE STATE
ONE CALL
OF FLORIDA
www.callsunshine.com
(800) 432-4770
MIN. 48 HOURS
BEFORE YOU EXCAVATE

EAST WRF INFLUENT PUMP STATION
REHABILITATION PROJECT
MISCELLANEOUS INSTRUMENTATION DETAILS

DWG NAME: I-100.dwg	FIELD BOOK:	SURVEYED BY:	SCALE: VERT.	N//	4
CONTRACT NO.:	DATE DRAWN: 9/28/2023	DRAWN BY:	HORIZ.	AS	SHOWN
JOB NO.: 2018-1721-01	DESIGNED BY: ME	CHECKED BY:	SHEET NO.:	OF	40
APPROVED FOR CONSTRUCTION					