
SHEET INDEX

SHEET #	SHEET DESCRIPTION
1	ELECTRICAL NOTES, LEGENDS & PROJECT SCOPI
2	ELECTRICAL EXISTING CONDITION- DEMO PLAI
3	PROPOSED ELECTRICAL SITE PLAN
4	ELECTRICAL YARD & PANEL SCHEDULE
5	REVISED ELECTRICAL RISER DIAGRAM
6	PHOTOMETRIC PERFORMANCE DATA
7-12	AS BUILT PHASE I DRAWINGS




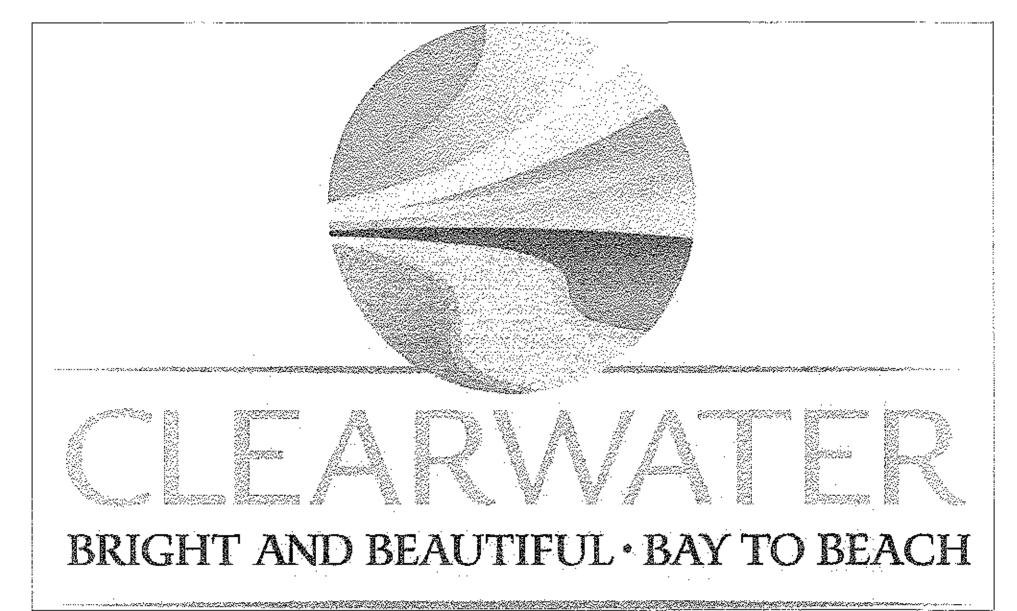


Parks & Recreation Department

100 S. Myrtle Avenue, Clearwater, Florida 33756

COUNTRYSIDE SPORTS COMPLEX
3060 MCMULLEN BOOTH RD.
CLEARWATER, FL 33761

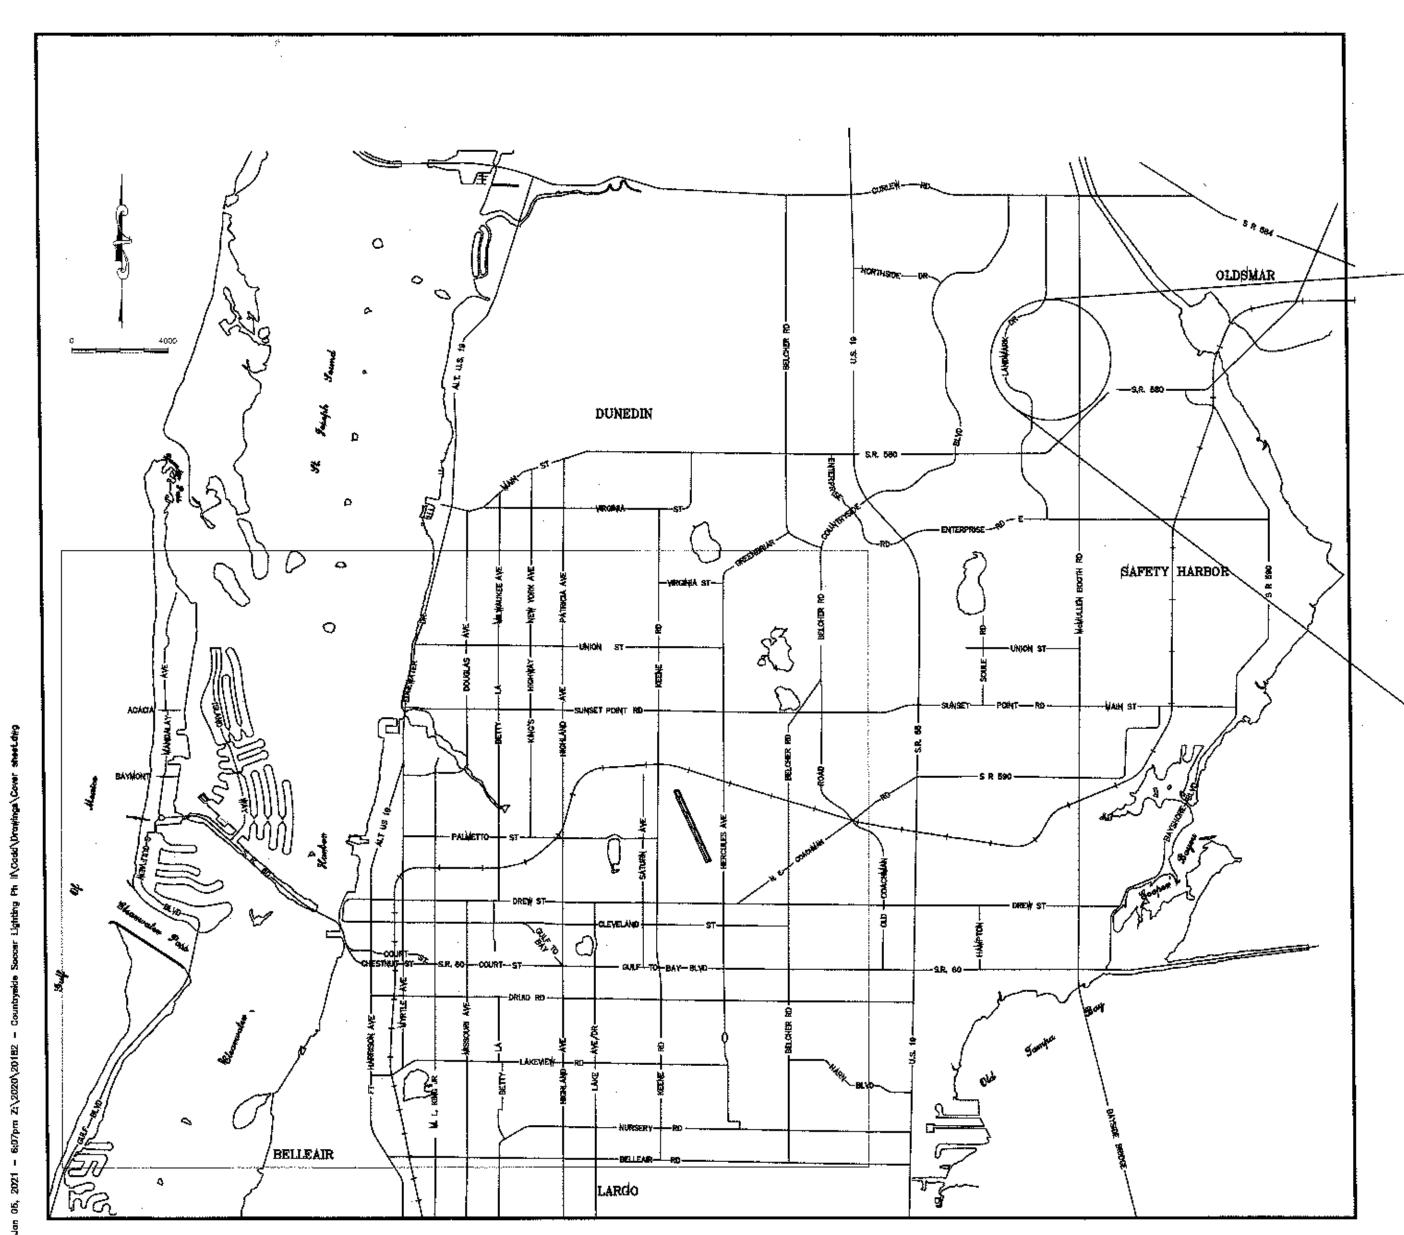

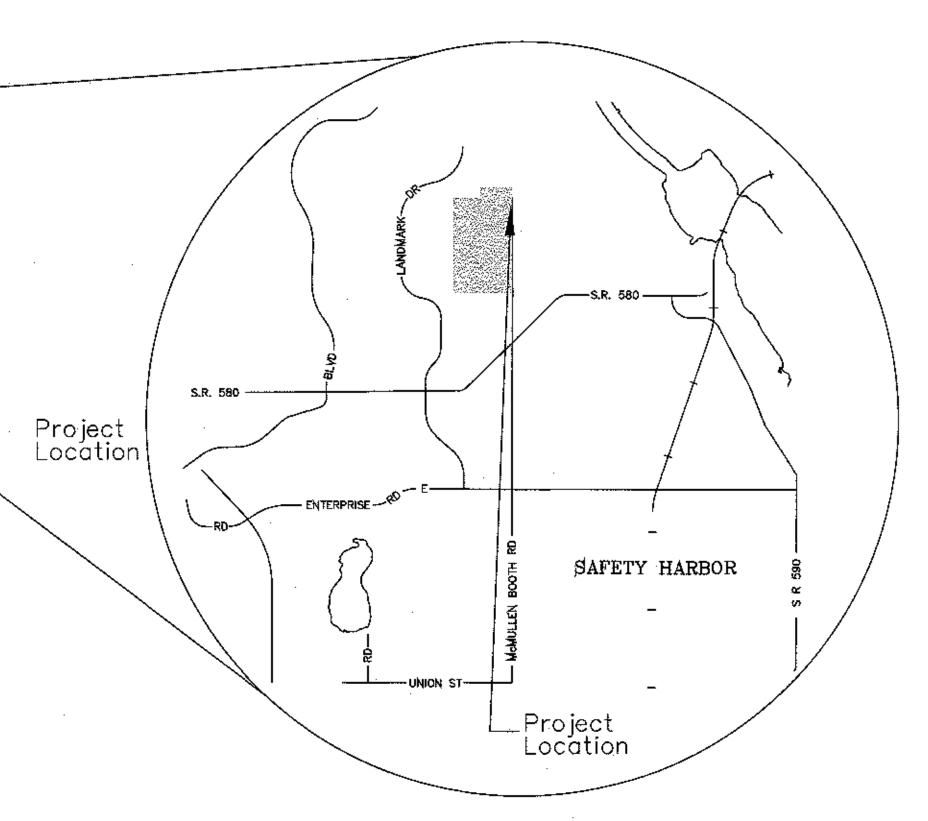

CITY OFFICIALS

Frank Hibbard
Mark Bunker
Kathleen Beckman
David Allbritton
Hoyt Hamilton
William B. Horne II

Mayor Seat 1
Councilmember-Seat 2
Councilmember-Seat 3
Councilmember-Seat 4
Councilmember-Seat 5
City Manager

Tara Kivett, P.E. # 86611 City Engineer RECEIVED BY: J.A.W.

JAN 28 2021

PLANNING & DEVELOPMENT
CITY OF CLEARWATER

Approved For Construction Lity Engineer Tara Kivett, P.E. #86611 Confirm Date

Date 1/27/2021

GRINER ENGINEERING, INC.

1628 First Avenue North
St. Petersburg, Florida 33713
Phone: (727)-822-2335
Fax: (727)-821-3361
Codificate of Authorization (73173)



100% SUBMITTAL

SYMBOL	ELECTRICAL SYMBOL LEGI	END
	DESCRIPTION	MOUNTING
	2 X 2 FLUORESCENT FIXTURE LETTER INDICATES TYPE	SEE FIXTURE SCHEDULE
\Box	2 X 4 FLUORESCENT FIXTURE LETTER INDICATES TYPE	SEE FIXTURE
	SHADING DENOTES FIXTURE WITH EM BATTERY PACK	SCHEDULE SEE FIXTURE
N	'NL' DENOTES FIXTURE UN-SWITCHED FOR NIGHT LIGHT 2 X 4 FLUORESCENT FIXTURE (LETTER INDICATES TYPE)	SCHEDULE SEE FIXTURE
E	SHADING DENOTES FIXTURE FED FROM EMERGENCY SUPPLY	SCHEDULE
$\vdash \hookrightarrow \vdash_{k}$	FLUORESCENT STRIP FIXTURE LETTER INDICATES TYPE	SEE FIXTURE SCHEDULE
哑。	FLUORESCENT WALL BRACKET FIXTURE LETTER INDICATES TYPE	SEE FIXTURE SCHEDULE
OL	RECESSED DOWNLIGHT	SEE FIXTURE
	LETTER INDICATES TYPE EXTERIOR DOWNLIGHT FIXTURE	SCHEDULE SEE FIXTURE
\\\\\\\\\\\\\\\\\\\\\\\\\\\\\\\\\\\\\\	LETTER INDICATES TYPE EXTERIOR WALL MOUNTED FIXTURE	SCHEDULE
\\\\\	LETTER INDICATES TYPE	SEE FIXTURE SCHEDULE
•	INTERIOR PENDANT FIXTURE LETTER INDICATES TYPE	SEE FIXTURE SCHEDULE
•	EXTERIOR SURFACE MOUNT FIXTURE LETTER INDICATES TYPE	SEE FIXTURE SCHEDULE
中	WALL LOW MOUNTED FIXTURE	SEE FIXTURE
	CEILING FAN	SCHEDULE SEE FIXTURE
	EXIT—SHADING DENOTES FACEPLATE LOCATION. LETTER	SCHEDULE
H EX	INDICATES TYPE, PROVIDE ARROWS AS REQUIRED.	SEE FIXTURE SCHEDULE
1≟ x1	DENOTES EMERGENCY WALL PACK, LETTER INDICATES TYPE.	SEE FIXTURE SCHEDULE
$\nabla \nabla \nabla$		SEE FIXTURE SCHEDULE
S S ⁵ D	SINGLE POLE SWITCH (20A-120/277)	48" AFF OR AS
	'3' DENOTES 3-WAY, 'D' DENOTES DIMMER	NOTED
S _T	'T' DENOTES TOGGLE SWITCH	ABOVE CEILING 48" AFF OR AS
os	OCCUPANCY SENSOR	NOTED
Ŝ	LOW VOLTAGE LIGHTING SWITCH	48" AFF OR AS NOTED
<u>.</u>	DUPLEX RECEPTACLE, 125V, 20A 'IG' DENOTES ISOLATED GROUND	18" AFF OR AS NOTED
#	DUPLEX RECEPTACLE, 125V, 20A	18" AFF OR AS
•		NOTED 48" AFF OR AS
	DUPLEX RECEPTACLE, 125V, 20A	NOTED 18" AFF OR AS
#	QUAD RECEPTACLE, 125V, 20A	NOTED
•	SINGLE RECEPTACLE, 208V OR 240V	18" AFF OR AS NOTED
	CEILING MOUNTED COILED REEL EXTENSION RECEPTACLE.	CEILING MOUNTED
⊕ ▼	CEILING/WALL MOUNTED BOX WITH 20A DUPLEX RECEPTACLE.	SEE DETAIL OR
	AND DATA OUTLET.	AS NOTED SEE DETAIL OR
<u>JB</u>	JUNCTION BOX	AS NOTED
Ø	POWER/TELEPHONE POLE	SEE DETAIL OR AS NOTED
☑ ⊙	OUTLET BOX OR J-BOX FOR POWER AND DATA SUPPLY TO FURNITURE SYSTEMS	18" AFF OR AS NOTED
(P)	FLOOR BOX WITH 20A DUPLEX RECEPTACLE. AND DATA OUTLET.	SEE DETAIL OR AS NOTED
V	COMBINATION VOICE/DATA OUTLET	18" AFF OR AS
	DATA OUTLET	NOTED 18" AFF OR AS
-		NOTED 18" AFF OR AS
∇	VOICE OUTLET	NOTED
V	FAX OUTLET	18" AFF OR AS NOTED
CR	CARD READER	COORDINATE WITH SECURITY INSTALLER
sc	SURVEILLANCE CAMERA	COORDINATE WITH
TV		SECURITY INSTALLER 18" AFF OR AS
1.71	T.V. OUTLET	NOTED SEE PANEL
	PANELBOARD 120/208V	SCHEDULE
	PANELBOARD 277/480V	SEE PANEL SCHEDULE
	RACEWAY CONCEALED IN WALL OR ABOVE CEILING	SEE SPECIFICATIONS
	UNDERGROUND OR UNDER FLOOR CONDUIT	SEE SPECIFICATIONS
حملاه	HOMERUN TO PANEL, LETTERS INDICATE PANEL.	SEE ST. CONTONIONS
- ال	NUMBERS INDICATE CIRCUIT. NOTE: HASH MARKS INDICATES THE NUMBER OF WIRES EXCLUDING	SEE SPECIFICATIONS
1	THE REQUIRED EQUIPMENT GROUND.	
)		
/	MOTOR, NUMERAL INDICATES HORSEPOWER	AS NOTED
/ (1)	MOTOR, NUMERAL INDICATES HORSEPOWER MOTOR RATED SWITCH WITH OVERLOAD RELAYS AS REQUIRED.	MOUNTED ADJACENT
) (1) \$	MOTOR RATED SWITCH WITH OVERLOAD	MOUNTED ADJACENT TO EQUIPMENT
\$ □	Motor rated switch with overload Relays as required. Non-fusible safety switch—size as noted	MOUNTED ADJACENT TO EQUIPMENT SEE SPECIFICATIONS
\$	MOTOR RATED SWITCH WITH OVERLOAD RELAYS AS REQUIRED.	MOUNTED ADJACENT TO EQUIPMENT
\$	MOTOR RATED SWITCH WITH OVERLOAD RELAYS AS REQUIRED. NON-FUSIBLE SAFETY SWITCH-SIZE AS NOTED FUSIBLE SAFETY SWITCH-SIZE AS NOTED ALL SYMBOLS SHOWN MAY NOT BE USED.	MOUNTED ADJACENT TO EQUIPMENT SEE SPECIFICATIONS
\$ \$ *NOTE - /	MOTOR RATED SWITCH WITH OVERLOAD RELAYS AS REQUIRED. NON-FUSIBLE SAFETY SWITCH-SIZE AS NOTED FUSIBLE SAFETY SWITCH-SIZE AS NOTED ALL SYMBOLS SHOWN MAY NOT BE USED. ABBREVIATIONS:	MOUNTED ADJACENT TO EQUIPMENT SEE SPECIFICATIONS
\$ *NOTE - AFF - AHU -	MOTOR RATED SWITCH WITH OVERLOAD RELAYS AS REQUIRED. NON-FUSIBLE SAFETY SWITCH-SIZE AS NOTED FUSIBLE SAFETY SWITCH-SIZE AS NOTED ALL SYMBOLS SHOWN MAY NOT BE USED. ABBREVIATIONS: ABOVE FINISHED FLOOR AIR HANDLING UNIT HYAC - HEATING, VE JB - JUNCTION	MOUNTED ADJACENT TO EQUIPMENT SEE SPECIFICATIONS SEE SPECIFICATIONS ENTILATING, AIR CONDITIONING
\$ *NOTE - /	MOTOR RATED SWITCH WITH OVERLOAD RELAYS AS REQUIRED. NON-FUSIBLE SAFETY SWITCH—SIZE AS NOTED FUSIBLE SAFETY SWITCH—SIZE AS NOTED ALL SYMBOLS SHOWN MAY NOT BE USED. ABBREVIATIONS: ABOVE FINISHED FLOOR AIR HANDLING UNIT BELOW FINISHED GRADE CONDUIT MCB — MAIN CIRC	MOUNTED ADJACENT TO EQUIPMENT SEE SPECIFICATIONS SEE SPECIFICATIONS
\$ \$ *NOTE - / AFF - AHU - BFG - C - CW - DACP -	MOTOR RATED SWITCH WITH OVERLOAD RELAYS AS REQUIRED. NON-FUSIBLE SAFETY SWITCH-SIZE AS NOTED FUSIBLE SAFETY SWITCH-SIZE AS NOTED ALL SYMBOLS SHOWN MAY NOT BE USED. ABOVE FINISHED FLOOR AIR HANDLING UNIT BELOW FINISHED GRADE CONDUIT COOL WHITE DOOR ALARM CONTROL PANEL MOTE AS NOTED HVAC - HEATING, VE JB - JUNCTION LRA - LOCKED F MCB - MAIN CIRC MLO - MAIN LUC NOOL WHITE DOOR ALARM CONTROL PANEL	MOUNTED ADJACENT TO EQUIPMENT SEE SPECIFICATIONS SEE SPECIFICATIONS ENTILATING, AIR CONDITIONING BOX ROTOR AMPERES CUIT BREAKER
\$ \$ *NOTE - / AFF - AHU - BFG - CW - DACP - DN - EF - EF	MOTOR RATED SWITCH WITH OVERLOAD RELAYS AS REQUIRED. NON-FUSIBLE SAFETY SWITCH-SIZE AS NOTED FUSIBLE SAFETY SWITCH-SIZE AS NOTED ALL SYMBOLS SHOWN MAY NOT BE USED. ABOVE FINISHED FLOOR AIR HANDLING UNIT BELOW FINISHED GRADE CONDUIT COOL WHITE DOOR ALARM CONTROL PANEL FEED DOWNWARD EXHAUST FAN NOTED HVAC - HEATING, VE JB - JUNCTION LRA - LOCKED F MCB - MAIN CIRC MLO - MAIN LUG N - NEUTRAL NL - NIGHT LIG	MOUNTED ADJACENT TO EQUIPMENT SEE SPECIFICATIONS SEE SPECIFICATIONS ENTILATING, AIR CONDITIONING BOX ROTOR AMPERES CUIT BREAKER SONLY SHT
\$ \$ AFF - AHU - BFG - CW - DACP - DN - EF - EG - ENCL -	MOTOR RATED SWITCH WITH OVERLOAD RELAYS AS REQUIRED. NON-FUSIBLE SAFETY SWITCH-SIZE AS NOTED FUSIBLE SAFETY SWITCH-SIZE AS NOTED ALL SYMBOLS SHOWN MAY NOT BE USED. ABOVE FINISHED FLOOR AIR HANDLING UNIT BELOW FINISHED GRADE CONDUIT COOL WHITE DOOR ALARM CONTROL PANEL FEED DOWNWARD EXHAUST FAN EQUIPMENT GROUND MOTOR ALARM CONTROL PANEL FEED DOWNWARD EXHAUST FAN EQUIPMENT GROUND MOTOR ALARM CONTROL PANEL N - NEUTRAL NL - NIGHT LIG OB - OUTLET BE PB - PULL BOY	MOUNTED ADJACENT TO EQUIPMENT SEE SPECIFICATIONS SEE SPECIFICATIONS ENTILATING, AIR CONDITIONING BOX ROTOR AMPERES CUIT BREAKER ES ONLY SHT BOX K, PUSH—BUTTON
\$ \$ AFF - AHU - BFG - CW - DACP - DACP - EG - EWC - EWC - EWC - EWH -	MOTOR RATED SWITCH WITH OVERLOAD RELAYS AS REQUIRED. NON-FUSIBLE SAFETY SWITCH-SIZE AS NOTED FUSIBLE SAFETY SWITCH-SIZE AS NOTED ALL SYMBOLS SHOWN MAY NOT BE USED. ABOVE FINISHED FLOOR AIR HANDLING UNIT BELOW FINISHED GRADE CONDUIT COOL WHITE DOOR ALARM CONTROL PANEL FEED DOWNWARD EXHAUST FAN EQUIPMENT GROUND MOTOR AS NOTED HVAC - HEATING, VE JB - JUNCTION LRA - LOCKED F MCB - MAIN CIRC MLO - MAIN LUG N - NEUTRAL NL - NIGHT LIG OB - OUTLET B DOB - DILLE BO	MOUNTED ADJACENT TO EQUIPMENT SEE SPECIFICATIONS SEE SPECIFICATIONS ENTILATING, AIR CONDITIONING BOX ROTOR AMPERES CUIT BREAKER SONLY SHT BOX K, PUSH—BUTTON ION

TELEVISION TERMINAL BOARD UNLESS NOTED OTHERWISE FRACTIONAL HORSEPOWER FULL LOAD AMPERES GROUND FAULT INTERRUPTER VERTICAL HIGH INTENSITY DISCHARGE WATT MISER HORIZ - HORIZONTAL WEATHERPROOF IG - ISOLATED GROUND TRANSFORMER LIGHT WHITE HORSEPOWER, HEAT PUMP N.I.C - NOT INCONTRACT

ALL MOUNTING HEIGHTS SHOWN ARE TO THE TOP OF THE DEVICE UNLESS NOTED OTHERWIS NOT ALL SYMBOLS APPEAR ON PLANS.

ELECTRICAL GENERAL NOTES:

- ALL WORK SHALL CONFORM TO THE REQUIREMENTS OF THE FLORIDA BUILDING CODE 2020 (7TH EDITION) -NATIONAL ELECTRIC CODE 2017, NFPA 70. NFPA 101 & NFPA 72 (CURRENT ADOPTED EDITIONS). ANY OTHER APPLICABLE CODE REFERENCES AND ALL LOCAL ORDINANCES.
- BIDDERS ARE TO VISIT THE SITE AND FAMILIARIZE THEMSELVES WITH EXISTING CONDITIONS AND SATISFY THEMSELVES AS TO THE NATURE AND SCOPE OF WORK AND THE EXTENT OF DEMOLITION. THE SUBMISSION OF A BID WILL BE EVIDENCED THAT SUCH AN EXAMINATION HAS BEEN MADE. LATER CLAIMS FOR LABOR. EQUIPMENT OR MATERIALS REQUIRED, OR FOR DIFFICULTIES ENCOUNTERED WHICH COULD HAVE BEEN FORESEEN HAD AN EXAMINATION BEEN MADE, WILL NOT BE ALLOWED.
- ELECTRICAL CONTRACTOR SHALL BE EXPERIENCED IN PERFORMING AND INSTALLATION OF WORK SIMILAR TO THAT REQUIRED FOR THIS PROJECT. THE CONTRACTOR SHALL SUBMIT A LIST OF AT LEAST FIVE PROJECTS THAT THEY BEEN CONTRACTED AND COMPLETED CONSTRUCTION WITH SIMILAR PROJECT SCOPE OF WORK.
- PRIOR TO SUBMITTING A BID, THE CONTRACTOR SHALL HAVE STUDIED AND COMPARED THE CONTRACT DOCUMENTS WITH EXISTING/PROPOSED CONDITIONS AND NOT LATER THAN TEN (10) DAYS PRIOR TO THE BID OPENING SHALL REPORT TO THE ENGINEER ANY ERROR, INCONSISTENCY, OR OMISSION IN THE CONTRACT
- ELECTRICAL EQUIPMENT SHALL BE AS SPECIFIED. ARCHITECT AND ENGINEER WILL REVIEW ANY SUBSTITUTION FOR COMPATIBILITY.
- 6. ALL CUTTING, REMOVING AND REPLACING CONCRETE WORK SHALL BE THE RESPONSIBILITY OF THIS TRADE.
- PROTECT ELECTRICAL EQUIPMENT AND INSTALLATIONS AS NECESSARY. IF DAMAGED OR DISTURBED IN THE COURSE OF THE WORK, REMOVE DAMAGED PORTIONS AND INSTALL NEW PRODUCTS OF EQUAL CAPACITY, QUALITY,
- 3. THE CONTRACTOR SHALL INCLUDE WITHIN THE BID ALL REQUIRED OFF HOUR, OVERTIME, AND NON-BUSINESS HOUR WORK AS REQUIRED.
- ALL WORK SHALL BE COORDINATED WITH OTHER TRADES FOR ITEMS IN THEIR SCOPE OF WORK WHICH WOULD REQUIRE ELECTRICAL WORK (DISCONNECTION/RECONNECTION ETC.) AND ARE NOT INDICATED ON THE ELECTRICAL PLANS, ALL SUBCONTRACTORS ARE REQUIRED TO COORDINATE THEIR WORK WITH OTHER TRADES, LACK OF THIS COORDINATION RESULTING IN ADDED COST TO THE CONTRACT WILL BE BORNE BY THE CONTRACTOR OF THIS
-). THE CONTRACTOR SHALL PROVIDE SHOP DRAWINGS AND SUBMITTALS FOR ELECTRICAL EQUIPMENT SHOWN ON THE PLANS AND SPECIFICATIONS FOR THE ENGINEERS APPROVAL. THE ENGINEER MAY REQUIRE THE CONTRACTOR TO REDO ANY WORK, WHICH WAS NOT APPROVED, OR THE ENGINEER MAY REQUIRE A CREDIT TO THE OWNER. PROVIDE A SET OF AS-BUILT AFTER THE JOB IS COMPLETED. THIS SET SHALL BE CONTINUOUSLY UPDATED
- PROVIDE IDENTIFICATION FOR ALL LIGHT FIXTURES AND ALL ELECTRICAL COVER PLATES WITH PERMANENT MARKER ON A SELF-ADHERING TAG INDICATING PANEL AND CIRCUIT NUMBER. TYPICAL FOR ALL LIGHTING AND POWER
- 12. ALL WORK SHALL BE PERFORMED DURING TIME PERIODS ACCEPTABLE TO THE OWNER, SCHEDULE ALL WORK WITH THE OWNER'S REPRESENTATIVE BEFORE PROCEEDING.
- 13. THE CONTRACTOR SHALL PERFORM ALL TEMPORARY WORK NECESSARY TO MAINTAIN CONTINUITY OF ELECTRICAL SERVICE (LIKE SAWPOLE SERVICE) WHEN CONNECTION IS MADE. THIS SERVICE SHALL NOT BE INTERRUPTED WITHOUT PRIOR CONSENT OF THE OWNER'S REPRESENTATIVE AND MAY BE INTERRUPTED ONLY AT AND FOR THE SPECIFIED TIME DESIGNATED BY OWNER'S REPRESENTATIVE. THE CONTRACTOR SHALL BE GUIDED BY THE OWNER'S REPRESENTATIVE AT ALL TIMES IN MATTERS AFFECTING THE FACILITIES.
- 4. THE CONTRACTOR SHALL COORDINATE ALL PHASING OF ELECTRICAL WORK AS REQUIRED AND INDICATED ON THE ELECTRICAL DRAWINGS.
- 5. THE OWNER PROJECT REPRESENTATIVE SHALL BE NOTIFIED PRIOR TO CUTTING OF ANY STRUCTURAL ITEM (I.E. CONCRETE FLOOR, MASONRY, WALL, ETC.) WITHIN THE EXISTING BUILDING. METHOD OF CUTTING SHALL BE APPROVED BY THE OWNER PROJECT REPRESENTATIVE.
- 16. CONTRACTOR SHALL BE RESPONSIBLE FOR KEEPING THE BUILDING WATERTIGHT DURING CONSTRUCTION.
- 7. ALL WIRING IN CEILING SPACE OR IN AIR HANDLING PLENUMS NOT IN CONDUIT SHALL BE UL LISTED AS SUITABLE FOR PLENUM USE.
- 18. ALL JUNCTION BOXES AND COVER PLATES SHALL BE PAINTED AND LABELED.
- 19. ALL RECEPTACLES WITHIN (6) FEET OF PLUMBING FIXTURES SHALL BE PROVIDED WITH 5 MILLIAMP GROUND FAULT INTERRUPTERS. (GFCI RECEPTACLES)
- 20. EXIT SIGNS AND ALL EMERGENCY LIGHTING SHALL BE WIRED AHEAD OF ANY SWITCHING OR CONTACTORS. DO NOT SWITCH EXIT SIGNS OR EMERGENCY NIGHT LIGHTS. CONTRACTOR SHALL PROVIDE AN UNSWITCHED HOT TO BYPASS ANY SWITCHING AND/OR CONTRACTORS FOR ALL SWITCHED EMERGENCY LIGHTING.
- 21. EDGE OF LIGHT SWITCH WALL PLATE SHALL BE NOT MORE THAN 4" AWAY FROM METAL/WOOD DOOR FRAME. TYPICAL FOR SINGLE OR MULTIPLE WALL SWITCHES.
- 22. CONFIRM MOUNTING HEIGHTS AND COORDINATE LOCATION OF ALL OUTLETS, SWITCHES, AND OTHER DEVICES WITH ARCHITECTURAL ELEVATIONS (FURNITURE LAYOUT) PRIOR TO ROUGH-IN.
- 23. PROVIDE SEAL FOR PENETRATION OF FIRE RATED WALLS BY CONDUIT.
- 24. BACK TO BACK RECEPTACLES IN ALL ONE HOUR FIRE RATED WALLS SHALL BE LOCATED A MINIMUM OF 24" ON
- 25. BRANCH CIRCUIT CONDUCTORS SHALL NOT BE SMALLER THAN NO. 12 AND WHERE BRANCH CIRCUIT CONDUCTOR RUNS FROM SOURCE (PANEL) TO THE LAST DEVICE ON THE CIRCUIT EXCEEDS 75 FT. IN LENGTH, THE CONDUCTORS SHALL BE NO. 10 MINIMUM AND FOR THE ENTIRE LENGTH OF THE CIRCUIT, FOR RUNS OVER 150 FT. IN LENGTH THE CONDUCTOR SHALL BE NO. 8 MINIMUM AND FOR THE ENTIRE LENGTH OF THE CIRCUIT. THE ABOVE APPLIES TO 120 VOLT CIRCUITS ONLY.
- . THE CONTRACTOR SHALL COORDINATE WITH THE OWNER THE REMOVAL AND DISPOSAL OF ALL ELECTRICAL MATERIAL WHICH IS NOT TO BE USED ON THE PROJECT. CONTRACTOR SHALL REMOVE AND STORE ANY ELECTRICAL MATERIAL IF SO DIRECTED BY OWNER. PATCH AND PAINT WALLS AND CEILINGS AS REQUIRED. THE CONTRACTOR SHALL COORDINATE INSTALLATION OF NEW LIGHTING FIXTURES, RECEPTACLES, PANEL BOARDS, ETC. WITH EXISTING STRUCTURE, PIPING, ETC. AND MAKE ADJUSTMENTS AS REQUIRED.
- 27. REFER TO ELECTRICAL SPECIFICATIONS SHEET FOR REQUIREMENTS.
- 28. UPON COMPLETION OF THE WORK, THE CONTRACTOR SHALL INSURE THAT ALL SYSTEMS OPERATE AS DESIGNED AND REQUIRED AND SHALL REVIEW THEIR OPERATION WITH THE OWNER AND PROVIDE TRAINING OF THE MAINTENANCE PERSONNEL. COMPLETE 5 SETS OF AS-BUILT DRAWINGS SHALL BE COMPILED (BY THE CONTRACTOR) AND ISSUED (1 EACH) TO THE ARCHITECT AND BUILDING MAINTENANCE PERSONNEL UPON COMPLETION OF CONSTRUCTION AND TESTING. PROVIDE 3 FLASH DRIVE OF 'AS'-BUILT TO THE OWNER.
- 29. ALL FEEDERS SIZING (BRANCH AND SERVICE ENTRANCE CONDUCTORS) BASED IN AMPACITY OF COPPER THHW CONDUCTORS (NEC 2017 TABLE 310.15(B)(16)) UNLESS OTHERWISE NOTED.
- 30. THE PRIMARY POWER SOURCE FOR SMOKE ALARMS IN DWELLING UNITS SHALL BE REQUIRED TO BE AFCI-PROTECTED FOLLOWING NFPA 72 AND NEC 2017 ART. 210.12.
- 31. RECEPTACLES LOCATED IN DORMITORIES AND LIVING AREAS OF ALL DWELLING UNITS SHALL BE AFCI PROTECTED.
- 32. MINIMUM SERVICE INTERRUPTION OF EXISTING FIELD SHALL BE KEPT TO A MINIMUM, EXISTING TRANSFORMER SHALL REMAIN OPERATIONAL UNTIL NEW TRANSFORMER IS IN PLACE AND SWITCHOVER SHALL OCCUR WITHIN 24 HRS BETWEEN SHUT DOWN & START UP OF NEW POLE & SERVICES.

NATIONAL ELECTRIC CODE NOTES:

ALL WORK SHALL CONFORM TO THE REQUIREMENTS OF NFPA 70 -2017 NATIONAL ELECTRIC CODE

ELECTRICAL SUBMITTAL NOTES:

REVISION

SUBMIT ALL ELECTRICAL SYSTEMS SUBMITTALS AT ONE (1) TIME IN ONE (1) INTEGRAL GROUP. PIECE-BY-PIECE SUBMISSION OF INDIVIDUAL ITEMS WILL NOT BE ACCEPTABLE. ENGINEER MAY CHECK CONTENTS OF EACH SUBMITTA SET UPON INITIAL DELIVERY; IF NOT COMPLETE AS SET FORTH HEREIN, SUBMITTAL SETS MAY BE RETURNED TO CONTRACTOR WITHOUT REVIEW AND APPROVAL AND WILL NOT BE ACCEPTED UNTIL MADE COMPLETE. SHOP DRAWINGS WILL BE REVIEWED MAXIMUM TWICE AS PART OF THIS CONTRACT. ADDITIONAL SHOP DRAWING REVIEWS SHALL BE INVOICED AT \$85.00 PER HOUR, BILLABLE TO THE SUB-CONTRACTOR.

LIGHTING DESIGN SUMMARY

Countryside Field 2 Redesign November 10, 2020

DESIGN OBJECTIVE: Increase soccer field size from 330' x 200' (66,000 sq. ft) to 360 x 225

(81,000 sq. ft). Light to 30fc Minimum

CONDITIONS:

Existing poles (S5 & S6) were installed and designed in 2011 Poles were designed using FBC 2007, 130mph, AASHTO standards

They each have 7 fixtures each Poles are to be moved east.

The existing FBC (2017) uses 150mph, ASCE standards

Using current FBC, S5 & S6 will only handle 4 fixtures each.

S5 & S6 will be removed. They currently have 7 fixtures each New bases will be supplied and these existing poles will be re-installed

with 4 fixtures per pole

The remaining (3) fixtures per pole are to be moved and re-used on

new pole P8.

An additional 6 fixtures will be supplied to be attached to pole P8 for a total of 12 total fixtures on this pole

Pole P4 will be added with 13 fixtures.

Pole P3 (existing) will have 14 fixtures added

EQUIPMENT

SCOPE OF WORK


1 x 70'mh Steel pole & base (P8) 1 x 80'mh Steel pole & base (P4)

2 new bases for relocation of existing 2 poles (S5 & S6)

33 New fixtures

Re-use 6 existing fixtures (moved to P8)

Musco Sports Lighting * 2220 Cluster Oak Dr. #H * Clermont, FL 34711 Telephone (352) 243-9999 * Fax (352) 243-2791

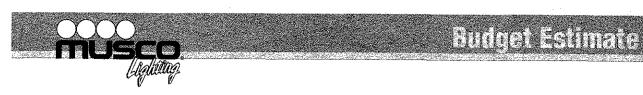

COUNTRYSIDE SOCCER REDESIGN Field 2 Date: November 17, 2020

Field Description: Based on Musco lighting design 189038B

Light Structure Green™ System delivered to your site in Five Easy Pieces™

- 4 x Pre-cast concrete bases 1 x galvanized <u>70'mh</u> steel poles (P8)
- 1 x galvanized <u>80'mh</u> steel poles (P4)
- UL Listed remote electrical component enclosure & Pole length wire harness
- 33 x Factory-aimed and assembled luminaires

Also Includes:

- Energy savings of more than 50% over a standard lighting system
- 50% less spill and glare light than Musco's prior industry leading technology
- Musco C10 Warranty and maintenance

Materials (Poles & Fixtures)

Musco's Light Structure Cluster Green™ as described above and delivered to the job site <u>\$132,200.00</u>

- Sales tax is not included as part of this budget estimate.
- Materials Only

Pole P8 will be added Pole P4 will be added Existing poles S5 & S6 will be moved New bases for these poles will be supplied Three fixtures from each existing poles S5 & S6 will be added to new poles P8 Remaining fixtures for poles S5 & S6 will be re-aimed while on the ground Fixtures to be attached to existing pole P3 will be added

Pricing furnished is considered confidential. Divulging technical or pricing information to competitive vendors will result in removal from the bid list.

Robert A. DeCouto

THE ELECTRICAL CONTRACTOR SHALL PROVIDE ALL OTHER ELECTRICAL ITEMS TO PROVIDE A COMPLETE OPERATIONAL SPORT LIGHTING SYSTEM TO THE SATISFACTION OF THE OWNER WITH A 3 FOOT CANDLE MINIMUM AFTER BURN IN OF THE LAMPS.

DRAWING INDEX

	SHEET NUMBER	DRAWING TITLE
I	EO	ELECTRICAL NOTES, LEGEND & & PROJECT SCOPE
ı	E1	ELECTRICAL EXISTING CONDITION - DEMO PLAN
	E2	PROPOSED ELECTRICAL SITE PLAN
ı	. E3	ELECTRICAL YARD AND PANEL SCHEDULES
İ	E4	REVISED ELECTRICAL RISER DIAGRAM
I	E5	PHOTOMETRIC PERFORMANCE DATA

AS BUILT PHASE I DRAWINGS HAS ALSO BEEN INCLUDED IN THIS PACKAGE

DRAWING INDEX AS BUILT PHASE I

1		
	SHEET NUMBER	DRAWING TITLE
	E0	ELECTRICAL COVER SHEET
	E1	ELECTRICAL EXISTING CONDITION - DEMO PLAN
	E2	ELECTRICAL SITE PLAN
	E3	ELECTRICAL YARD AND SCHEDULES
	E4	REVISED ELECTRICAL RISER DIAGRAM
	E5	PHOTOMETRIC PERFORMANCE DATA

PROJECT COORDINATION NOTES:

- ALL BURIED ELECTRICAL WIRES SHALL HAVE WATER PROOF CONNECTORS & 2 EXTRA FEET OF CONDUCTORS COILED IN AN ELECTRICAL GROUND BOX. INSIDE ELECTRICAL GROUND BOXES, CONDUIT BOXES ELECTRICAL ELBOWS SHALL BE PROVIDED AT END OF ELECTRICAL CONDUITS. MATERIAL SUBMITTAL SHALL BE PROVIDED TO OWNER/ELECTRICAL CONSULTANT FOR REVIEW.
- ALL BURIED CONDUITS/SLEEVES AND ELECTRICAL BOXES SHALL HAVE 'AS BUILT' DRAWINGS DEVELOPED IDENTIFYING LOCATION FOR FUTURE LOCATIONS- AS BUILT DRAWINGS SHALL BE REVIEWED IN THE FIELD WITH OWNER/ELECTRICAL CONTRACTOR/ELECTRICAL CONSULTANT TO DETERMINE ACCURACY OF 'AS BUILT' DRAWINGS BEFORE FINAL HANDOVER OF PROJECT TO OWNER
- 6 FEET HIGH TEMPORARY CONSTRUCTION FENCE SHALL BE PLACED ON STANDS AT 20 FEET WEST OF EXISTING LIGHT POLES THAT ARE TO BE REMOVED. SEE SHEET # 2 (DEMO PLAN) FOR REFERENCE ON THE LOCATION OF THE 6 FEET TEMPORARY FENCE. FENCE PANELS SHALL BE PROVIDED BY THE OWNER FOR CONTRACTOR TO INSTALL AT BEGINNING OF PROJECT AND REMOVE AT THE END OF PROJECT. CONTRACTOR SHALL REMOVE AND RESTACK ON OWNER'S PROVIDED TRAILER.
- ALL OTHER ELECTRICAL ITEMS NOT PROVIDED BY MUSCO SHALL BE PROVIDED BY THE CONTRACTOR IN PROVIDING A COMPLETE OPERABLE SPORT LIGHTING SYSTEM TO THE SATISFACTION OF THE OWNER.

RECEIVED BY: J.A.W

JAN 28 2021 PLANNING & DEVELOPMENT CITY OF CLEARWATER

> CALL 81 SUNSHINE STATE ONE CALL OF FLORIDA www.callsunshine.com (800) 432-4770 MIN. 48 HOURS

> > DATE

RECORD DRAWINGS SURVEYED BY DRAWN BY EVIEWED BY PROJECT ENGINEER DATE APPROVED BY CITY ENGINEER MICHAEL D. QUILLEN, P.E. # 33721 DATE



CITY OF CLEARWATER, FLORIDA PARKS & RECREATION DEPT. 100 S. Myrtle Ave. Clearwater, Fl 33756



St. Petersburg, Florida 33713

Phone: (727)-822-2335

Fax: (727)-821-3361

Certificate of Authorization #3

A. Role

JAR

JAR

20182


Designed


Job no.

COUNTRYSIDE SPORTS COMPLEX FIELD 2 RENOVATION

DRAWN BY	SK/JAR	DES/PJLIGNED BY	CHECKED BY JAR	CLEARWATER CONTRACT
SCALE VERT.	NONE	SURVEYED BY Clearwater	воок но.	CLEARWATER JOB NO.
HORIZ.	1"=N/A	Date Drawn Dec 04, 2020	DWG NAME 2020-XXXX	SHEET NO.

JOSE A ROSARIO, P.E. 74457

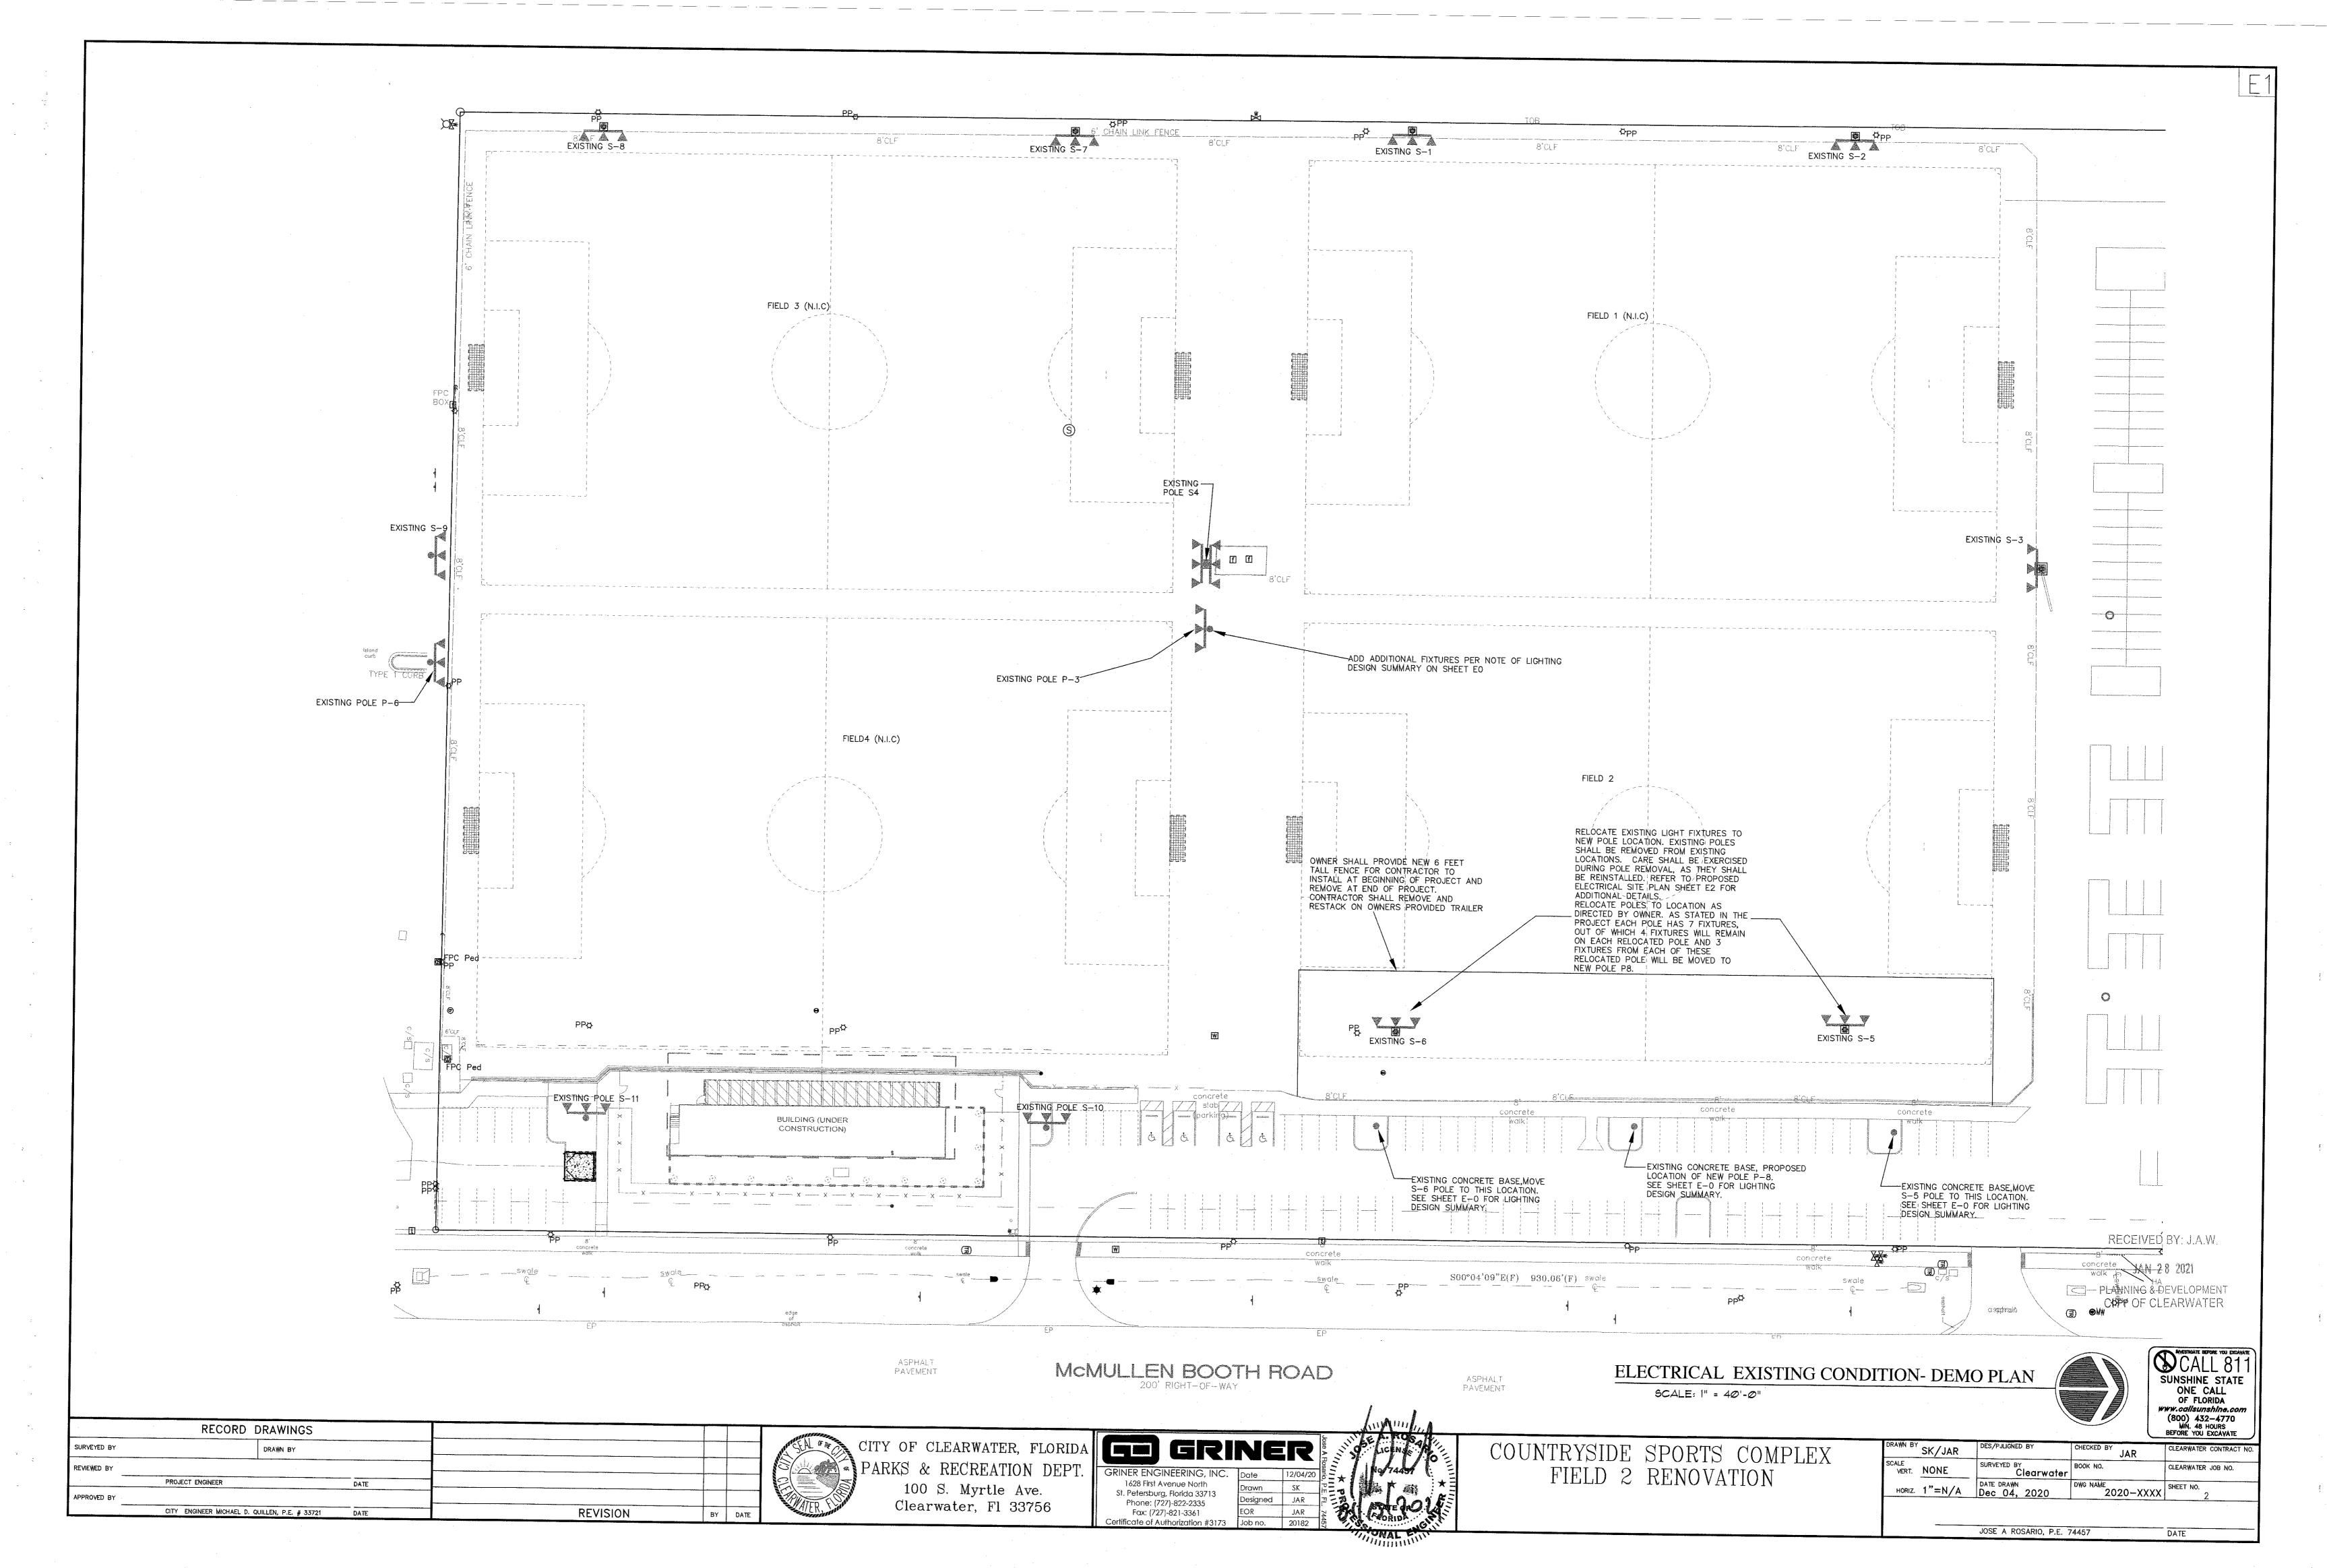

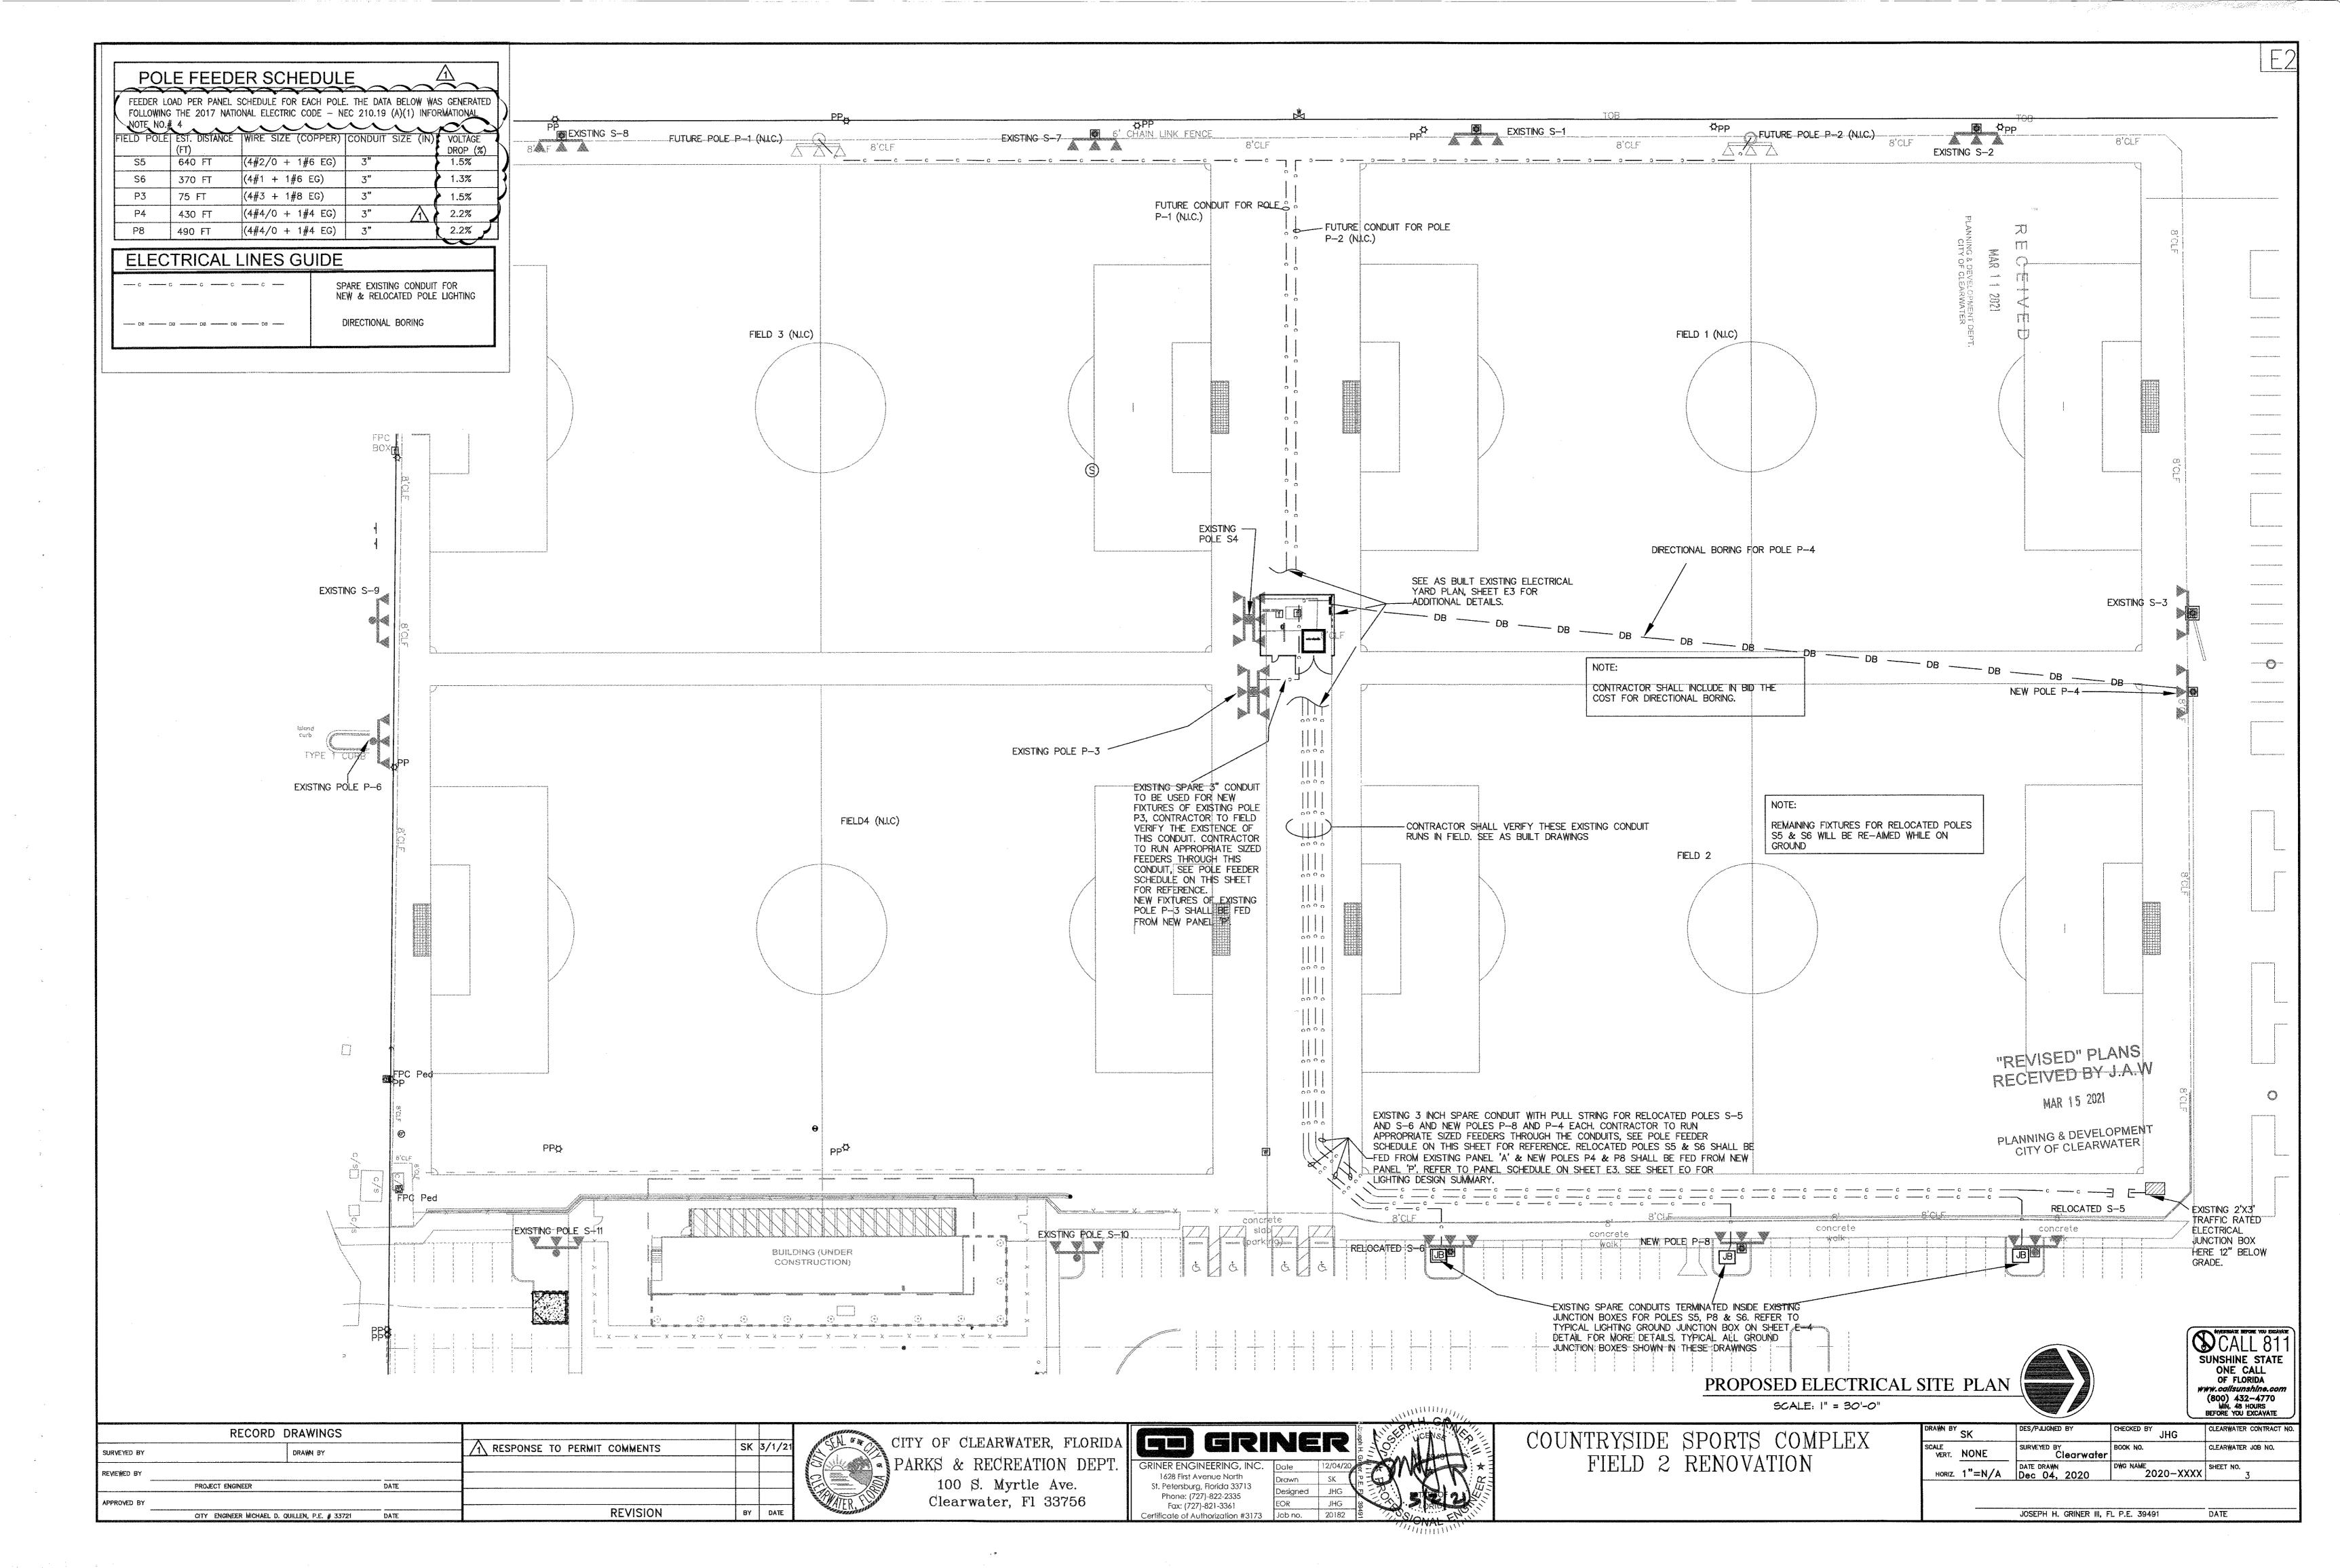

400 MCB

EXISTIN 'A'	IG P	ANEL		SURFACE MOUNTED 120/208 VOLT 3 PHASE 4 WIRE WITH GROUND																MCB '208V,	75C°
																				FY EX.	
WIR C	DNC			·		3REAK									BREAKE				1	COND.	1 1
E.		TYPE	NO.	DESCRIPTION	TRIP	POLE	VOLT	Λ	<u> </u>	Į į	3		С	VOLT	POLE	TRIP	DESCRIPTION		TYPE	SIZE	SIZE
		<u> </u>	1											1				2	<u> </u>		
			3	EX POLE S1	60	3	208							208	3.	100	EX POLE S3	4	L		
		<u>L</u>	5					8 8 8 8 8 8 8 8 8 8 8 8 8 8 8 8 8 8 8	<u> </u>	4					1			6	L	·	
		L	7							(1/1/1/1/2	1							8		 	
		<u> </u>	9	EX POLE S2	60	3	208				<u> </u>		r	208	3	100	EX POLE S4	10			
		L	11						(*********						1		TY OO AND ORDONET	12			
			13	EX 60 AMP CIRCUIT	60	2	208				1	4		120	 	20	EX 20 AMP CIRCUIT	14	<u> </u>		
			15		0.0	 	400				<u> </u>	1111111	7 / / / / / / / / / / / / / / / / / / /	120	<u> </u>	20	EX 20 AMP CIRCUIT	16	L	·	
			17	EX 20 AMP CIRCUIT	20	1	120		(4///////		1		120		20	EX 20 AMP CIRCUIT	18	L	 	
		L.	19	DELOCATED DATE CE		-	300			122222	<u> </u>			120	7	40	RELOCATED POLE S6	20	_		
ļ		<u> </u>	21	RELOCATED POLE S5	40	3	208				<u> </u>		T	120	.3	40	RELOCATED POLE 56	22	<u> </u>		
	<u> </u>	L.	23	EV CO MIC OLOCUIT	30	4	130	0.00.00.00.00.00.00.00.00.00.00.00.00.0		4////				100	1	20	EX 20 AMP CIRCUIT	26	L.	 	
			25 27	EX 20 AMP CIRCUIT	20 20	1	120				1	4		120	•	20	EX 20 AMF CIRCOII	28			
-			29	EX 20 AMP CIRCUIT	20	1	120			 	<u> </u>		l ·	1	-			$\frac{20}{30}$,	<u> </u>	
-	······································		31				<u> </u>		<i>/////////////////////////////////////</i>	1				ļ				32		<u> </u>	
-			33		<u> </u>		<u> </u>				<u> </u>	}		 				34			
<u> </u>			35						14441		1		T T					36			
-			37						<i>(//////</i> 	4//////								38			
			39						<u> </u>	1 1 1 1 1 1 1 1 1 1 1 1 1 1 1 1 1 1 1	1			208	3		SURGE PROTECTION	40	<u></u>		-
			41							4-7-7-7-7	I		 	2.00				42			-
······································	······································		** 1	CON	JECTE	ED VA		Chille H. H. K. K.	0		0		0			1		1 72	<u> </u>		<u></u>
				CONNECTE					0		0		0	4							
						LANC			33.33%	1	33.33%		33.33%	100%		Pofor	to Electrical Load Su		rv on	thie	7
		LOAD	TYPE					CONNEC				DEMAN		-	7			HHIG	. i y O : i	11113	
				TING	1				1 0		1.25		0	VA	1	sheet					
}				PTACLES	1				0		1	1	0	VA							
				CONDITIONING	1				0		0	1	0	VA							
			HEA		1				0		0		0	VA							
				. NON-CONTINUOUS	1				0		†	1	0	VA	İ						
				TINUOUS	1				0	1	1.25	1	0	VA	1						
			KITC		1				0	il .	0.65	1	0	VA							
					1					1	TOTAL	1	0	VA		L					
			· · · · · · ·	1	1			120/20	8V, 3 F	PHASE				AMPS	1.00	P.F. C	ORRECTION				
									·····				4								

LOAD SUMMARY OF EXISTING PANEL 'A':

- NO NEW LOADS ADDED FOR EXISTING PANEL
- INSTEAD, 3 FIXTURES HAS BEEN REDUCED FROM EACH RELOCATED POLES S5 & S6 - HENCE THERE WOULD BE OVERALL DECREASE IN LOAD FOR PANEL 'A'

NOTES FOR PANEL 'A':

BOTH THE 60 AMP BREAKERS FOR POLES S5 AND S6 SHALL BE REPLACED BY 3 POLE 40 AMP BREAKERS. THE NEW 40 AMP BREAKERS SHALL MATCH THE MANUFACTURER & AIC RATING OF PANEL

SITE PLAN GENERAL NOTES:

- 1. THIS CONTRACTOR SHALL REFER TO THE SITE UTILITIES PLAN FOR LOCATING ANY UNDERGROUND UTILITIES PRIOR TO THE COMMENCEMENT OF WORK.
- BURIED UTILITIES AND/OR STRUCTURES MAY EXISTS ON THIS SITE. EXTREME CAUTION MUST BE USED IN ANY WORK WHICH MAY CONFLICT WITH ANY UNDERGROUND UTILITIES OR STRUCTURES, COORDINATE WITH OWNER.
- 3. ANY CONFLICTS SHOULD BE RESOLVED IN WRITING WITH THE CIVIL ENGINEER AND GENERAL CONTRACTOR BEFORE PRECEDING WITH ANY UNDERGROUND ACTIVITY.
- 4. ALL EXCAVATION FOR THE ELECTRICAL WORK ON THIS SHEET SHALL BE DONE EXERCISING CAUTION AND BE WATCHFUL OF UNEXPECTED ITEMS.

COORDINATED WITHIN 24 HOURS OF DOWN TIME & ADVANCE NOTICE IN CONSTRUCTION SCHEDULE & PROGRESS MEETINGS. COORDINATE WITH OWNER PROGRAM STAFF.

- CONTRACTOR TO SAFELY REMOVE EXISTING, LIGHTING POLES, FIXTURES, WIRING AND CONDUITS TO THE NEAREST POINT OF CONNECTION. CONTRACTOR WILL SAFELY STORE ALL REMOVED ITEMS AND DISPOSE OF THEM.
- CONTRACTOR SHALL BE RESPONSIBLE FOR SCHEDULING WORK WHILE KEEPING THE FUNCTIONALITY OF THE FIELD FACILITIES AT ALL TIMES, POWER SHUTDOWNS SHALL BE COORDINATED WITH THE CITY & ONLY AS SWITCHOVER. PREPARATION WORK SHALL BE PERFORMED IN ADVANCE IN ORDER TO MINIMIZE DOWN TIME DUE TO ELECTRICAL POWER SHUT DOWN.
- DIMENSION OF ELECTRICAL GEAR SHALL BE FIELD VERIFIED PRIOR ELECTRICAL ROUGH IN. IN CASE ANY ISSUES ARE FOUND, THE EOR/OWNER SHALL BE NOTIFIED IN WRITING AND A SOLUTION SHALL BE APPROVED PRIOR ROUGH IN COMMENCEMENT.
- EXISTING PLAY FIELD SHALL CONTINUE WITH ITS PROGRAMMED ACTIVITIES. DISRUPTION SHALL BE KEPT TO A MINIMUM. SWITCHOVER TO NEW TRANSFORMER FROM EXISTING SHALL BE

REVISED LOAD SUMMARY

DECREASE IN LO INCREASE IN LOA

PER AS BUILT PHASE I DRAWINGS EXISTING 800 AMP FEEDERS WERE RUN FROM THE EXISTING WIREWAY FEEDING EXISTING PANEL 'L' AND NEW PANEL 'P'.

DAD ON EXISTING PANEL A		12 KVA OR 35 AMP (120/208V, 3 PHASE)
AD ON NEW PANEL 'P'	*******************	104.5 KVA OR 291 AMP (120/208V, 3 PHASE)
PHASE I DRAWINGS EXISTING	800 AMP FEFDER	S WERE RUN FROM THE EXISTING TRANSFORMER

RECORD DRAWINGS SURVEYED BY DRAWN BY REVIEWED BY APPROVED BY REVISION CITY ENGINEER MICHAEL D. QUILLEN, P.E. # 33721 DATE



CITY OF CLEARWATER, FLORIDA PARKS & RECREATION DEPT. 100 S. Myrtle Ave. Clearwater, Fl 33756

de Tarte				description and anomaly	-
***************************************	CO CRI	NE		Jose A Ros	
2000000000	GRINER ENGINEERING, INC.	Date	12/04/20	<u>₽</u> = ★	
Scottle State	1628 First Avenue North	Drawn	SK	m - W	į
	St. Petersburg, Florida 33713 Phone: (727)-822-2335	Designed	JAR	7	Ş

Fax: (727)-821-3361

Certificate of Authorization #3173 Job no.

SCALE: 1/4" = 1'-0"


NEW PANEL


SURFACE MOUNTED

ENLARGED REVISED ELECTRICAL YARD PLAN

COUNTRYSIDE SPORTS COMPLEX FIELD 2 RENOVATION


RAWN BY SK/JAR VERT. NONE HORIZ. 1"=N/A DATE DRAWN
Dec 04. 2020 WG NAME 2020-XXXX SHEET NO. JOSE A ROSARIO, P.E. 74457 DATE

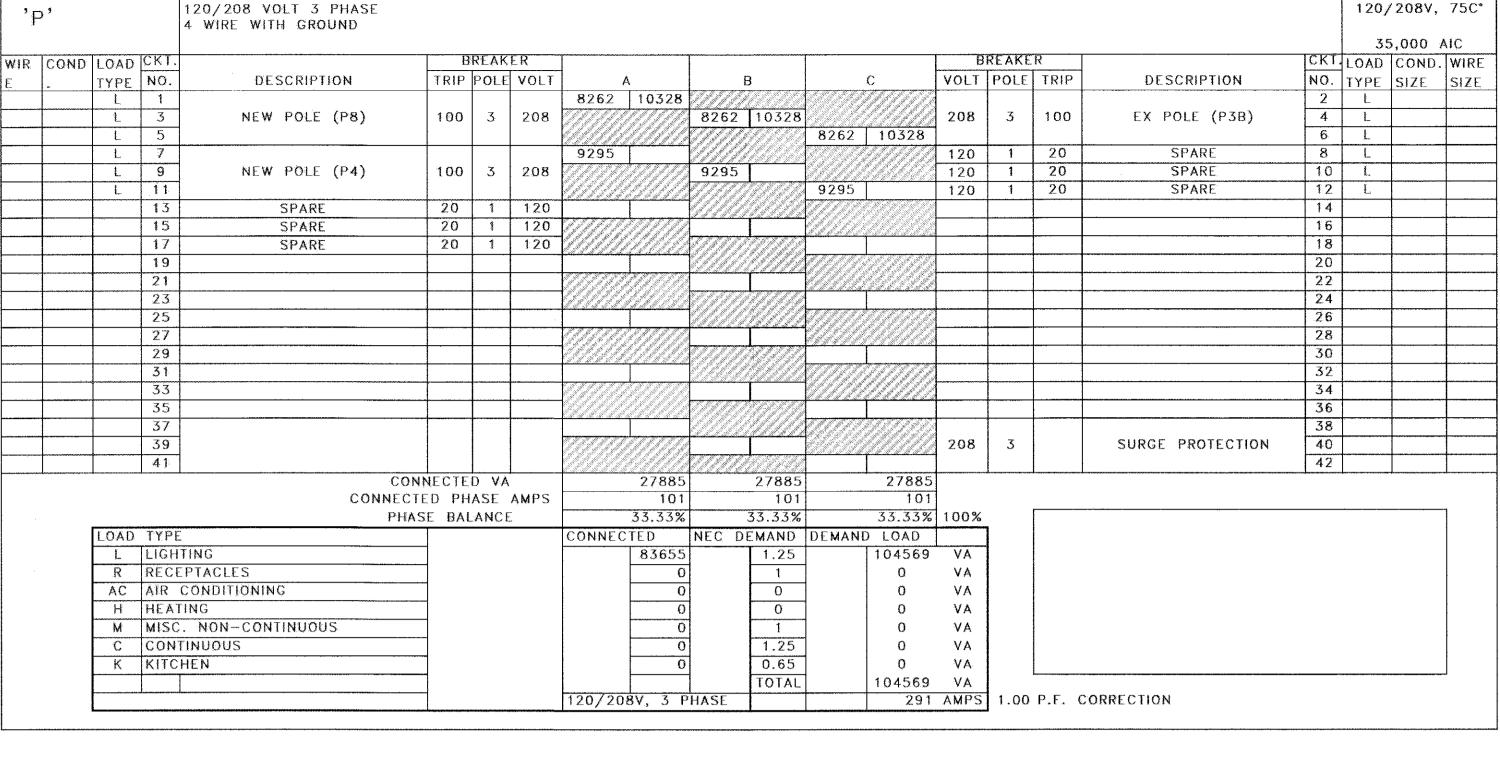

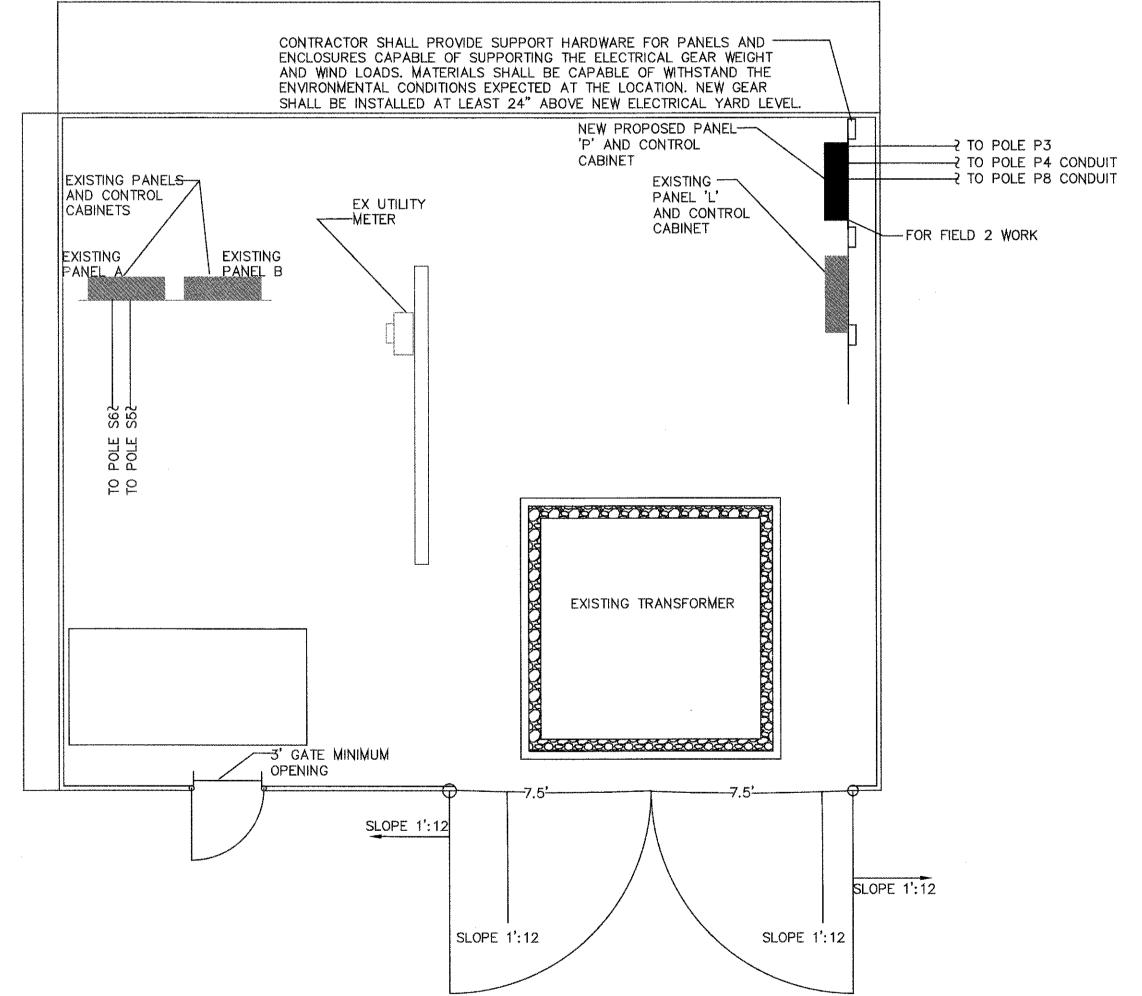

RECEIVED BY: J.A.W.

JAN 28 2021 PLANNING & DEVELOPMENT CITY OF CLEARWATER

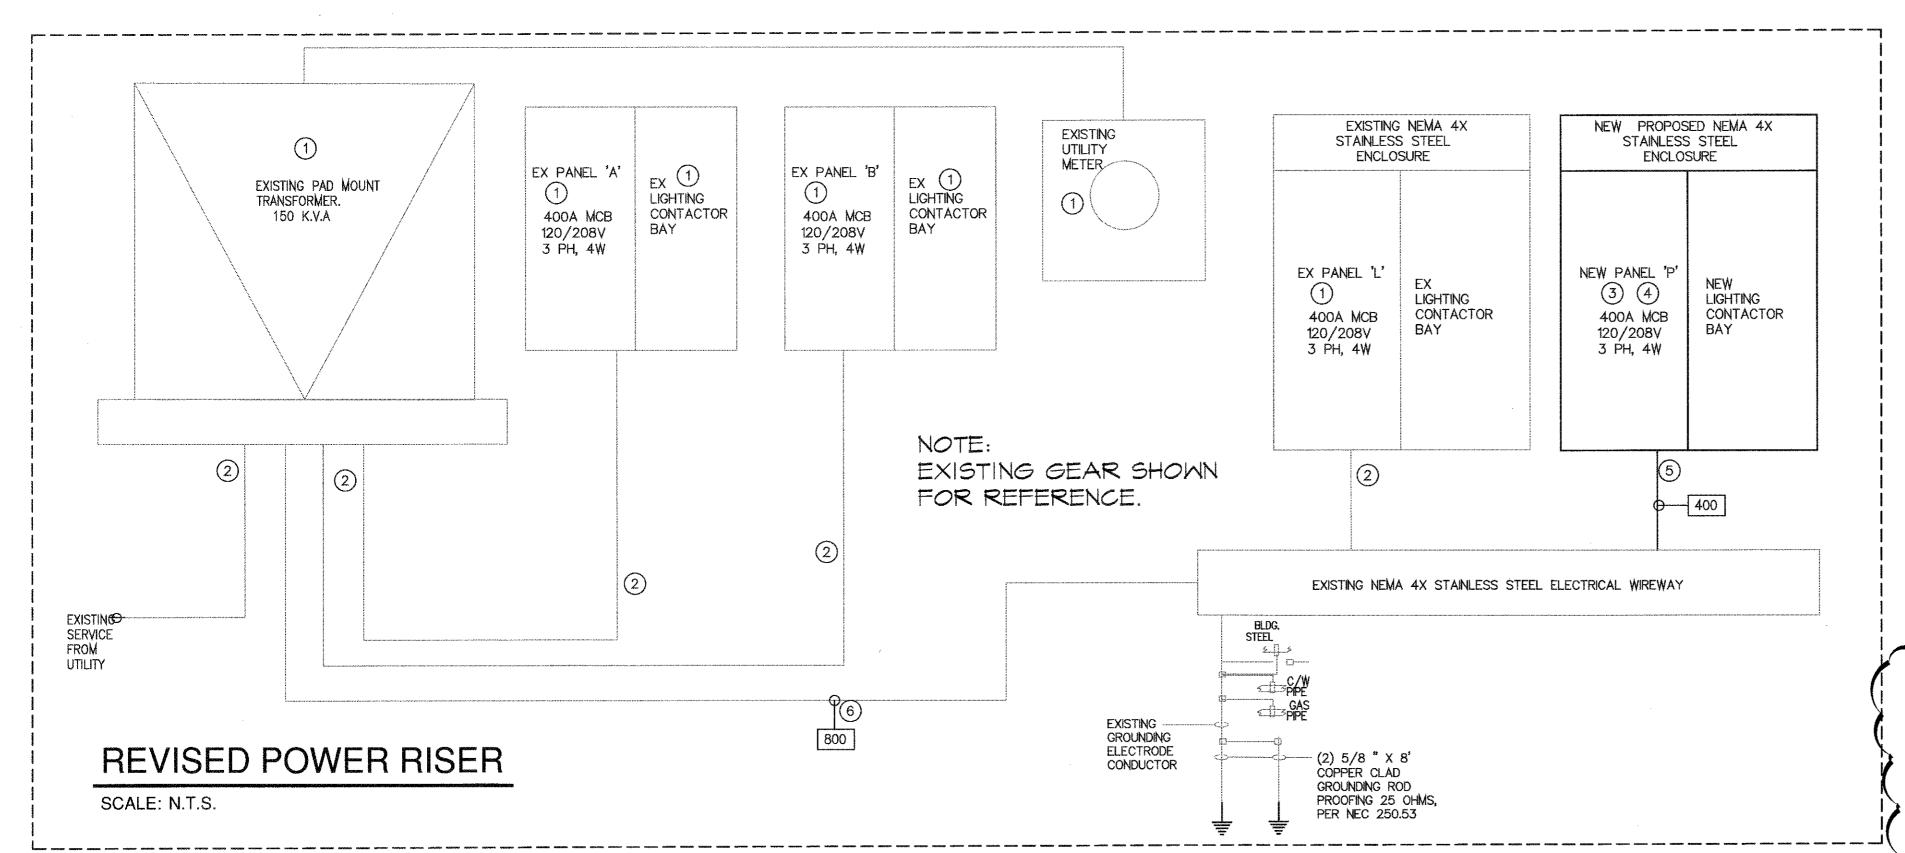

LAMINATED BLUE PLASTIC PLATE WITH WHITE ENGRAVED

PANFI

TEMPORARY NAMEPLATES ARE NOT ACCEPTABLE.

SWITCHBOARD OR PANELBOARD BUS RATING.

TYPICAL PANELBOARD NAMEPLATE DETAIL

225 AMP MCB. 208/120V. 3 PHASE 4W ®

FEED FROM PANEL 'B', XXX AMP BREAKER PANEL 'B' IS LOCATED IN EL. ROOM

-AS REQUIRED-

1. NEW NAMEPLATES MUST BE INSTALLED ON ALL ELECTRICAL PANELS

THE AMPERAGE RATING ENGRAVED ON THE NAMEPLATE SHALL BE

THE RATING OF THE MAIN OVERCURRENT PROTECTION DEVICE. OR ITS TRIP DEVICE SETTING, OR DESIGN BUS CAPACITY IN THE

WARNING

SHOCK AND ARC FLASH HAZARD

FAILURE TO COMPLY CAN RESULT

(FLASH PROTECTION DECAL - EXAMPLE)

CONTRACTOR SHALL PROVIDE DECAL 1-1/2" x 2-1/2" WITH 3/16"

LETTERING STATING THE ABOVE. DECAL SHALL BE LOCATED ON THE OUTSIDE

OF ALL SWITCHBOARDS, PANEL BOARDS AND DISCONNECT SWITCHES. DECAL

SHALL BE RED AND YELLOW BACKGROUND WITH BLACK LETTERING WITH A

APPROPRIATE PPE REQUIRED

IN INJURY OR DEATH

CLEAR PLASTIC LAMINATE TOP COVER OVER DECAL.

FLASH PROTECTION DECAL

NOT TO SCALE

ABSENCE OF A MAIN OVER CURRENT DEVICE, NOT THE

5/8" HIGH LETTERS

-3/16" HIGH

LETTERS

-RED BACKROUND.

-YELLOW BACKGROUND.

LETTERS.

NOTES:

GENERAL NOTES:

- ELECTRICAL CONTRACTOR TO VERIFY EXISTING CONDITIONS AND TO REPORT TO GENERAL CONTRACTOR, OWNER AND ENGINEER ANY DISCREPANCY FROM THAT SHOWN ON DRAWINGS.
- . COORDINATE ALL NEW ELECTRICAL WORK WITH CIVIL DRAWINGS GENERAL CONTRACTOR AND OWNER.
- . PANELS ARE REQUIRED TO HAVE AN PANELBOARD NAMEPLATE PER NEC 408.4(B) SEE TYPICAL PANELBOARD NAMEPLATE DETAILS (THIS SHEET) FOR MORE INFORMATION

RISER DIAGRAM NOTES: (

- EXISTING TRANSFORMER, EXISTING METER, EXISTING LIGHTING CONTACTORS AND EXISTING PANELS TO REMAIN. CONTRACTOR TO VERIFY THE RATINGS OF THESE EXISTING EQUIPMENTS.
- EXISTING FEEDERS TO REMAIN. VERIFY EXISTING FEEDERS TO VERIFY CURRENT
- PROVIDE 1 NEW 400 AMPS M.C.B PANEL 'P' AND NEW LIGHTING CONTACTOR.
- CONTRACTOR SHALL FURNISH AND INSTALL SURGE SUPPRESSION FOR ALL PANELS FOR PANEL AMPERAGE AND VOLTAGE AVAILABLE AT THE PANEL
- 5. RUN 400 AMP FEEDERS AS SHOWN ON THE RISER DIAGRAM.

VVVVVVV

CONTRACTOR SHALL ENSURE AT LEAST (3) 3" CONDUITS ARE RUN FROM THE EXISTING PAD MOUNT TRANSFORMER TO THE EXISTING WIREWAY. CONTRACTORS SHALL ALSO ENSURE 800 AMP FEEDERS TO BE USED FROM THE TRANSFORMER TO THE WIREWAY AS SHOWN ON THE FEEDER SCHEDULE.

FAULT CURREN		
UTILITY TRANSFORM	120/208V 3 PH	
NEW TRANS	300KVA	
AFC AT T	23,800 AMPS	
BUS	AVAILABLE FAULT CURRENT	MINIMUM AIC & SCCR
PANEL 'P'	35000 AMPS MIN.	
FAULT CURRENT	HAS BEEN ALLOCATED INTERRUPTING CAPACITY	

FEEDER SCHEDULES:

800\$	(SERVICE - 800 AMPS) (3) SETS OF 4 #350 MCM, IN 3" C.	NOT APPLICABLE
800	(FEEDER - 800 AMPS) (3) SETS OF 4 #350 MCM, 1 #1/0 E.G. COPPER COND. IN 3" C.	NOT APPLICABLE
600	(FEEDER - 600 AMPS) (2) SETS OF 4 #350 MCM, 1 #1 E.G. COPPER COND. IN 2-1/2" C.	(FEEDER - 600 AMPS) (2) SETS OF 4 #500, 1 #2/0 E.G. ALUMINUM COND. IN 3" C.
400L	(FEEDER - 400 AMPS - MORE THAN 100 FT LONG) (2) SETS OF 4 #3/0 AND 1 #3 E.G. COPPER COND. IN 2" C.	(FEEDER - 400 AMPS) (2) SETS OF 4 #250MCM AND 1 #1/0 E.G. ALUMINUM COND. IN 3" C.
400	(FEEDER - 400 AMPS) (2) SETS OF 4 #3/0 AND 1 #3 E.G. COPPER COND. IN 2" C.	(FEEDER - 400 AMPS) (2) SETS OF 4 #250MCM AND 1 #1/0 E.G. ALUMINUM COND. IN 3" C.
250	(FEEDER - 250 AMPS) 4 #350, AND 1 #4 EG. COPPER COND. IN 3" C	(FEEDER - 250 AMPS) 4 #500, AND 1 #3/0 EG. ALUMINUM COND. IN 3-1/2" C
200	(FEEDER - 200 AMPS) 4 #4/0 AND 1 #4 E.G. COPPER COND. IN 2-1/2" C	(FEEDER - 200 AMPS) 4 #350 AND 1 #1/0 E.G. ALUMINUM COND. IN 3" C
175	(FEEDER - 175 AMPS) 4 #3/0 AND 1 #6 E.G. COPPER COND. IN 2" C	(FEEDER - 175 AMPS) 4 #250 AND 1 #4 E.G. ALUMINUM COND. IN 2-1/2" C
125	(FEEDER - 125 AMPS) 4 #1/0 AND 1 #6 E.G. COPPER COND. IN 2" C	(FEEDER - 125 AMPS) 4 #3/0 AND 1 #6 E.G. ALUMINUM COND. IN 2-1/2" C
100	(FEEDER - 100 AMPS) 4 #1 AND 1 #6 E.G COPPER COND. IN 2" C	(FEEDER - 100 AMPS) 4 #2/0 AND 1 #6 E.G ALUMINUM COND. IN 2-1/2" C
	T #1 AIRD 1 #0 L.O COITER COND. IN Z C	T #2/0 7140 1 #0 L.O ALOIVIII VOIV COIND. II 2-1/2 C

RISER GENERAL NOTES:

- ELECTRICAL CONTRACTOR TO VERIFY EXISTING CONDITIONS AND TO REPORT TO GENERAL CONTRACTOR, OWNER AND ENGINEER ANY DISCREPANCY FROM THAT SHOWN ON DRAWINGS.
- ELECTRICAL CONTRACTOR SHALL REQUEST THE DRAWINGS OF ALL OTHER DISCIPLINES APPLICABLE TO THIS SCOPE OF WORK AND CAREFULLY REVIEW ALL DRAWINGS BEFORE WORK COMMENCEMENT OR BID SUBMITTAL. IS THE RESPONSIBILITY OF THE ELECTRICAL CONTRACTOR TO PROVIDE ANY ADDITIONAL DEVICE REQUIRED FOR A COMPLETE AND FULLY FUNCTIONAL WORK OF SCOPE THAT IS NOT COVERED ON THESE DRAWINGS, COORDINATE ALL NEW ELECTRICAL WORK WITH CONTRACTORS OF ALL TRADES AND OWNER.
- PANELS ARE REQUIRED TO HAVE AN PANELBOARD NAMEPLATE PER NEC 408.4(B) SEE TYPICAL PANELBOARD NAMEPLATE DETAILS, ELECTRICAL DETAILS SHEET FOR MORE INFORMATION

FOR SPECIFIC EQUIPMENT LOCATION, REFER TO ARCHITECTURAL DRAWINGS

- 5. ALL ELECTRICAL RUNS SHALL BE NO LEES THAT AWG #12 COPPER CONDUCTORS, UNLESS OTHERWISE NOTED.
- AN EQUIPMENT GROUNDING CONDUCTOR SHALL BE INSTALLED IN ALL ELECTRICAL RACEWAYS
- AND SHALL BE SIZED IN ACCORDANCE WITH ARTICLE 250-122 OF THE NATIONAL ELECTRICAL

ALL PANELS SHALL HAVE AN AIC AND SCCR OF 22,000 AMPS MINIMUM, UNLESS OTHERWISE NOTE

UTILITY CONTACT INFORMATION

FOR TRANSFORMER COORDINATION INQUIRIES, CONTACT JARED A. BUTTS E & TCR- ENGINEER CONTACT: 727.562.3814 (OFF), 727.401.7878 EMAIL: JARED.BUTTS@DUKE-ENERGY.COM

NEC ARTICLE 30" OR WIDTH OF THE PANEL

FRONT VIEW

PANEL

WHICHEVER IS LARGEST

PANEL AND SWITCHBOARD CLEARANCE NOT TO SCALE

SIDE VEIW

NÉC ARTICLE

PANEL A.I.C. RATING 42,000A FULL RATED

(A.I.C. DECAL - EXAMPLE)

CONTRACTOR SHALL PROVIDE DECAL 1-1/2" x 2-1/2" WITH 3/16" LETTERING STATING THE A.I.C. RATING OF EACH PANEL. THIS DECAL SHALL BE LOCATED ON THE INSIDE OF PANEL DOOR. DECAL SHALL BE WHITE BACKGROUND WITH BLACK LETTERING WITH A CLEAR PLASTIC LAMINATE TOP COVER OVER DECAL,

A.I.C. IDENTIFICATION DECAL

NOT TO SCALE

RECORD DRAWINGS SK 3/1/2 **化 RESPONSE TO PERMIT COMMENTS** DRAWN BY SURVEYED BY REVIEWED BY DATE PROJECT ENGINEER APPROVED BY REVISION BY DATE CITY ENGINEER MICHAEL D. QUILLEN, P.E. # 33721



CITY OF CLEARWATER, FLORIDA PARKS & RECREATION DEPT. 100 S. Myrtle Ave. Clearwater, Fl 33756



LEARWATER CONTRACT NO SURVEYED BY CLEARWATER JOB NO. VERT. NONE Clearwater 2020-XXXX SHEET NO. HORIZ. 1"=N/ADATE JOSEPH H. GRINER III, FL P.E. 39491

C405,6.3 VOLTAGE DROP

GENERAL NOTES:

- ELECTRICAL CONTRACTOR TO VERIFY EXISTING CONDITIONS AND TO REPORT TO GENERAL CONTRACTOR, OWNER AND ENGINEER ANY DISCREPANCY FROM THAT SHOWN ON DRAWINGS.
- 2. COORDINATE ALL NEW ELECTRICAL WORK WITH MECHANICAL CONTRACTOR AND OWNER.

SIZED FOR A MAXIMUM OF 5 PERCENT VOLTAGE DROP TOTAL.

SERVICE VOLTAGE DROP

THE SIZE BY 1 NOMINAL SIZE PER EACH 50 FEET OF WIRING.

BRANCH CIRCUITS LOADED PER NEC AMPACITY WITH RUNS LESS THAT 75

FEET SHOULD PROVIDE ACCEPTABLE VOLTAGE DROPS PER INTERNATIONAL

BUILDING CODE (CURRENT ADOPTED EDITION). CONTRACTOR SHALL INCREASE

GENERAL INTERNATIONAL BUILDING CODE NOTES:

ALL ELECTRICAL WORK SHALL COMPLY WITH INTERNATIONAL BUILDING CODE

THE CONDUCTORS FOR FEEDERS AND BRANCH CIRCUITS COMBINED SHALL BE

. PANELS ARE REQUIRED TO HAVE AN PANELBOARD NAMEPLATE PER NEO 408.4(B) SEE TYPICAL PANELBOARD NAMEPLATE DETAILS SHEET E300 FOR MORE INFORMATION




Control System Summary

Countryside Athletic Complex Phase 3 / 208806 - 208806B Soccer 1-2 - Page 4 of 4


PANEL SUMMARY CIRCUIT DESCRIPTION MODULE PANEL ID (BY BREAKER LOCATION OTHERS) POSITION (BY OTHERS) Pole S3 Pole S6 Pole P3

		ZONE SCHEDU	and the second s			
CIRCUIT DESCRIPT						
ZONE	SELECTOR SWITCH	ZONE DESCRIPTION	POLE NO	CONTACTOR ID		
Zone 1	1	Soccer 1-2	SI	CI		
			52 S3	C2		
			S3	C3		
			S4°	C4		
			S5	C5		
			\$4 \$5 \$6 P3	C5 C6 C7		
			P3	C7		
			P4	C8		
			P8	C9		

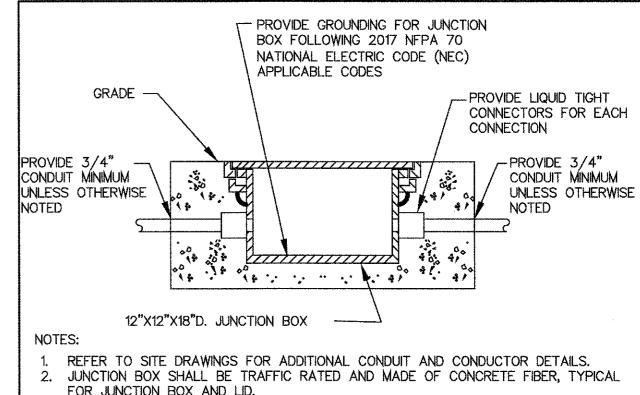


- FOR JUNCTION BOX AND LID.
- 3. ANY ELECTRICAL JUNCTION BOXES LOCATED IN PLAY FIELD SHALL BE LOW GRADE. MINIMUM 12" FROM FINISH GRADE, SURVEY POINTS SHALL BE PROVIDE TO CENTER OF J-BOX FOR FUTURE LOCATION OF ELECTRICAL J-BOX.


TYPICAL LIGHTING GROUND JUNCTION BOX

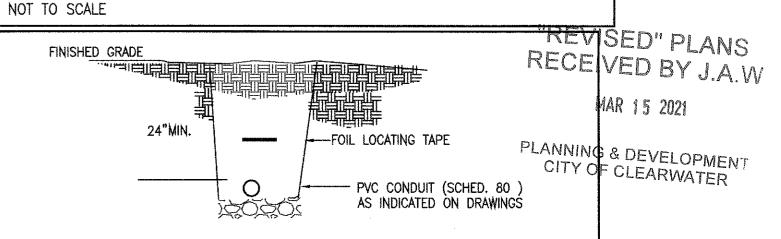


TYPICAL SERVICE TRENCH CONFIGURATION NOT TO SCALE


COUNTRYSIDE SPORTS COMPLEX FIELD 2 RENOVATION

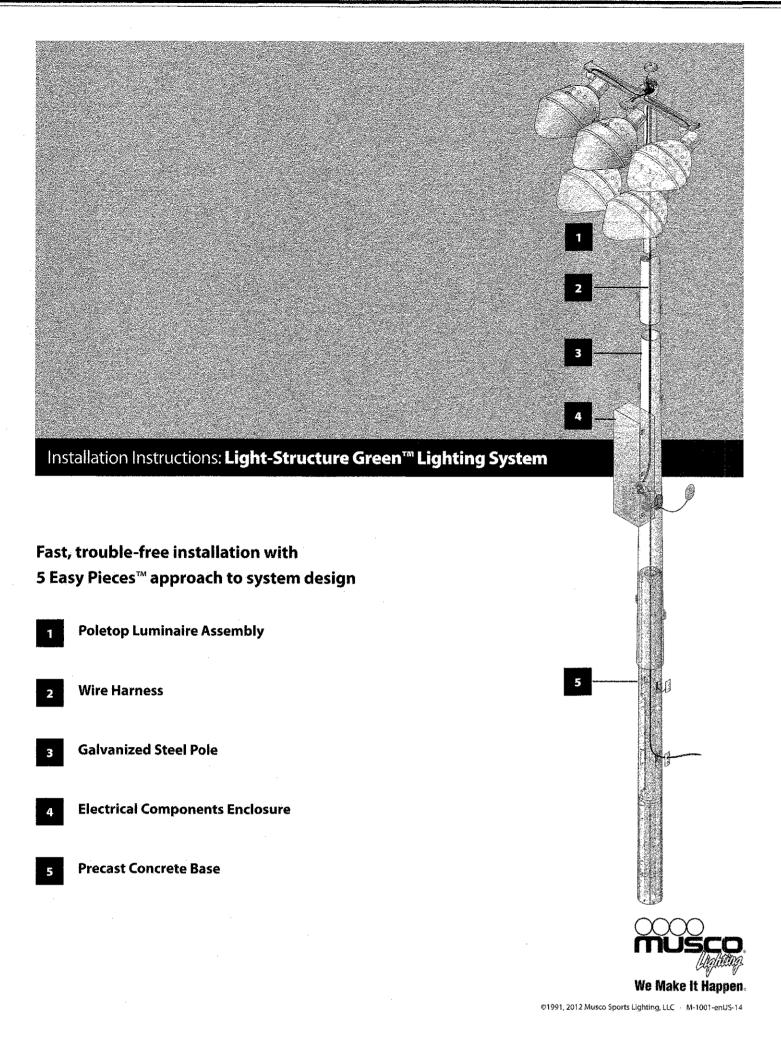

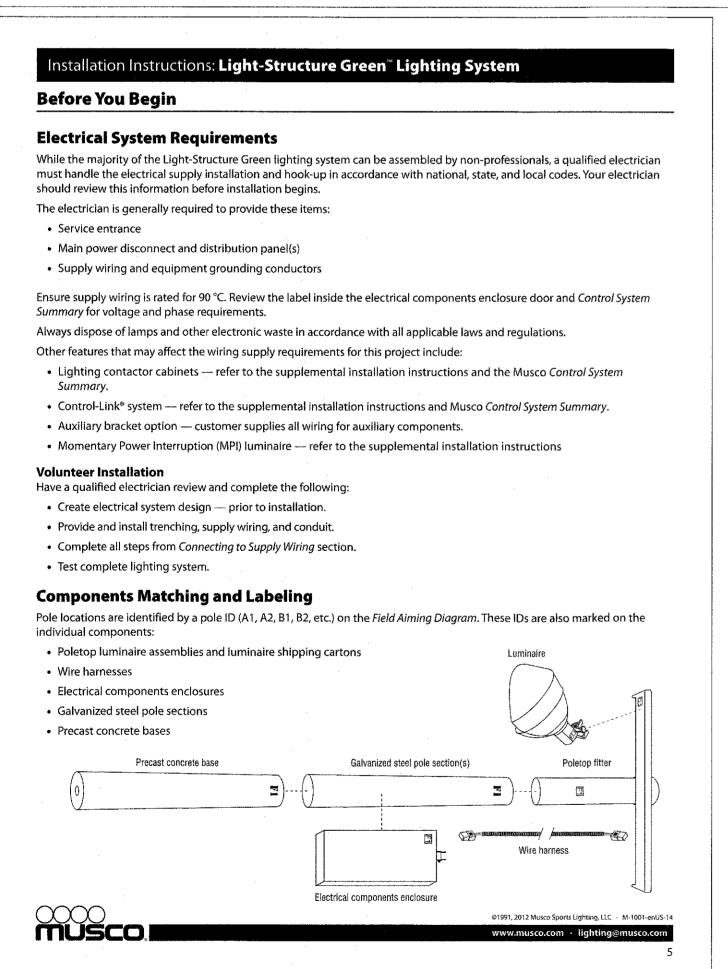


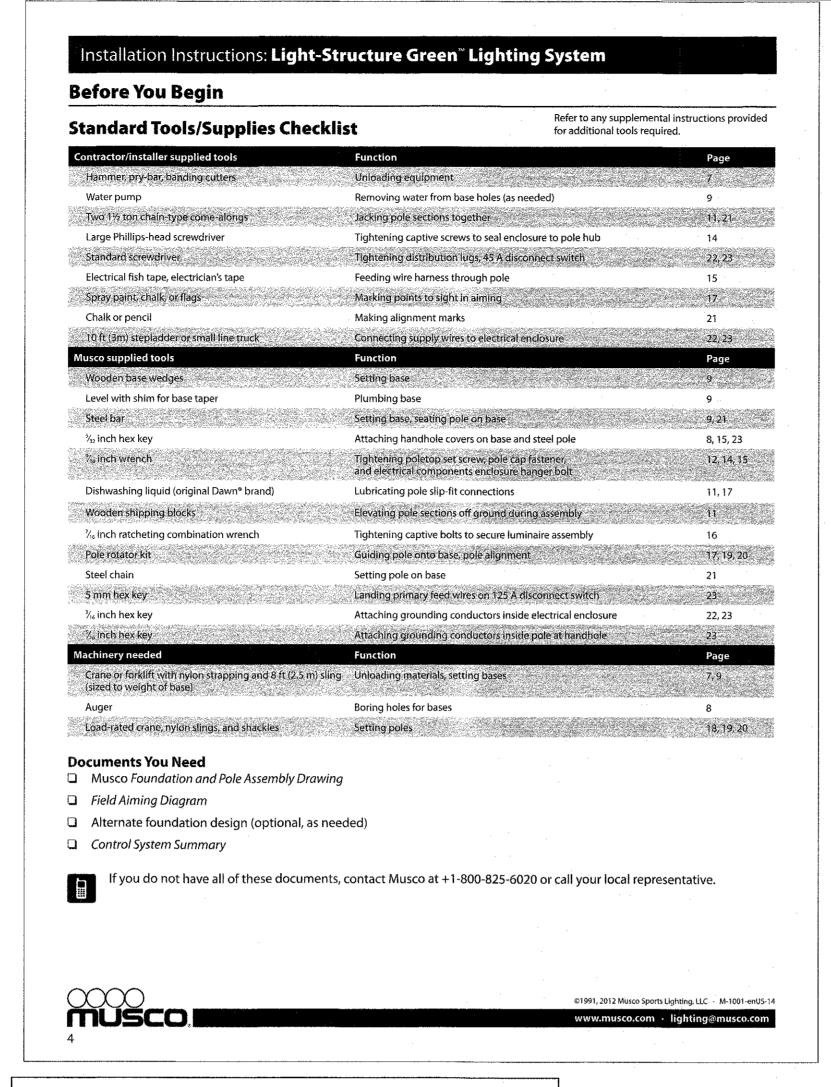

INFORMATION ON THIS SHEET PROVIDED BY MUSCO LIGHTING. SHOWN FOR REFERENCE ONLY

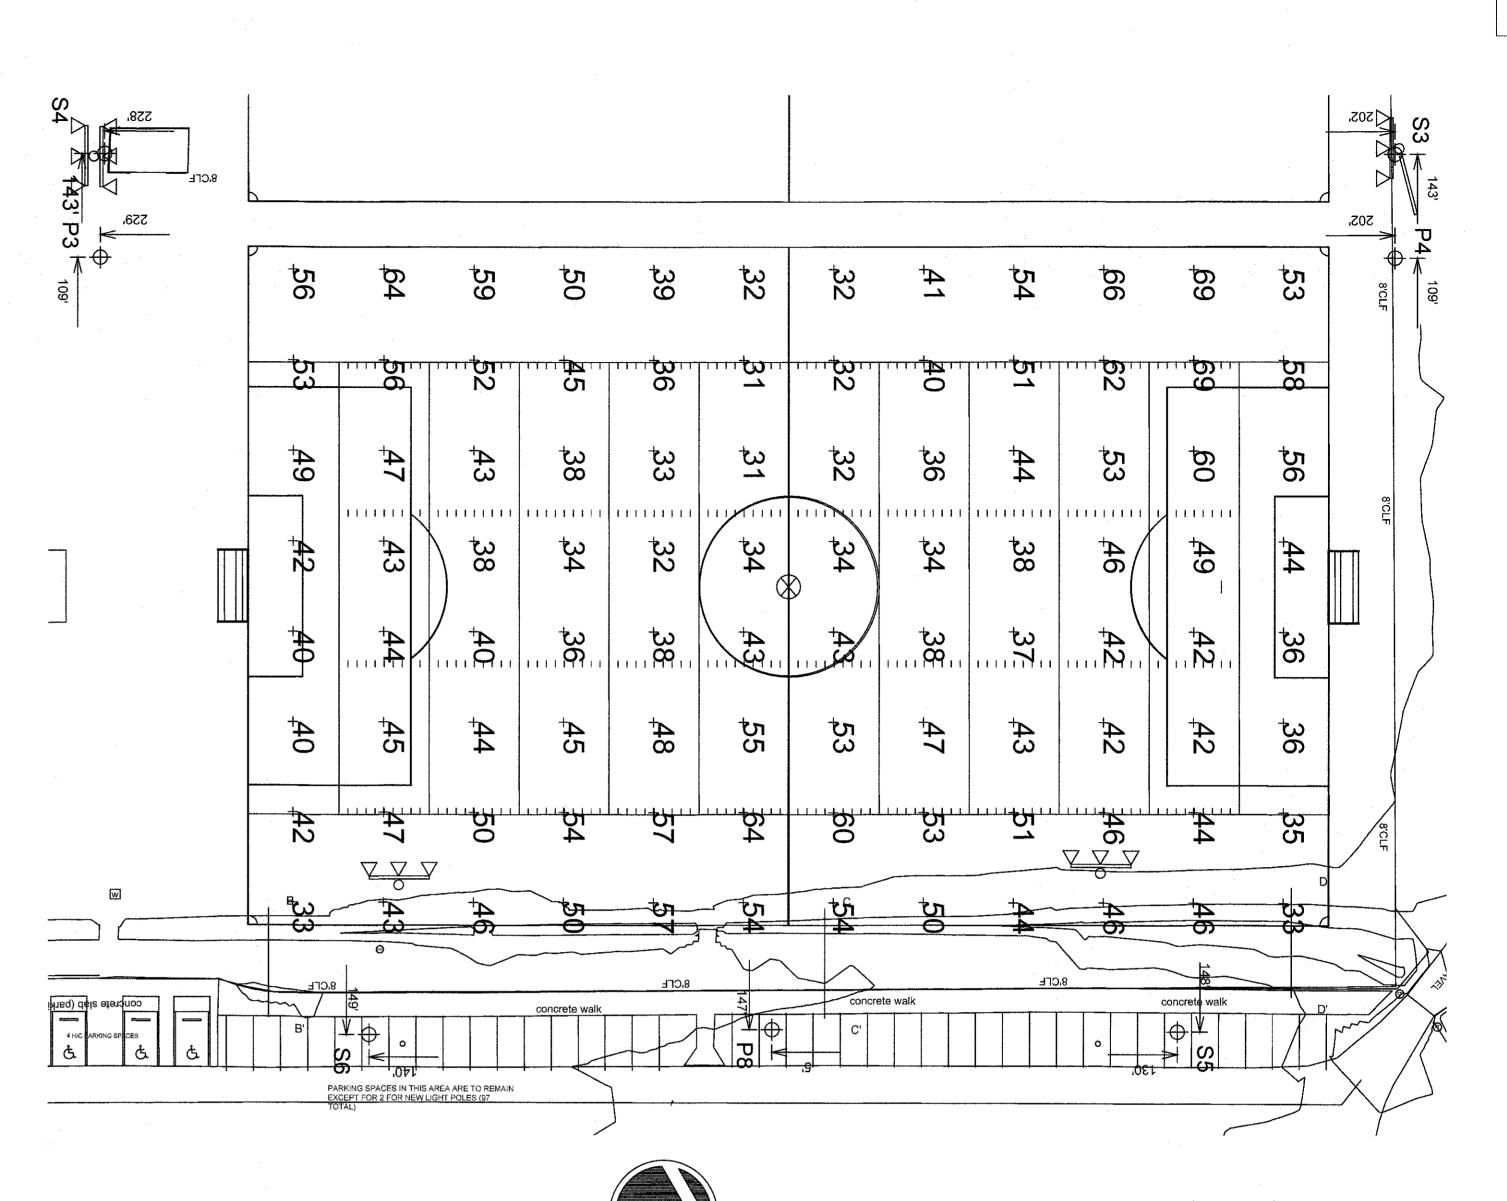

PROPOSED PHOTOMETRIC SITE PLAN SCALE: 1/32" = 1'-@"

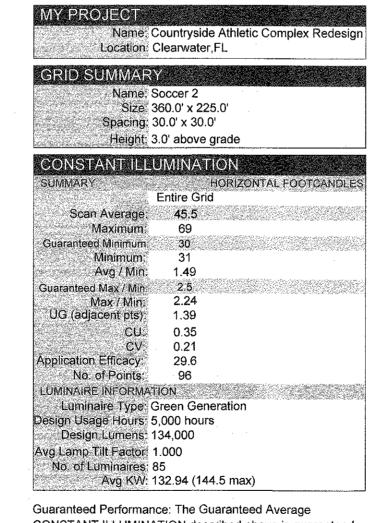

CONSTANT ILLUMINATION described above is guaranteed for the design usage hours of the system. Field Measurements: Illumination measured in accordance with IESNA RP-6-15 and CIBSE LG4. Individual values may vary. See the Warranty document for details. Electrical System Requirements: Refer to Amperage Draw Chart and/or the "Musco Control System Summary" for electrical sizing. Installation Requirements: Results assume +/- 3%

nominal voltage at line side of the ballast and structures


located within 3 feet (1m) of design locations.

JAR

RECEIVED BY: J.A.W.

JAN 28 2021 PLANNING & DEVELOPMENT CITY OF CLEARWATER


RECORD DRAWINGS SURVEYED BY DRAWN BY REVIEWED BY PROJECT ENGINEER DATE APPROVED BY REVISION CITY ENGINEER MICHAEL D. QUILLEN, P.E. # 33721 DATE

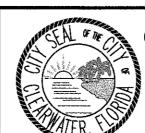

PARKS & RECREATION DEPT. 100 S. Myrtle Ave. Clearwater, Fl 33756



Fax: (727)-821-3361

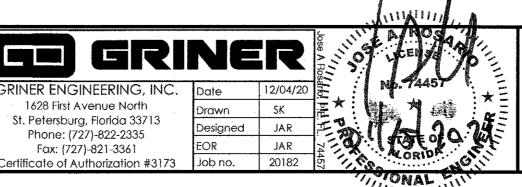

COUNTRYSIDE	1	SPORTS	COMPLE
FIELD 2)	RENOVA'	TION

DRAWN BY	SK/JAR	DES/PJLIGNED BY	CHECKED BY JAR	CLEARWATER CONTRACT NO.
SCALE VERT.	NONE	SURVEYED BY Clearwater	BOOK NO.	CLEARWATER JOB NO.
HORIZ.	1"=N/A	DATE DRAWN Dec 04, 2020	DWG NAME 2020-XXXX	SHEET NO.
		JOSE A ROSARIO, P.E.	74457	DATE

ELECTRICAL SYMBOL LEGEND MOUNTING SYMBOL 2 X 2 FLUORESCENT FIXTURE SEE FIXTURE G LETTER INDICATES TYPE SCHEDULE 2 X 4 FLUORESCENT FIXTURE SEE FIXTURE ∠JA LETTER INDICATES TYPE SCHEDULE SEE FIXTURE SHADING DENOTES FIXTURE WITH EM BATTERY PACK. 'NL' DENOTES FIXTURE UN-SWITCHED FOR NIGHT LIGHT SCHEDULE SEE FIXTURE 2 X 4 FLUORESCENT FIXTURE (LETTER INDICATES TYPE) SCHEDULE SHADING DENOTES FIXTURE FED FROM EMERGENCY SUPPLY FLUORESCENT STRIP FIXTURE HO-IK LETTER INDICATES TYPE SEE FIXTURE SCHEDULE FLUORESCENT WALL BRACKET FIXTURE LETTER INDICATES TYPE SEE FIXTURE **SCHEDULE** LETTER INDICATES TYPE SEE FIXTURE RECESSED DOWNLIGHT SCHEDULE LETTER INDICATES TYPE EXTERIOR DOWNLIGHT FIXTURE SEE FIXTURE LETTER INDICATES TYPE **SCHEDULE** EXTERIOR WALL MOUNTED FIXTURE SEE FIXTURE LETTER INDICATES TYPE SCHEDULE SEE FIXTURE INTERIOR PENDANT FIXTURE **SCHEDULE** ETTER INDICATES TYPE EXTERIOR SURFACE MOUNT FIXTURE SEE FIXTURE SCHEDULE ETTER INDICATES TYPE SEE FIXTURE **-**WALL LOW MOUNTED FIXTURE SCHEDULE SEE FIXTURE CEILING FAN SCHEDULE SEE FIXTURE EXIT—SHADING DENOTES FACEPLATE LOCATION. LETTER INDICATES TYPE. PROVIDE ARROWS AS REQUIRED. SCHEDULE SEE FIXTURE DENOTES EMERGENCY WALL PACK. LETTER INDICATES TYPE. SCHEDULE SEE FIXTURE Z ▼ ▼ DENOTES TRACK LIGHTING. LETTER INDICATES TYPE. SCHEDULE SINGLE POLE SWITCH (20A-120/277) 48" AFF OR AS S S3 D '3' DENOTES 3-WAY, 'D' DENOTES DIMMER NOTED ABOVE CEILING 'T' DENOTES TOGGLE SWITCH 48" AFF OR AS OCCUPANCY SENSOR NOTED 48" AFF OR AS LOW VOLTAGE LIGHTING SWITCH NOTED DUPLEX RECEPTACLE, 125V, 20A 18" AFF OR AS 'IG' DENOTES ISOLATED GROUND NOTED 18" AFF OR AS DUPLEX RECEPTACLE, 125V, 20A NOTED 48" AFF OR AS DUPLEX RECEPTACLE, 125V, 20A NOTED 18" AFF OR AS QUAD RECEPTACLE, 125V, 20A NOTED 18" AFF OR SINGLE RECEPTACLE, 208V OR 240V AS NOTED 기 [특] CEILING MOUNTED COILED REEL EXTENSION RECEPTACLE. CEILING MOUNTED SEE DETAIL OR CEILING/WALL MOUNTED BOX WITH 20A DUPLEX RECEPTACLE AS NOTED <u>AND DATA OUTLET.</u> SEE DETAIL OR JUNCTION BOX AS NOTED SEE DETAIL OR POWER/TELEPHONE POLE as Noted OUTLET BOX OR J-BOX FOR POWER AND DATA 18" AFF OR SUPPLY TO FURNITURE SYSTEMS AS NOTED SEE DETAIL OR FLOOR BOX WITH 20A DUPLEX RECEPTACLE. AND DATA OUTLET. AS NOTED 18" AFF OR AS COMBINATION VOICE/DATA OUTLE NOTED 18" AFF OR AS ▼ DATA OUTLET 18" AFF OR AS ▼ VOICE OUTLET 18" AFF OR AS FAX OUTLET NOTED COORDINATE WITH CR CARD READER SECURITY INSTALLER COORDINATE WITH SURVEILLANCE CAMERA SECURITY INSTALLER 18" AFF OR AS T.V. OUTLET SEE PANEL PANELBOARD 120/208V **SCHEDULE** SEE PANEL PANELBOARD 277/480V SCHEDULE RACEWAY CONCEALED IN WALL OR ABOVE CEILING SEE SPECIFICATIONS UNDERGROUND OR UNDER FLOOR CONDUIT SEE SPECIFICATIONS HOMERUN TO PANEL. LETTERS INDICATE PANEL, NUMBERS INDICATE CIRCUIT. NOTE: HASH MARKS SEE SPECIFICATIONS INDICATES THE NUMBER OF WIRES EXCLUDING THE REQUIRED EQUIPMENT GROUND. MOTOR, NUMERAL INDICATES HORSEPOWER AS NOTED MOTOR RATED SWITCH WITH OVERLOAD MOUNTED ADJACENT TO EQUIPMENT RELAYS AS REQUIRED. NON-FUSIBLE SAFETY SWITCH-SIZE AS NOTED SEE SPECIFICATIONS SEE SPECIFICATIONS FUSIBLE SAFETY SWITCH-SIZE AS NOTED *NOTE - ALL SYMBOLS SHOWN MAY NOT BE USED. **ABBREVIATIONS:**

. ALL MOUNTING HEIGHTS SHOWN ARE TO THE TOP OF THE DEVICE UNLESS NOTED OTHERWIS 2. NOT ALL SYMBOLS APPEAR ON PLANS.

RECORD DRAWINGS

CITY ENGINEER MICHAEL D. QUILLEN, P.E. # 33721

PROJECT ENGINEER

SURVEYED BY

REVIEWED BY

APPROVED BY

DRAWN BY


DATE

ELECTRICAL GENERAL NOTES:

- ALL WORK SHALL CONFORM TO THE REQUIREMENTS OF THE FLORIDA BUILDING CODE 2017 NATIONAL ELECTRIC CODE 2014, NFPA 70. NFPA 101 & NFPA 72 (CURRENT ADOPTED EDITIONS). ANY OTHER APPLICABLE
- BIDDERS ARE TO VISIT THE SITE AND FAMILIARIZE THEMSELVES WITH EXISTING CONDITIONS AND SATISFY THEMSELVES AS TO THE NATURE AND SCOPE OF WORK AND THE EXTENT OF DEMOLITION. THE SUBMISSION OF A BID WILL BE EVIDENCED THAT SUCH AN EXAMINATION HAS BEEN MADE. LATER CLAIMS FOR LABOR, EQUIPMENT OR MATERIALS REQUIRED, OR FOR DIFFICULTIES ENCOUNTERED WHICH COULD HAVE BEEN FORESEEN HAD AN EXAMINATION BEEN MADE, WILL NOT BE ALLOWED.

CODE REFERENCES AND ALL LOCAL ORDINANCES.

- ELECTRICAL CONTRACTOR SHALL BE EXPERIENCED IN PERFORMING AND INSTALLATION OF WORK SIMILAR TO THAT REQUIRED FOR THIS PROJECT. THE CONTRACTOR SHALL SUBMIT A LIST OF AT LEAST FIVE PROJECTS THAT THEY BEEN CONTRACTED AND COMPLETED CONSTRUCTION WITH SIMILAR PROJECT SCOPE OF WORK.
- PRIOR TO SUBMITTING A BID, THE CONTRACTOR SHALL HAVE STUDIED AND COMPARED THE CONTRACT DOCUMENTS WITH EXISTING/PROPOSED CONDITIONS AND NOT LATER THAN TEN (10) DAYS PRIOR TO THE BID OPENING SHALL REPORT TO THE ENGINEER ANY ERROR, INCONSISTENCY, OR OMISSION IN THE CONTRACT
- ELECTRICAL EQUIPMENT SHALL BE AS SPECIFIED. ARCHITECT AND ENGINEER WILL REVIEW ANY SUBSTITUTION FOR
- ALL CUTTING, REMOVING AND REPLACING CONCRETE WORK SHALL BE THE RESPONSIBILITY OF THE TRADE INVOLVED, COORDINATE WITH SITE CONTRACTOR
- PROTECT ELECTRICAL EQUIPMENT AND INSTALLATIONS AS NECESSARY. IF DAMAGED OR DISTURBED IN THE COURSE OF THE WORK, REMOVE DAMAGED PORTIONS AND INSTALL NEW PRODUCTS OF EQUAL CAPACITY, QUALITY,
- THE CONTRACTOR SHALL INCLUDE WITHIN THE BID ALL REQUIRED OFF HOUR, OVERTIME, AND NON-BUSINESS HOUR WORK AS REQUIRED.
- ALL WORK SHALL BE COORDINATED WITH OTHER TRADES FOR ITEMS IN THEIR SCOPE OF WORK WHICH WOULD REQUIRE ELECTRICAL WORK (DISCONNECTION/RECONNECTION ETC.) AND ARE NOT INDICATED ON THE ELECTRICAL PLANS, ALL SUBCONTRACTOR'S ARE REQUIRED TO COORDINATE THEIR WORK WITH OTHER TRADES. LACK OF THIS COORDINATION RESULTING IN ADDED COST TO THE CONTRACT WILL BE BORNE BY THE SUBCONTRACTOR.
- O. THE CONTRACTOR SHALL PROVIDE SHOP DRAWINGS AND SUBMITTALS FOR ELECTRICAL EQUIPMENT SHOWN ON THE PLANS AND SPECIFICATIONS FOR THE ENGINEERS APPROVAL. THE ENGINEER MAY REQUIRE THE CONTRACTOR TO REDO ANY WORK, WHICH WAS NOT APPROVED, OR THE ENGINEER MAY REQUIRE A CREDIT TO THE OWNER. PROVIDE A SET OF AS-BUILT AFTER THE JOB IS COMPLETED. THIS SET SHALL BE CONTINUOUSLY UPDATED
- PROVIDE IDENTIFICATION FOR ALL LIGHT FIXTURES AND ALL ELECTRICAL COVER PLATES WITH PERMANENT MARKER ON A SELF-ADHERING TAG INDICATING PANEL AND CIRCUIT NUMBER. TYPICAL FOR ALL LIGHTING AND POWER
- 12. ALL WORK SHALL BE PERFORMED DURING TIME PERIODS ACCEPTABLE TO THE OWNER. SCHEDULE ALL WORK WITH THE OWNER'S REPRESENTATIVE BEFORE PROCEEDING.
- 3. THE CONTRACTOR SHALL PERFORM ALL TEMPORARY WORK NECESSARY TO MAINTAIN CONTINUITY OF ELECTRICAL SERVICE (LIKE SAWPOLE SERVICE) WHEN CONNECTION IS MADE. THIS SERVICE SHALL NOT BE INTERRUPTED WITHOUT PRIOR CONSENT OF THE OWNER'S REPRESENTATIVE AND MAY BE INTERRUPTED ONLY AT AND FOR THE SPECIFIED TIME DESIGNATED BY OWNER'S REPRESENTATIVE. THE CONTRACTOR SHALL BE GUIDED BY THE OWNER'S REPRESENTATIVE AT ALL TIMES IN MATTERS AFFECTING THE FACILITIES.
- . THE CONTRACTOR SHALL COORDINATE ALL PHASING OF ELECTRICAL WORK AS REQUIRED AND INDICATED ON THE ELECTRICAL DRAWINGS.
- 15. THE OWNER PROJECT REPRESENTATIVE SHALL BE NOTIFIED PRIOR TO CUTTING OF ANY STRUCTURAL ITEM (I.E. CONCRETE FLOOR, MASONRY, WALL, ETC.) WITHIN THE EXISTING BUILDING. METHOD OF CUTTING SHALL BE APPROVED BY THE OWNER PROJECT REPRESENTATIVE.
- CONTRACTOR SHALL BE RESPONSIBLE FOR KEEPING THE BUILDING WATERTIGHT DURING CONSTRUCTION.
- 17. ALL WIRING IN CEILING SPACE OR IN AIR HANDLING PLENUMS NOT IN CONDUIT SHALL BE UL LISTED AS SUITABLE FOR PLENUM USE.
- 18. ALL JUNCTION BOXES AND COVER PLATES SHALL BE PAINTED AND LABELED.
- 19. ALL RECEPTACLES WITHIN (6) FEET OF PLUMBING FIXTURES SHALL BE PROVIDED WITH 5 MILLIAMP GROUND FAULT INTERRUPTERS. (GFCI RECEPTACLES)

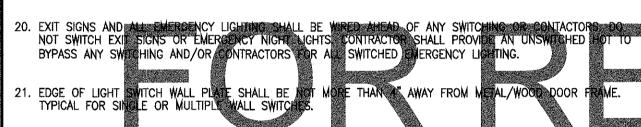

- 22. CONFIRM MOUNTING HEIGHTS AND COORDINATE LOCATION OF ALL OUTLETS, SWITCHES, AND OTHER DEVICES WITH ARCHITECTURAL ELEVATIONS (FURNITURE LAYOUT) PRIOR TO ROUGH-IN.
- 23. PROVIDE SEAL FOR PENETRATION OF FIRE RATED WALLS BY CONDUIT.
- 24. BACK TO BACK RECEPTACLES IN ALL ONE HOUR FIRE RATED WALLS SHALL BE LOCATED A MINIMUM OF 24" ON
- 25, BRANCH CIRCUIT CONDUCTORS SHALL NOT BE SMALLER THAN NO. 12 AND WHERE BRANCH CIRCUIT CONDUCTOR RUNS FROM SOURCE (PANEL) TO THE LAST DEVICE ON THE CIRCUIT EXCEEDS 75 FT. IN LENGTH, THE CONDUCTORS SHALL BE NO. 10 MINIMUM AND FOR THE ENTIRE LENGTH OF THE CIRCUIT. FOR RUNS OVER 150 FT. IN LENGTH THE CONDUCTOR SHALL BE NO. 8 MINIMUM AND FOR THE ENTIRE LENGTH OF THE CIRCUIT. THE ABOVE APPLIES TO 120 VOLT CIRCUITS ONLY.
- 26. THE CONTRACTOR SHALL COORDINATE WITH THE OWNER THE REMOVAL AND DISPOSAL OF ALL ELECTRICAL MATERIAL WHICH IS NOT TO BE USED ON THE PROJECT, CONTRACTOR SHALL REMOVE AND STORE ANY ELECTRICAL MATERIAL IF SO DIRECTED BY OWNER, PATCH AND PAINT WALLS AND CEILINGS AS REQUIRED. THE CONTRACTOR SHALL COORDINATE INSTALLATION OF NEW LIGHTING FIXTURES, RECEPTACLES, PANEL BOARDS, ETC. WITH EXISTING STRUCTURE, PIPING, ETC. AND MAKE ADJUSTMENTS AS REQUIRED.
- 27. REFER TO ELECTRICAL SPECIFICATIONS SHEET FOR REQUIREMENTS.
- 28. UPON COMPLETION OF THE WORK, THE CONTRACTOR SHALL INSURE THAT ALL SYSTEMS OPERATE AS DESIGNED AND REQUIRED AND SHALL REVIEW THEIR OPERATION WITH THE OWNER AND PROVIDE TRAINING OF THE MAINTENANCE PERSONNEL. COMPLETE SET OF AS-BUILT DRAWINGS SHALL BE COMPILED (BY THE CONTRACTOR) AND ISSUED (1 EACH) TO THE ARCHITECT AND BUILDING MAINTENANCE PERSONNEL UPON COMPLETION OF
- 29. ALL FEEDERS SIZING (BRANCH AND SERVICE ENTRANCE CONDUCTORS) BASED IN AMPACITY OF COPPER THHW CONDUCTORS (NEC 2011 TABLE 310.15(B)(16)) UNLESS OTHERWISE NOTED.
- SO. THE PRIMARY POWER SOURCE FOR SMOKE ALARMS IN DWELLING UNITS SHALL BE REQUIRED TO BE AFCI-PROTECTED FOLLOWING NFPA 72 AND NEC 2011 ART. 210.12.
- 1. RECEPTACLES LOCATED IN DORMITORIES AND LIVING AREAS OF ALL DWELLING UNITS SHALL BE AFCI PROTECTED.
- 52. MINIMUM SERVICE INTERRUPTION OF EXISTING FIELD SHALL BE KEPT TO A MINIMUM. EXISTING TRANSFORMER SHALL REMAIN OPERATIONAL UNTIL NEW TRANSFORMER IS IN PLACE AND SWITCHOVER SHALL OCCUR WITHIN 24 HRS BETWEEN SHUT DOWN & START UP OF NEW POLE & SERVICES.

NATIONAL ELECTRIC CODE NOTES:

ALL WORK SHALL CONFORM TO THE REQUIREMENTS OF NFPA 70 -2014 NATIONAL ELECTRIC CODE

ELECTRICAL SUBMITTAL NOTES:

REVISION

SUBMIT ALL ELECTRICAL SYSTEMS SUBMITTALS AT ONE (1) TIME IN ONE (1) INTEGRAL GROUP. PIECE—BY-PIECE SUBMISSION OF INDIVIDUAL ITEMS WILL NOT BE ACCEPTABLE. ENGINEER MAY CHECK CONTENTS OF EACH SUBMITTAL SET UPON INITIAL DELIVERY; IF NOT COMPLETE AS SET FORTH HEREIN, SUBMITTAL SETS MAY BE RETURNED TO CONTRACTOR WITHOUT REVIEW AND APPROVAL AND WILL NOT BE ACCEPTED UNTIL MADE COMPLETE. SHOP DRAWINGS WILL BE REVIEWED MAXIMUM TWICE AS PART OF THIS CONTRACT. ADDITIONAL SHOP DRAWING REVIEWS SHALL BE INVOICED AT \$85.00 PER HOUR, BILLABLE TO THE SUB-CONTRACTOR.

BY DATE

achieve a lighting design of 50fc minimum.

Poles S4 & S9 Will remain. Poles S10 & S11 will be taken down.

The bases will be demoed

The poles will be demoed

2 x 70 mh steel poles & base

1 x 90'mh steel pole & base

1 x 80'mh steel pole & base

Musco will provide

Foundation Designs

Musco will be providing:

Musco will be providing:

New contactors for the additional poles

this design

49 new fixtures to be attached to the new poles.

Musco Sports Lighting * 2220 Cluster Oak Dr. #H * Clermont, FL 34711

Telephone (352) 243-9999 * Fax (352) 243-2791

UL Listed remote electrical component enclosure a Pole length wire harness:

TYPE OF FIELDS:

DESIGN OBJECTIVE:

NEW POLES:

CONTACTORS

TRUSCO

4 x Pre-cast concrete bases

2 x galvanized 70'mti steel poles

. 1 x galvanized 80 mh steel poles

1x palvanized 99mh steel polex.

Musco C10 Warranty and maintenance

Also Includes:

49 x Factory-aimed and assembled luminaires

. Energy savings of more than 50% over a standard lighting system

. 50% less spill and giere light than Musco's prior industry leading loctinology

September 11, 2018

Re-use existing pole and fixtures and add poles & fixtures where needed to

The fixtures will be removed and re-used on new S10 & S11 poles


In addition, the existing fixtures from existing poles S10 & S11 will be re-used for

SK Designed JAR

Certificate of Authorization #3173


PUKE BY. ABSORPTION BEDS FOR TRANSFORMER PADS FIG 20A UTILITY CONTACT INFORMATION FOR TRANSFORMER COORDINATION INQUIRIES, CONTACT JARED A. BUTTS E & TCR- ENGINEER CONTACT: 727.562.3814 (OFF), 727.401.7878 EMAIL: JARED.BUTTS@DUKE-ENERGY.COM

DEFINED AS A "CRITICAL FACILITY" OR ARE LOCATED IN OR IMMEDIATELY ADJACENT TO PAYED ASSAS THAT CONTAIN STORM DRAINS, CONSULT YOUR DIRKE EMERGY REPRESENTATIVE FOR PROPER APPLICATION OF

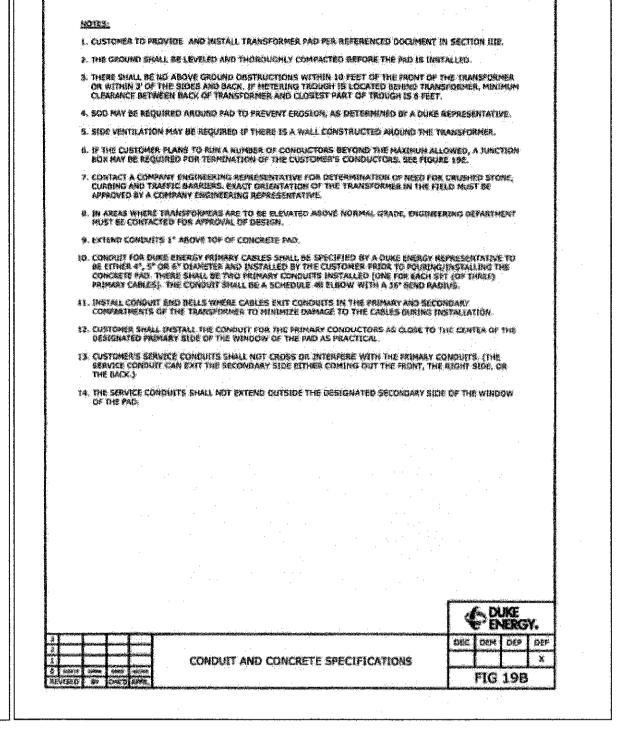


REVISION

Scope Poles P3 & P5 will be added. Existing poles S10 & S111 will be removed New poles for \$10 & \$11 will be supplied The fixtures from existing poles \$10 & \$11 will be added to new poles \$10 & \$11

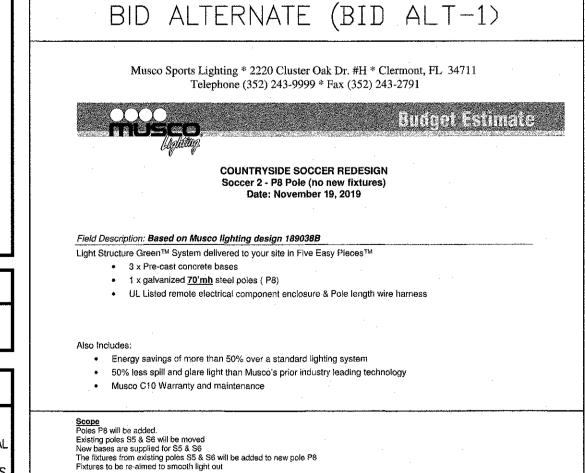

THE ELECTRICAL CONTRACTOR SHALL PROVIDE ALL OTHER ELECTRICAL ITEMS TO PROVIDE A COMPLETE OPERATIONAL SPORT LIGHTING SYSTEM TO THE SATISFACTION OF THE OWNER WITH A 50 FOOT CANDLE MINIMUM AFTER BURN IN OF THE LAMPS. DDAMINO INDEV

DRAWING INDEX			
SHEET NUMBER	DRAWING TITLE		
E0	ELECTRICAL COVER SHEET		
E1	ELECTRICAL EXISTING CONDITION — DEMO PLAN		
E2	ELECTRICAL SITE PLAN		
E3	ELECTRICAL YARD AND SCHEDULES		
E4	REVISED ELECTRICAL RISER DIAGRAM		
E5	PHOTOMETRIC PERFORMANCE DATA		

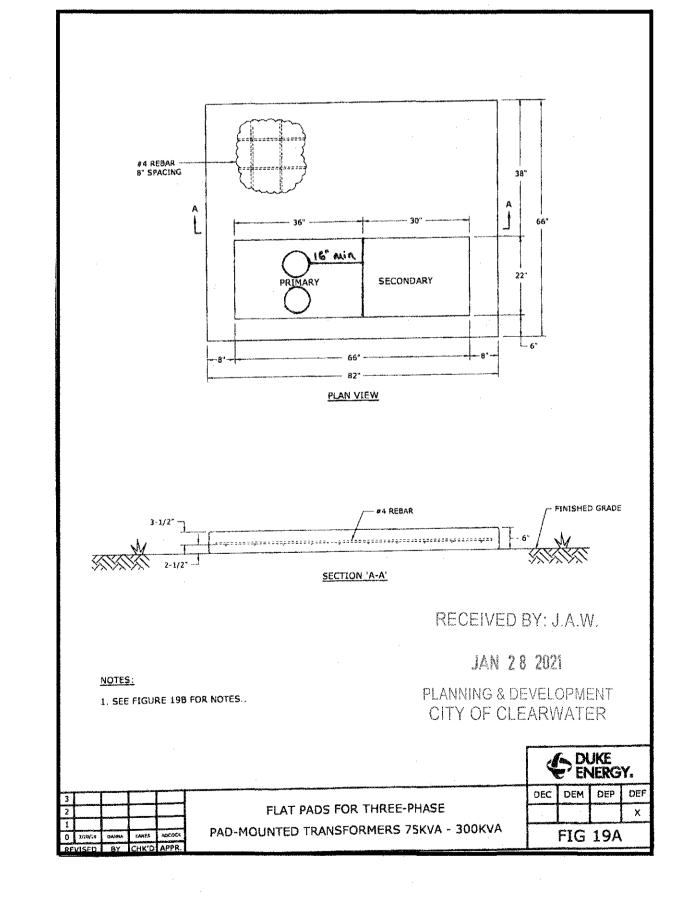

SK/JAR

Clearwater

JOSE A ROSARIO, P.E. 74457

VERT. NONE

HORIZ. 1"=N/A




CLEARWATER CONTRACT NO


CLEARWATER JOB NO.


DATE


2019-XXXX

COUNTRYSIDE SPORTS COMPLEX GE GRINER CITY OF CLEARWATER, FLORIDA FIELD 3 AND 4 RENOVATION PARKS & RECREATION DEPT GRINER ENGINEERING, INC. 1628 First Avenue North 100 S. Myrtle Ave. St. Petersburg, Florida 33713 JAR ELECTRICAL COVER SHEET Phone: (727)-822-2335 Clearwater, Fl 33756 Fax: (727)-821-3361

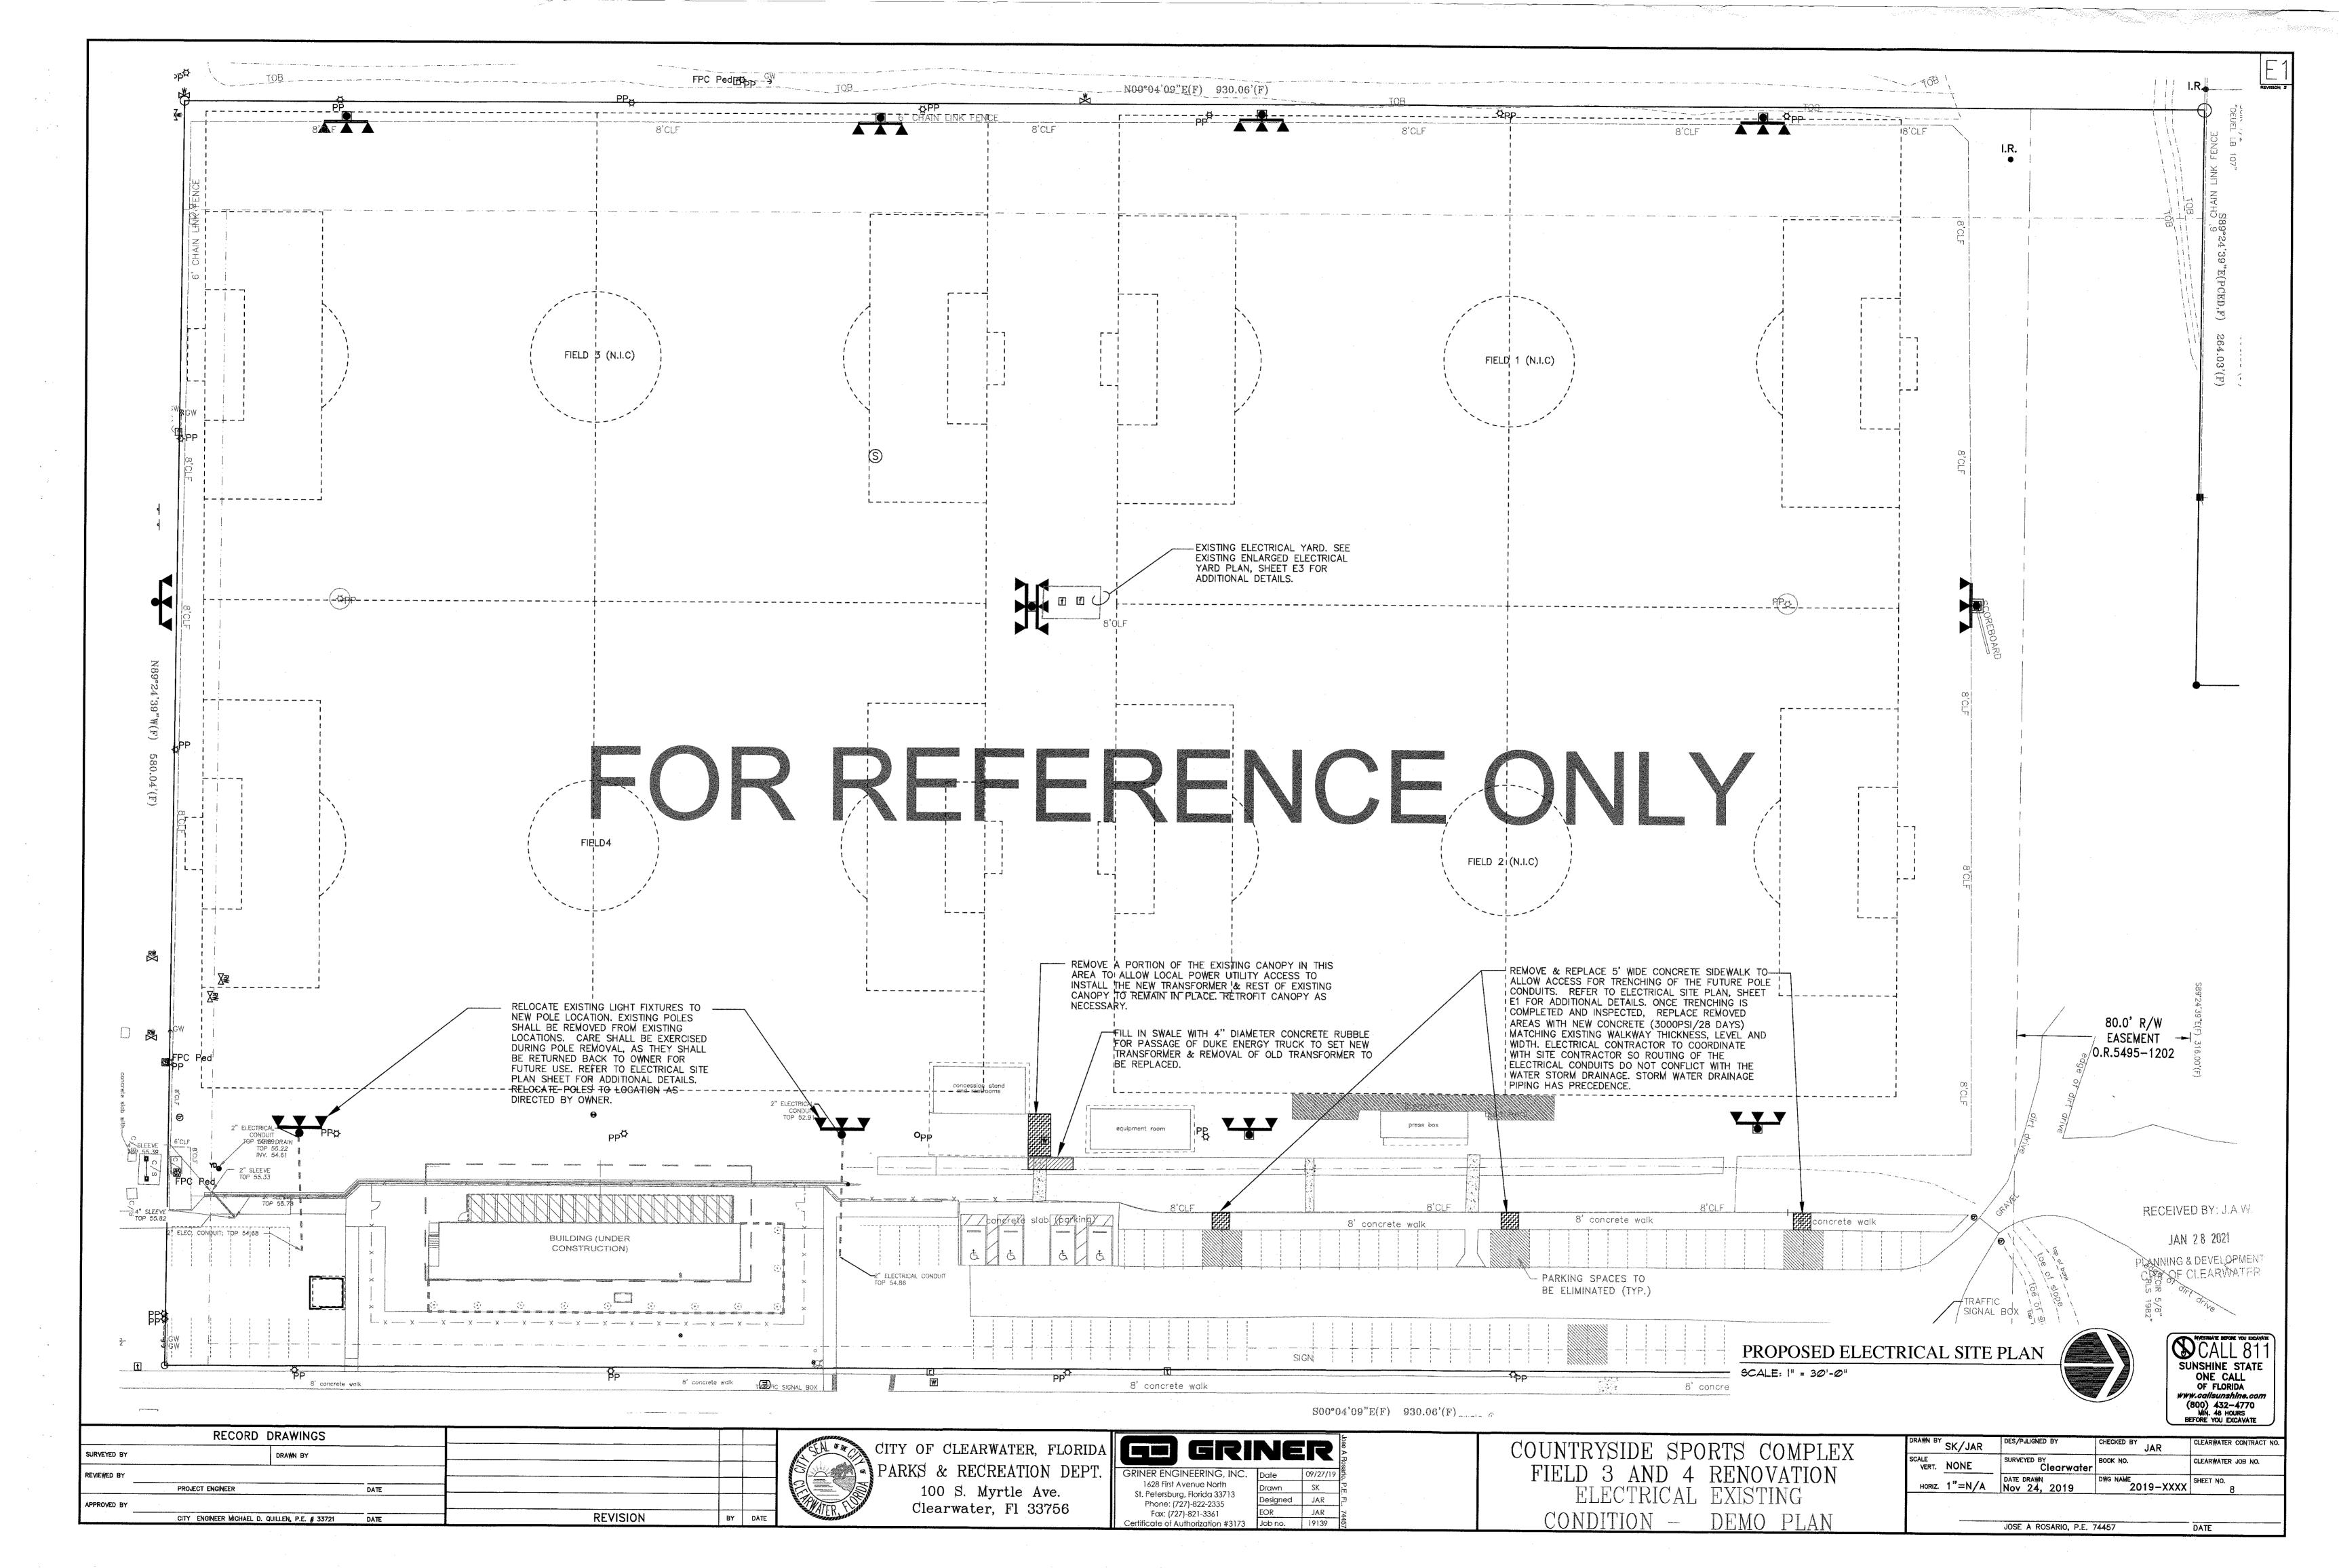

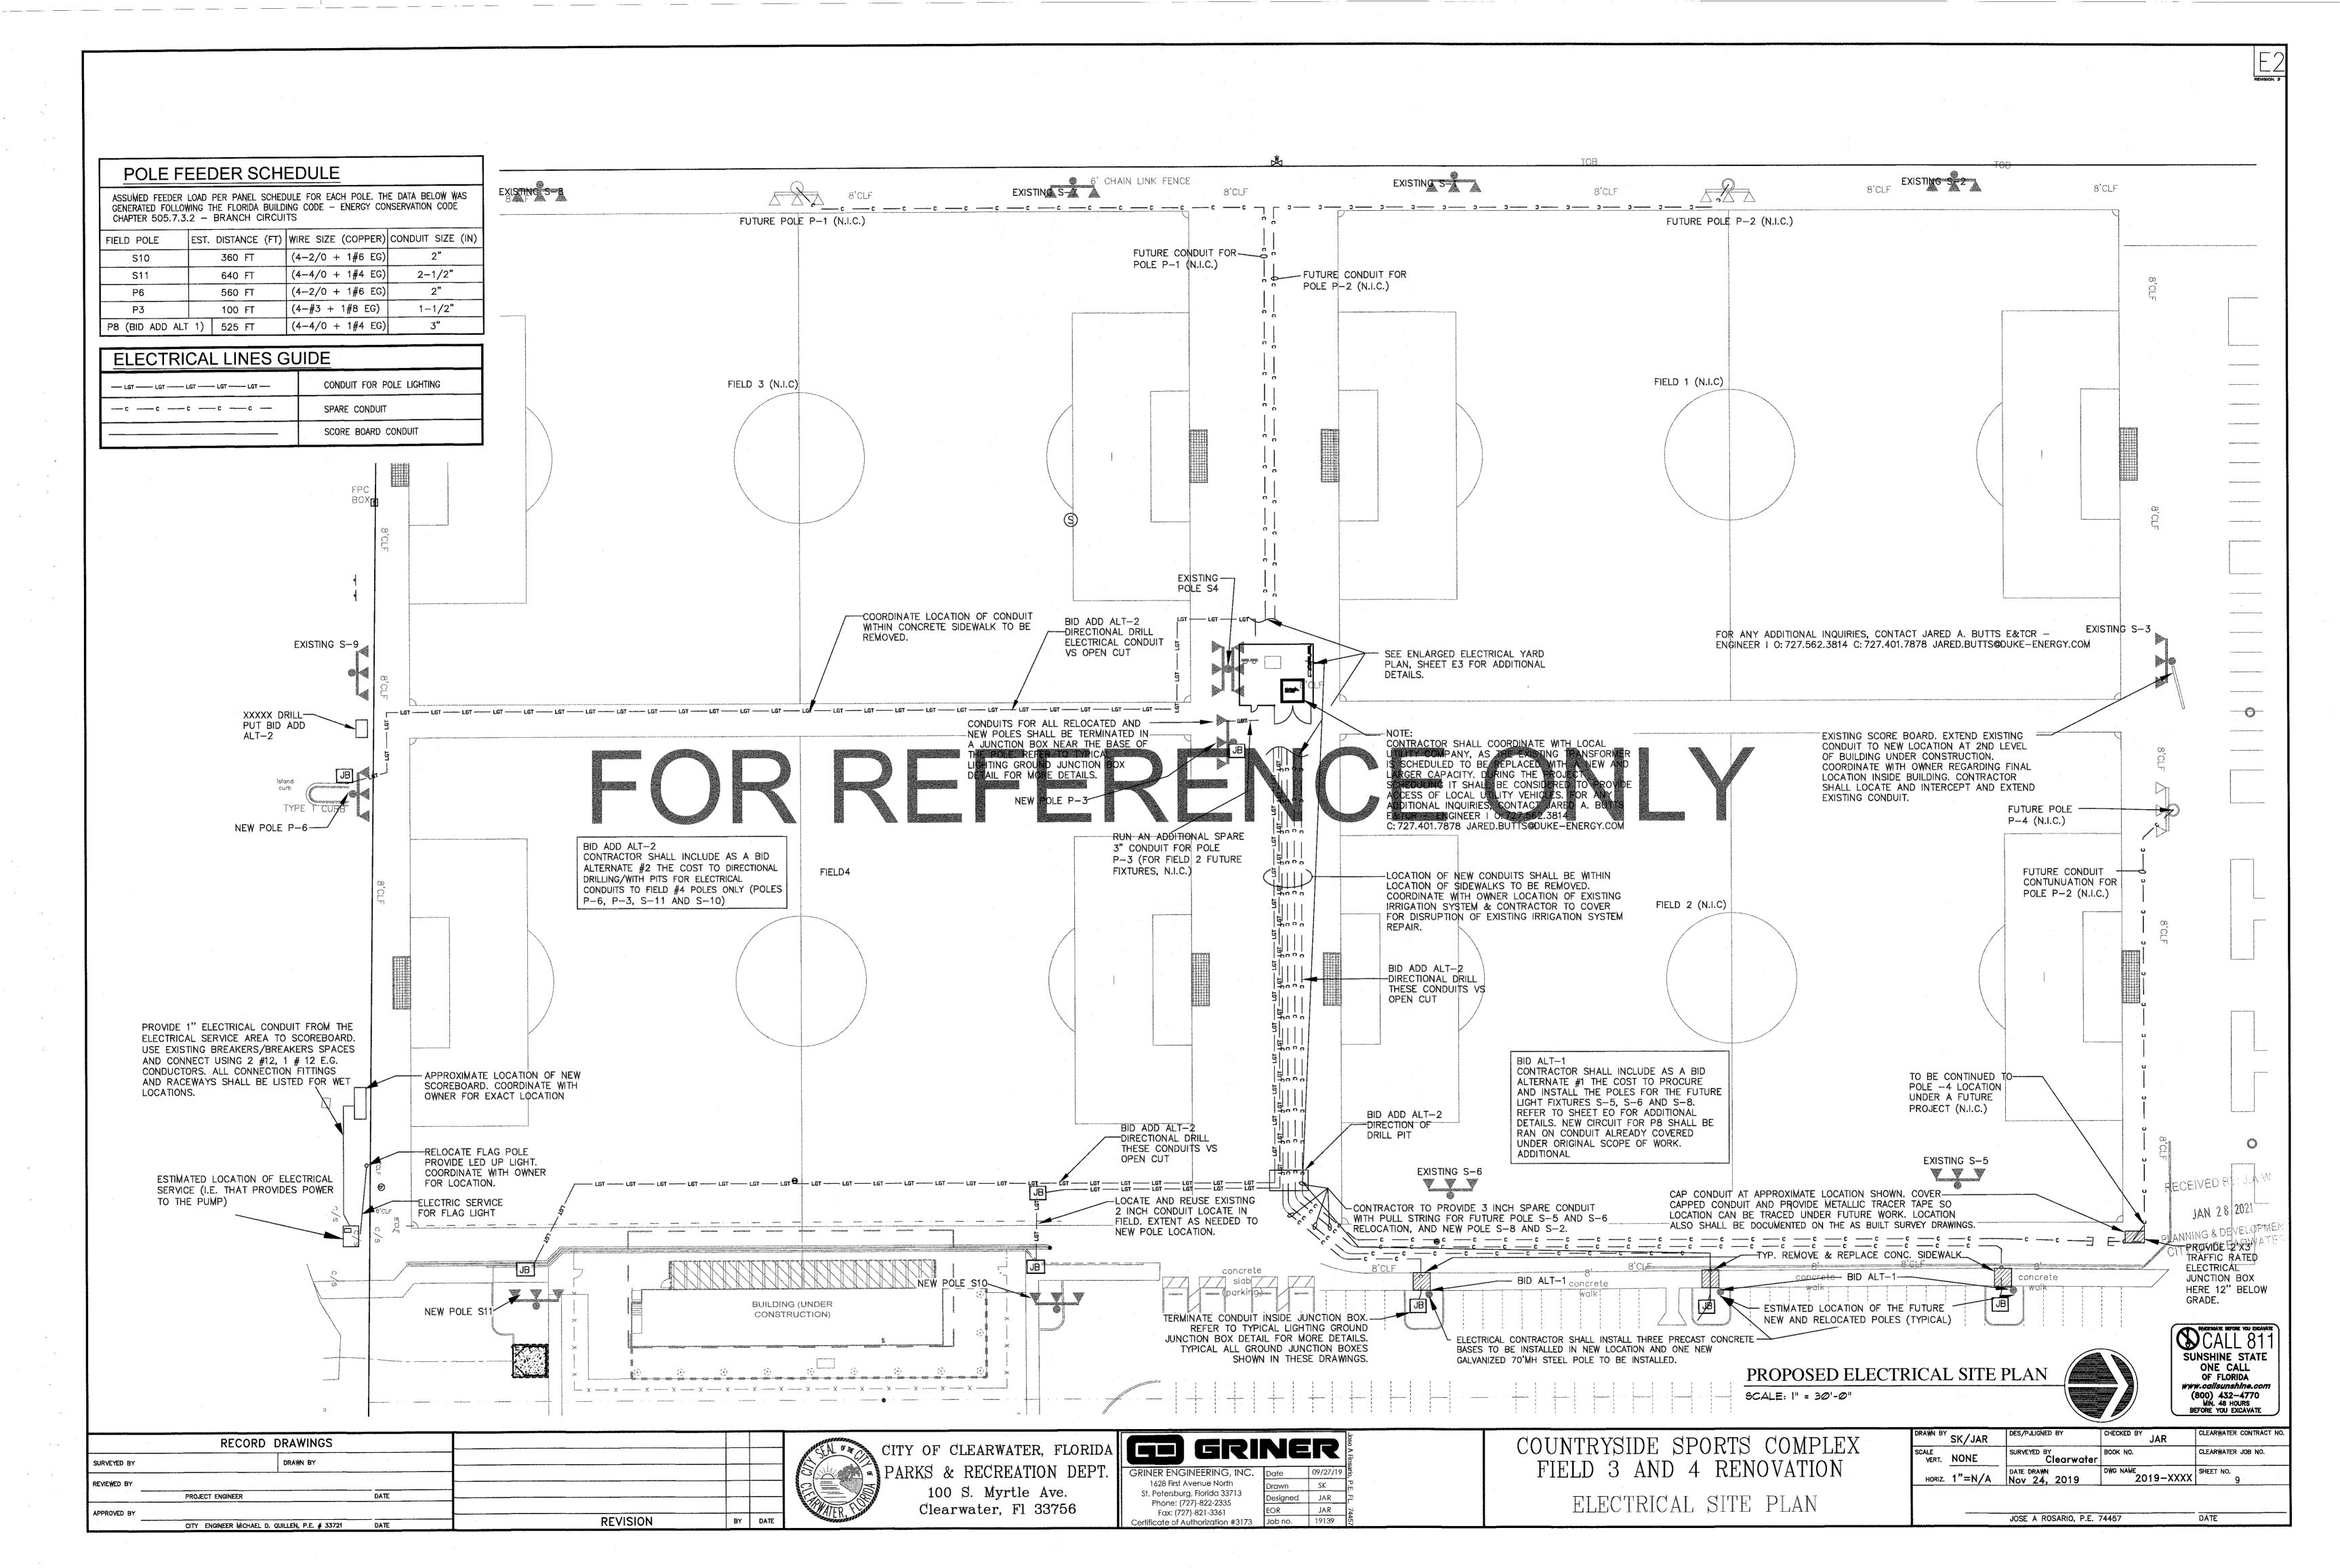

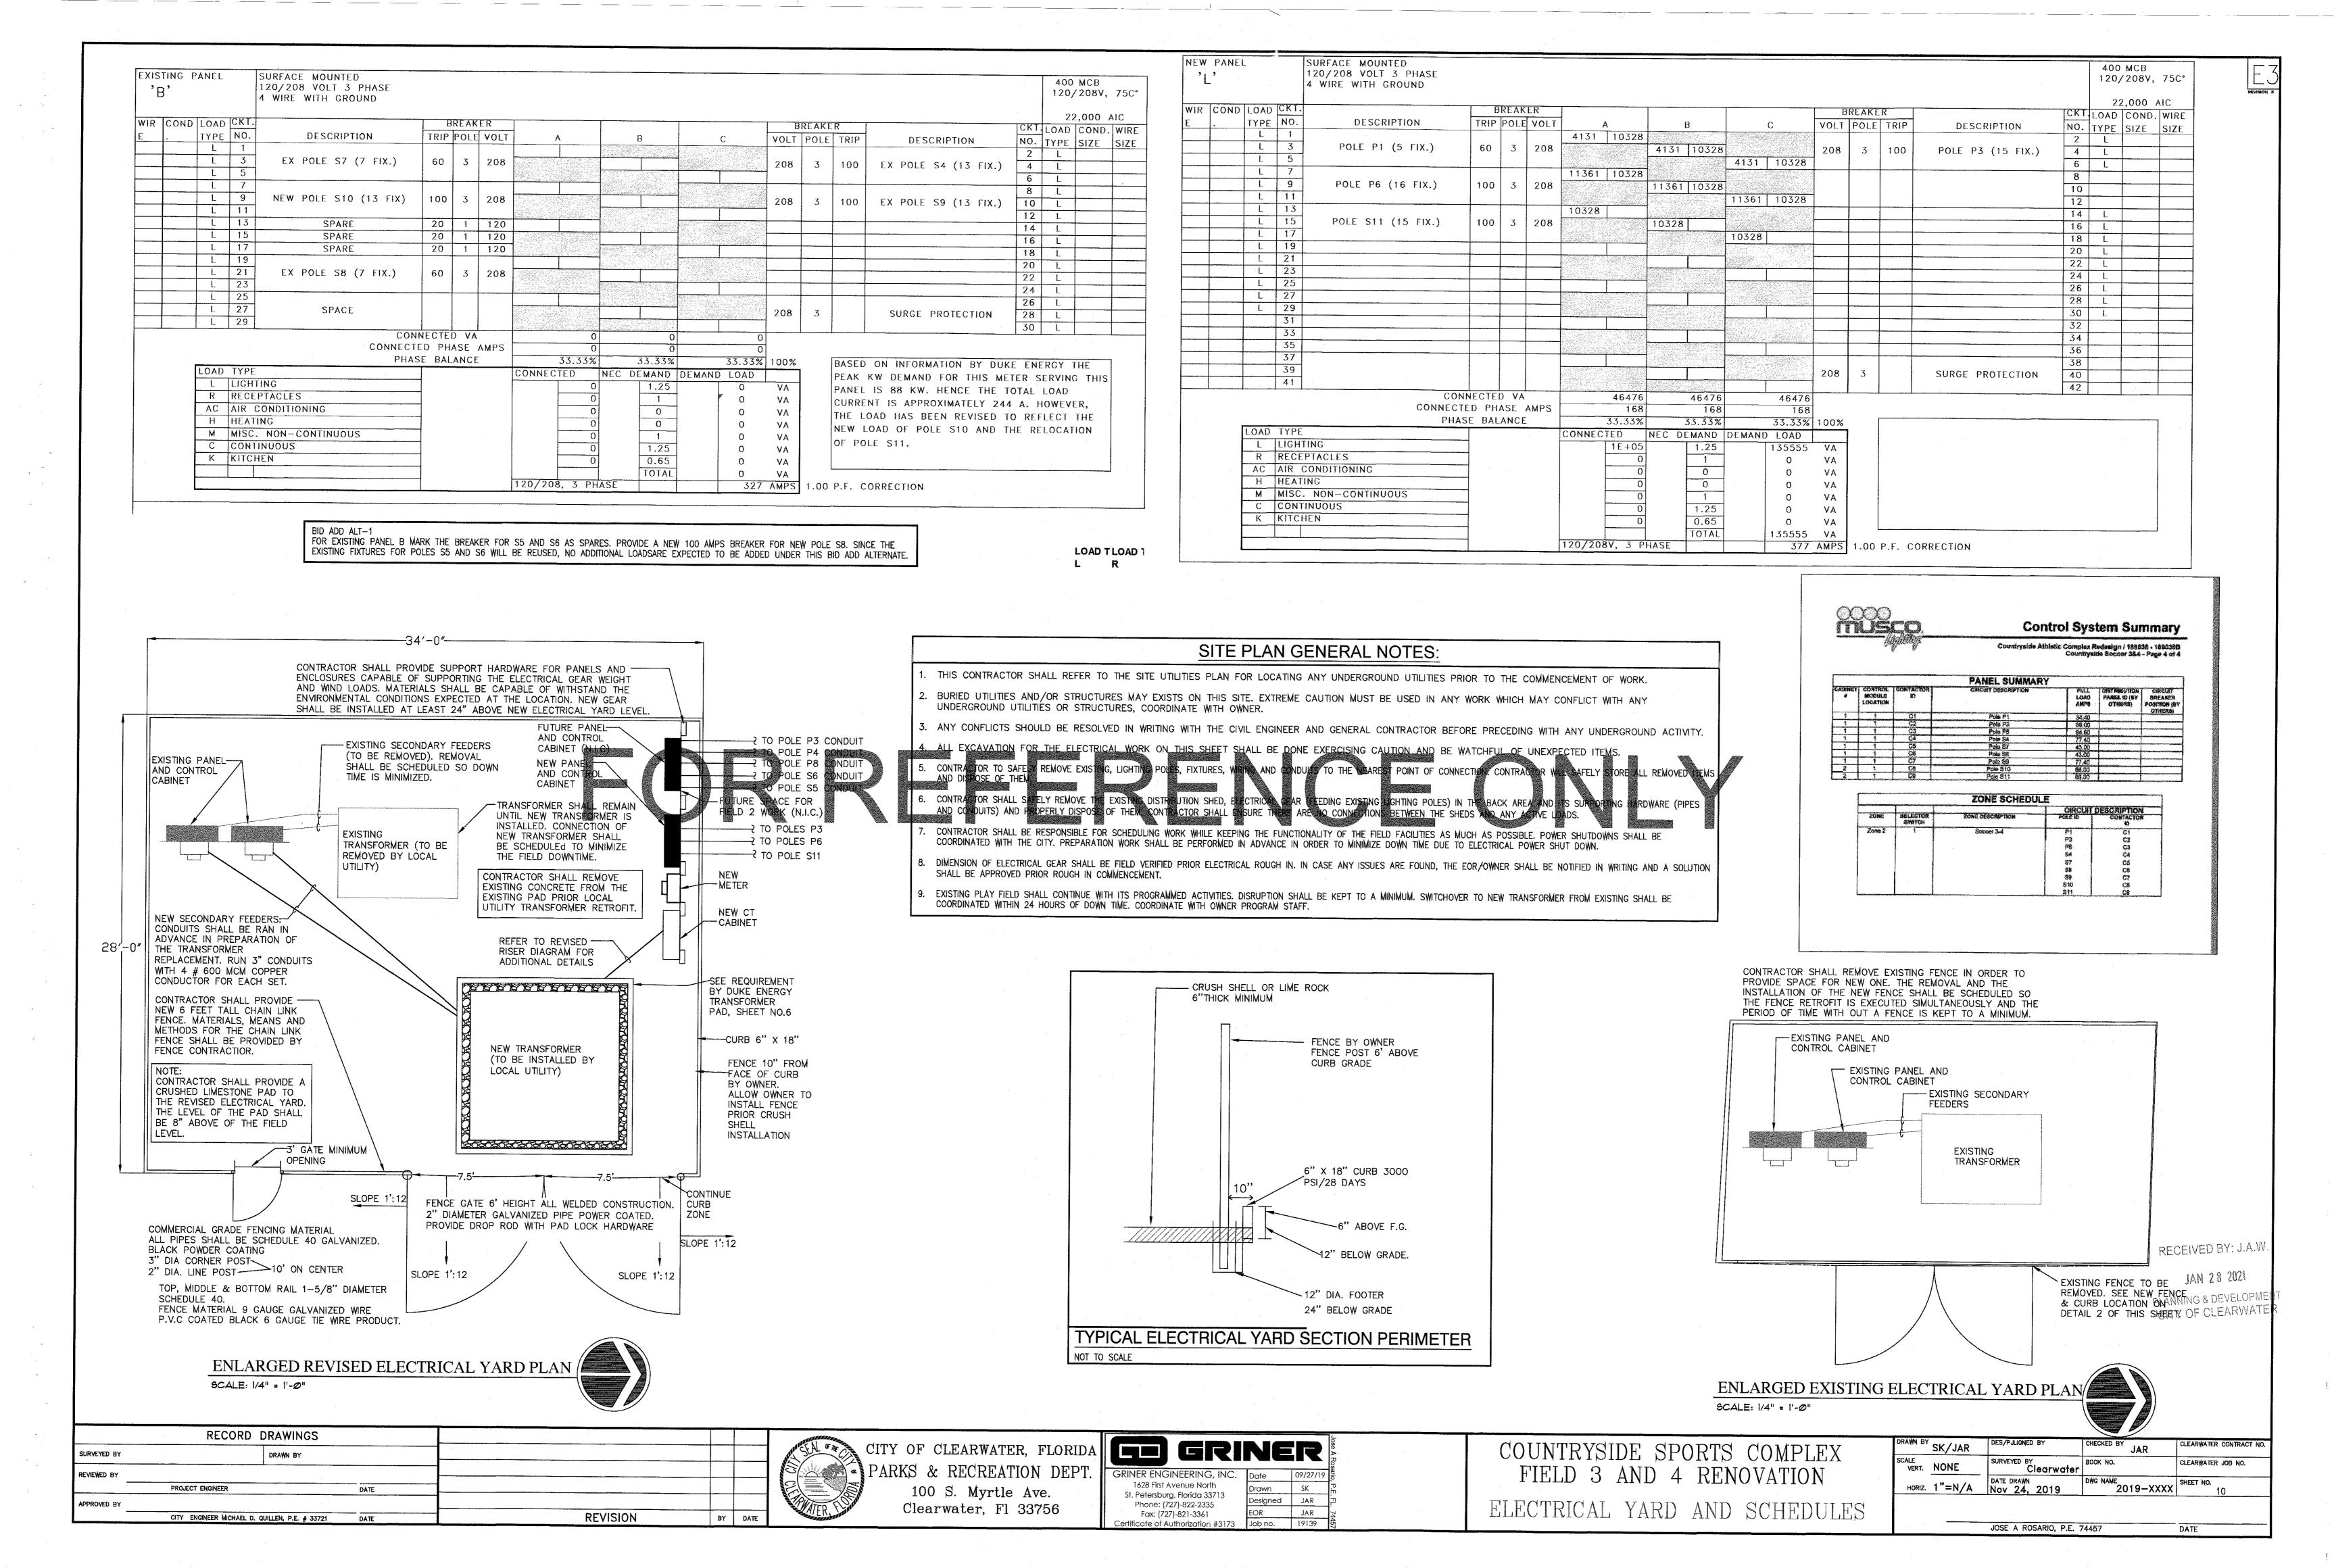

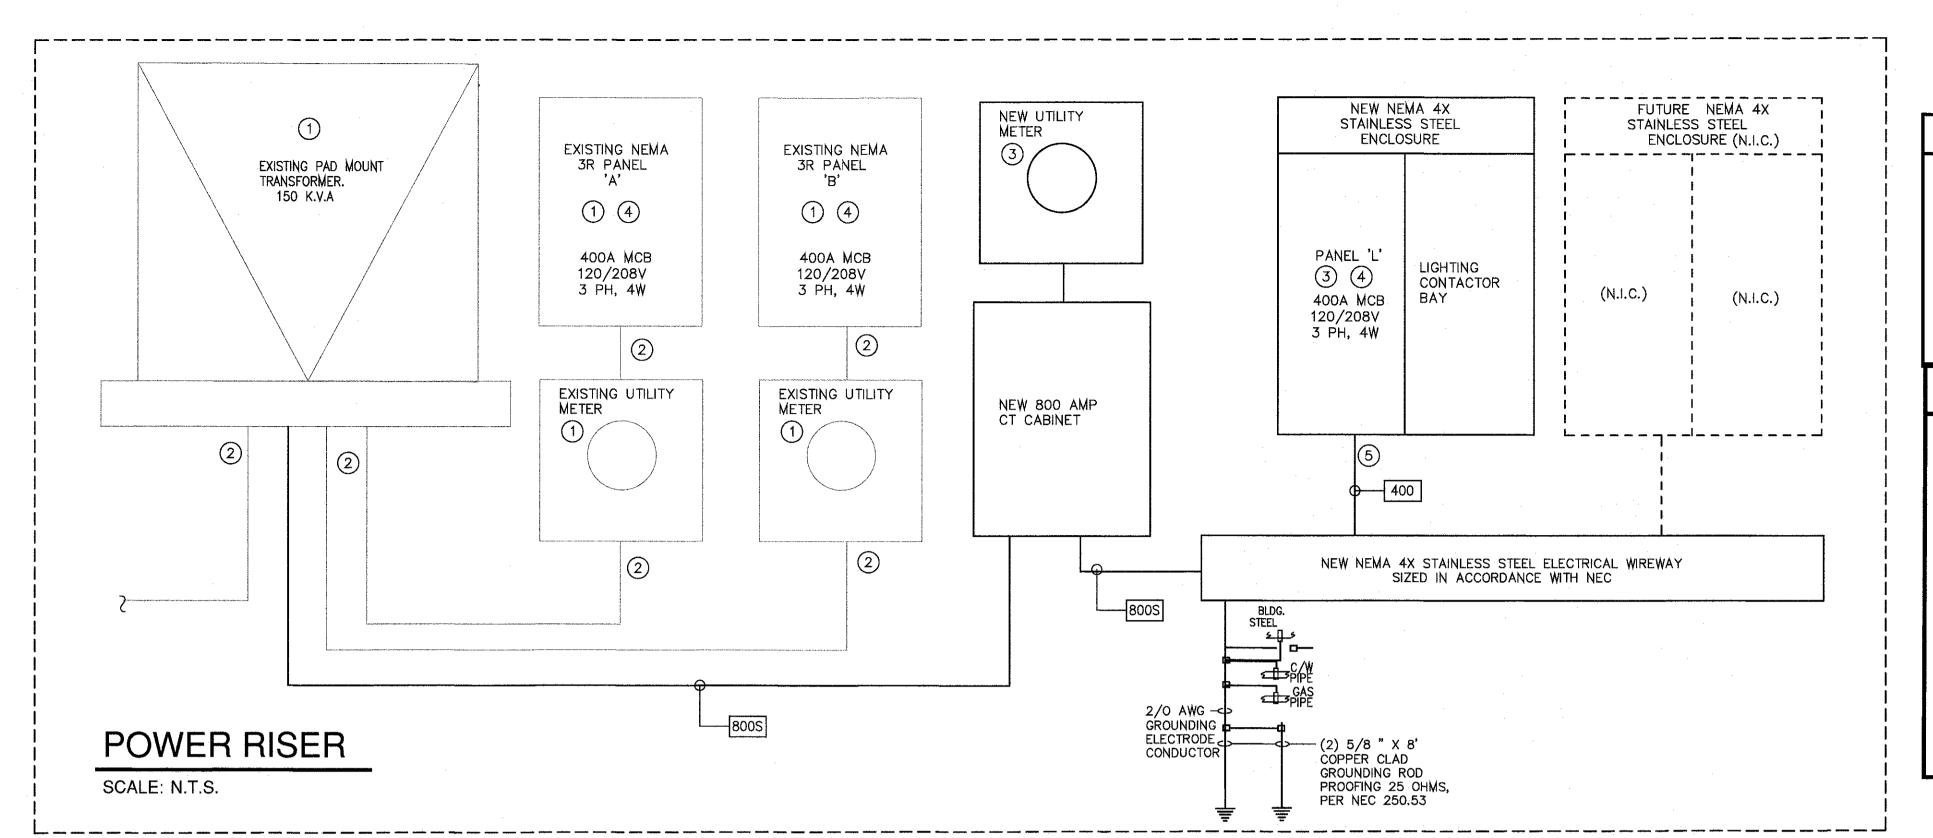

GENERAL NOTES:

- ELECTRICAL CONTRACTOR TO VERIFY EXISTING CONDITIONS AND TO REPORT TO GENERAL CONTRACTOR, OWNER AND ENGINEER ANY DISCREPANCY FROM THAT SHOWN ON DRAWINGS.
- 2. COORDINATE ALL NEW ELECTRICAL WORK WITH CIVIL DRAWINGS GENERAL CONTRACTOR AND OWNER.
- 3. PANELS ARE REQUIRED TO HAVE AN PANELBOARD NAMEPLATE PER NEC 408.4(B) SEE TYPICAL PANELBOARD NAMEPLATE DETAILS (THIS SHEET) FOR MORE INFORMATION

RISER DIAGRAM NOTES:

- EXISTING TRANSFORMER, EXISTING METERS AND EXISTING PANELS TO REMAIN. CONTRACTOR TO VERIFY THE RATINGS OF THESE EXISTING EQUIPMENTS. CONTRACTOR SHALL INCLUDE IN BID AND AND WORK SCOPE TO CONNECT EXISTING DEVICES TO NEW TRANSFORMER ONCE THE TRANSFORMER IN INSTALLED ON SITE.
- EXISTING FEEDERS TO REMAIN. VERIFY EXISTING FEEDERS TO VERIFY CURRENT CAPACITY.
- 3. PROVIDE 1 NEW 400 AMPS M.C.B PANEL 'L' AND 1 NEW UTILITY METER.
- CONTRACTOR SHALL FURNISH AND INSTALL SURGE SUPPRESSION FOR ALL PANELS (EXISTING & NEW) RATED FOR PANEL AMPERAGE AND VOLTAGE AVAILABLE AT THE PANEL
- FURNISH AND INSTALL NEW (2) SET 4# 3/0, 1# 3 GND- IN EACH OF (2) 2-1/2 " C AND CONNECT AS SHOWN.
- THERE IS A POSSIBLE CHANCE WE MIGHT HAVE TO CHANGE THE EXISTING TRANSFORMER AND PROVIDE A NEW PAD MOUNTED TRANSFORMER SINCE WE ARE INSTALLING A NEW PANEL. CO-ORDINATION WITH DUKE ENERGY WOULD BE

SERVICE VOLTAGE DROP

BRANCH CIRCUITS LOADED PER NEC AMPACITY WITH RUNS LESS THAT 75 FEET SHOULD PROVIDE ACCEPTABLE VOLTAGE DROPS PER INTERNATIONAL BUILDING CODE 2012 CONTRACTOR SHALL INCREASE THE SIZE BY 1 NOMINAL SIZE PER EACH 50 FEET OF WIRING.

GENERAL INTERNATIONAL BUILDING CODE NOTES:

LL ELECTRICAL WORK SHALL COMPLY WITH INTERNATIONAL BUILDING


C405.6.3 VOLTAGE DROP

THE CONDUCTORS FOR FEEDERS AND BRANCH CIRCUITS COMBINED SHALL BE SIZED FOR A MAXIMUM OF 5 PERCENT VOLTAGE DROP


GENERAL NOTES:

- ELECTRICAL CONTRACTOR TO VERIFY EXISTING CONDITIONS AND TO REPORT TO GENERAL CONTRACTOR, OWNER AND ENGINEER ANY DISCREPANCY FROM THAT SHOWN ON DRAWINGS.
- COORDINATE ALL NEW ELECTRICAL WORK WITH MECHANICAL CONTRACTOR AND OWNER.
- PANELS ARE REQUIRED TO HAVE AN PANELBOARD NAMEPLATE PER NEC 408.4(B) SEE TYPICAL PANELBOARD NAMEPLATE DETAILS SHEET E300 FOR MORE INFORMATION

UTILITY TRANSFO	120/208V 3 PH	
ASSUMED NEW TR	ANSFORMER BANK SIZE	300KVA
ASSUMED AFC AT	23,800 AMPS	
BUS	ESTIMATED AVAILABLE FAULT CURRENT	MINIMUM AIC & SCCR
PANEL 'L'	21,290 AMPS	35000 AMPS MIN.
FAULT CURRENT	TION HAS BEEN ALLOCATE C AGE INTERRUPTING CAPAC	

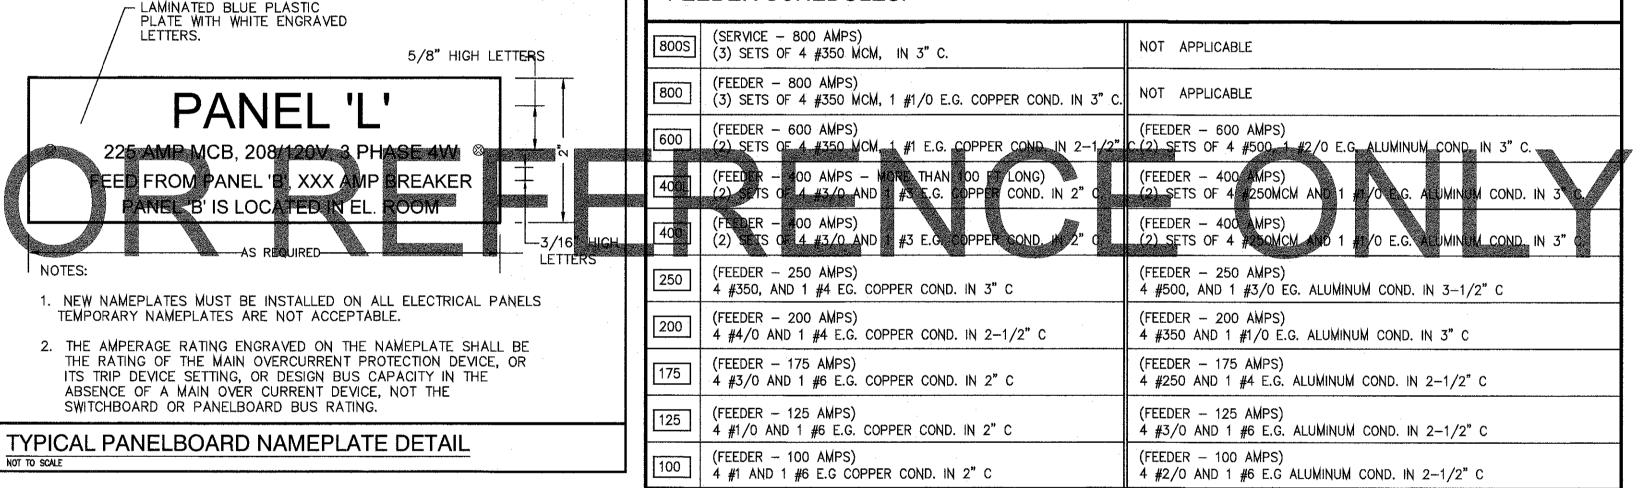

FEEDER SCHEDULES:

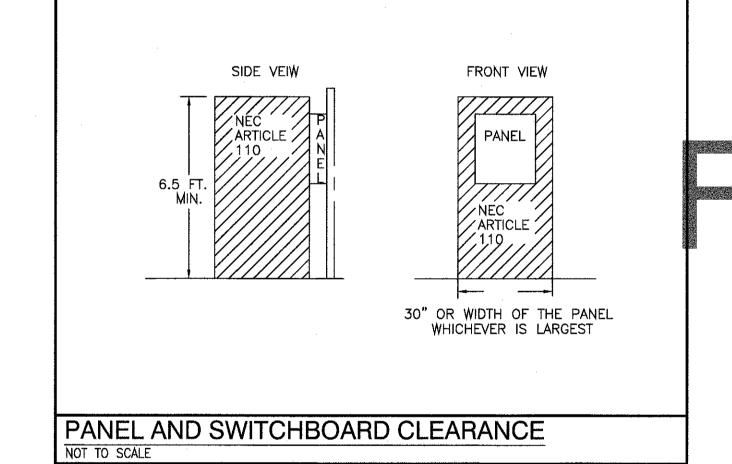


PANEL A.I.C. RATING 42,000A FULL RATED

(A.I.C. DECAL — EXAMPLE)

CONTRACTOR SHALL PROVIDE DECAL 1-1/2" x 2-1/2" WITH 3/16" LETTERING STATING THE A.I.C. RATING OF EACH PANEL. THIS DECAL SHALL BE LOCATED ON THE INSIDE OF PANEL DOOR. DECAL SHALL BE WHITE BACKGROUND WITH BLACK LETTERING WITH A CLEAR PLASTIC LAMINATE TOP COVER OVER DECAL.

A.I.C. IDENTIFICATION DECAL NOT TO SCALE

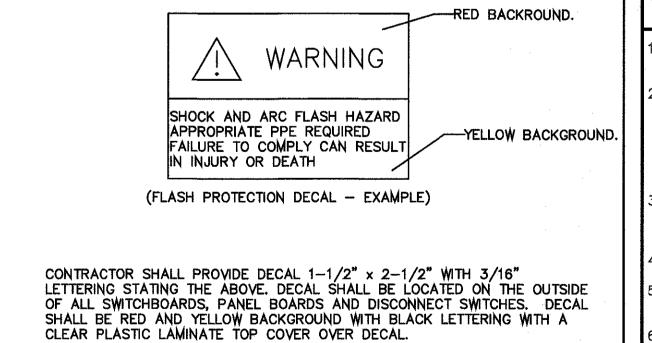


FLASH PROTECTION DECAL

NOT TO SCALE

RISER GENERAL NOTES:


- ELECTRICAL CONTRACTOR TO VERIFY EXISTING CONDITIONS AND TO REPORT TO GENERAL CONTRACTOR, OWNER AND ENGINEER ANY DISCREPANCY FROM THAT SHOWN ON DRAWINGS.
- ELECTRICAL CONTRACTOR SHALL REQUEST THE DRAWINGS OF ALL OTHER DISCIPLINES APPLICABLE TO THIS SCOPE OF WORK AND CAREFULLY REVIEW ALL DRAWINGS BEFORE WORK COMMENCEMENT OR BID SUBMITTAL. IS THE RESPONSIBILITY OF THE ELECTRICAL CONTRACTOR TO PROVIDE ANY ADDITIONAL DEVICE REQUIRED FOR A COMPLETE AND FULLY FUNCTIONAL WORK OF SCOPE THAT IS NOT COVERED ON THESE DRAWINGS. COORDINATE ALI NEW ELECTRICAL WORK WITH CONTRACTORS OF ALL TRADES AND OWNER.
- PANELS ARE REQUIRED TO HAVE AN PANELBOARD NAMEPLATE PER NEC 408.4(B) SEE TYPICAL PANELBOARD NAMEPLATE DETAILS, ELECTRICAL DETAILS SHEET FOR MORE INFORMATION
- FOR SPECIFIC EQUIPMENT LOCATION, REFER TO ARCHITECTURAL DRAWINGS
- ALL ELECTRICAL RUNS SHALL BE NO LEES THAT AWG #12 COPPER CONDUCTORS, UNLESS OTHERWISE NOTED.
- AN EQUIPMENT GROUNDING CONDUCTOR SHALL BE INSTALLED IN ALL ELECTRICAL RACEWAYS AND SHALL BE SIZED IN ACCORDANCE WITH ARTICLE 250-122 OF THE NATIONAL ELECTRICAL
- . ALL PANELS SHALL HAVE AN AIC AND SCCR OF 22,000 AMPS MINIMUM.

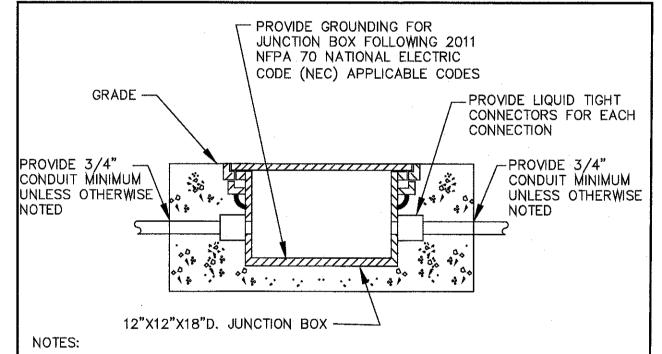

- 1. REFER TO SITE DRAWINGS FOR ADDITIONAL CONDUIT AND CONDUCTOR DETAILS. 2. JUNCTION BOX SHALL BE TRAFFIC RATED AND MADE OF CONCRETE FIBER.
- TYPICAL FOR JUNCTION BOX AND LID. 3. ANY ELECTRICAL JUNCTION BOXES LOCATED IN PLAY FIELD SHALL BE LOW GRADE. MINIMUM 12" FROM FINISH GRADE, SURVEY POINTS SHALL BE PROVIDE TO CENTER OF J-BOX FOR FUTURE LOCATION OF ELECTRICAL J-BOX.

TYPICAL LIGHTING GROUND JUNCTION BOX

NOT TO SCALE

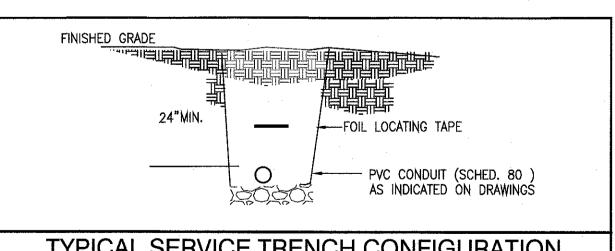


TYPICAL SERVICE TRENCH CONFIGURATION

NOT TO SCALE

JAN 28 2021 PLANNING & DEVELOPMENT CITY OF CLEARWATER

JBY: J.A.W.


	RECORD DRAWINGS			
SURVEYED BY	DRAWN BY			
REVIEWED BY		, , , , , , , , , , , , , , , , , , , 		
	PROJECT ENGINEER	DATE		
APPROVED BY				
	CITY ENGINEED MICHAEL D. OURLEN, D.E. # 22701	DATE	REVISION BY	DATE

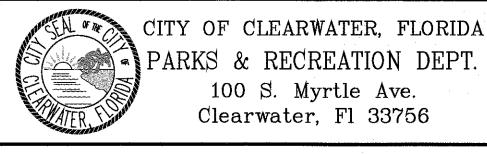


GE GRI	NE	R	Jose A Ros
GRINER ENGINEERING, INC.	Date	09/27/19	ario
1628 First Avenue North	Drawn	SK	
St. Petersburg, Florida 33713 Phone: (727)-822-2335	Designed	JAR	<u> </u>
Frione: (727)-622-2333 Fax: (727)-821-3361	EOR	JAR	. 74
Certificate of Authorization #3173	Job no.	19139	457


COUNTRYSIDE SPORTS COMPLEX FIELD 3 AND 4 RENOVATION REVISED ELECTRICAL RISER DIAGRAM


DRAWN BY	SK/JAR	DES/PJLIGNED BY	CHECKED BY JAR	CLEARWATER CONTRACT NO
SCALE VERT.	NONE	SURVEYED BY Clearwater	воок но.	CLEARWATER JOB NO.
HORIZ.	1"=N/A	Nov 24, 2019	DWG NAME 2019-XXXX	SHEET NO.

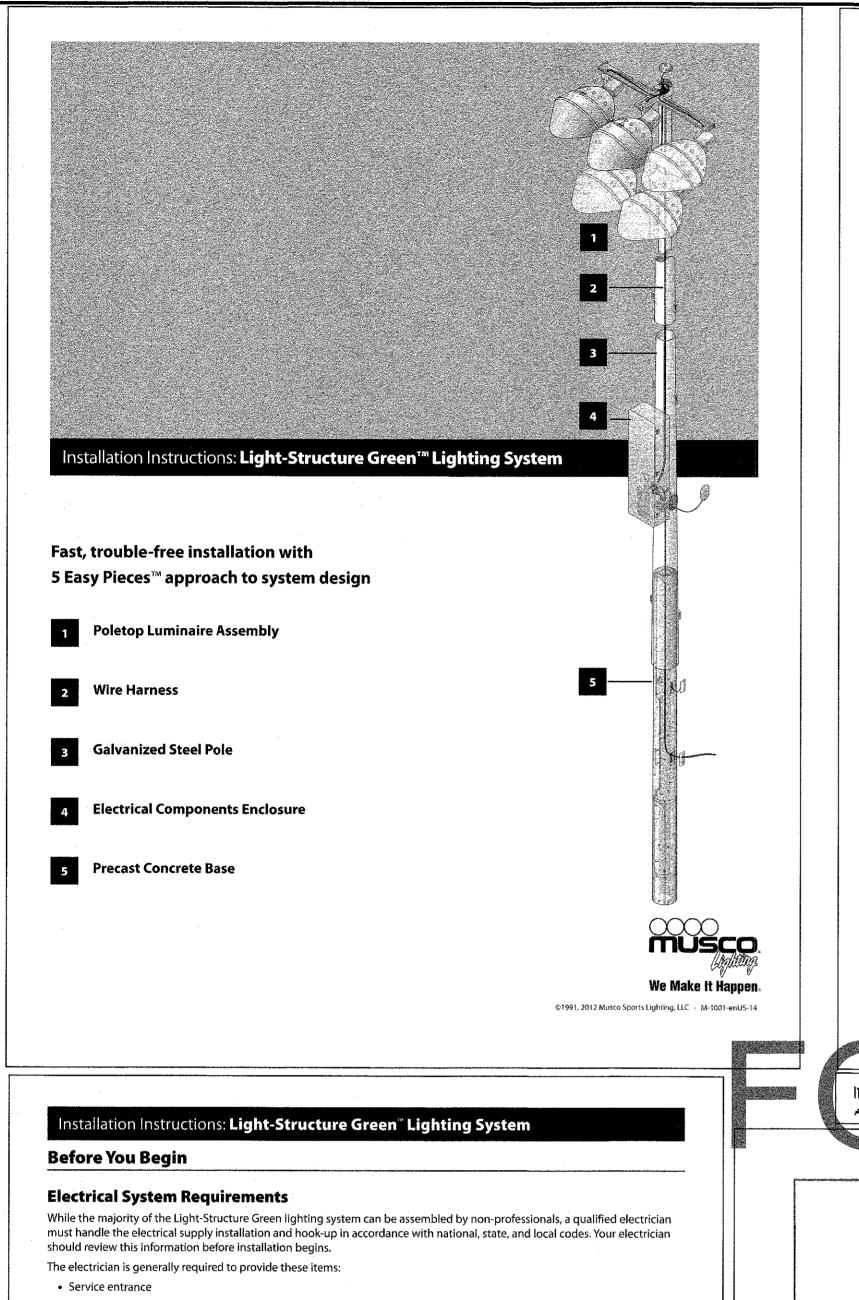

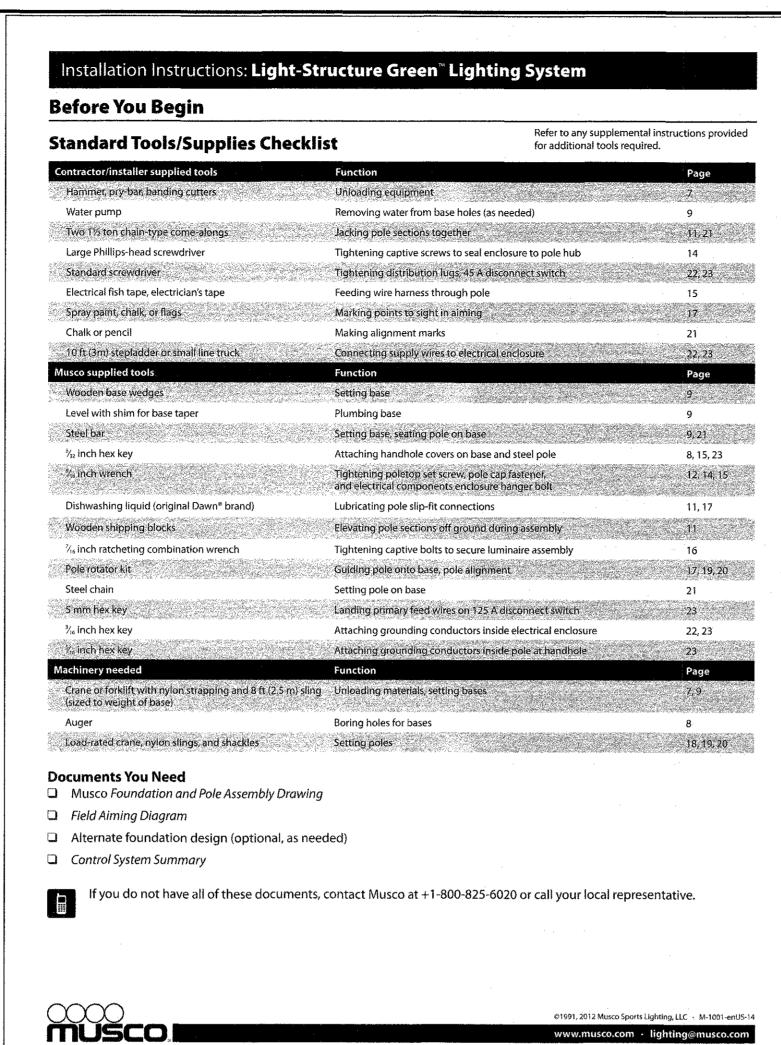



OR REFERENCE ONLY

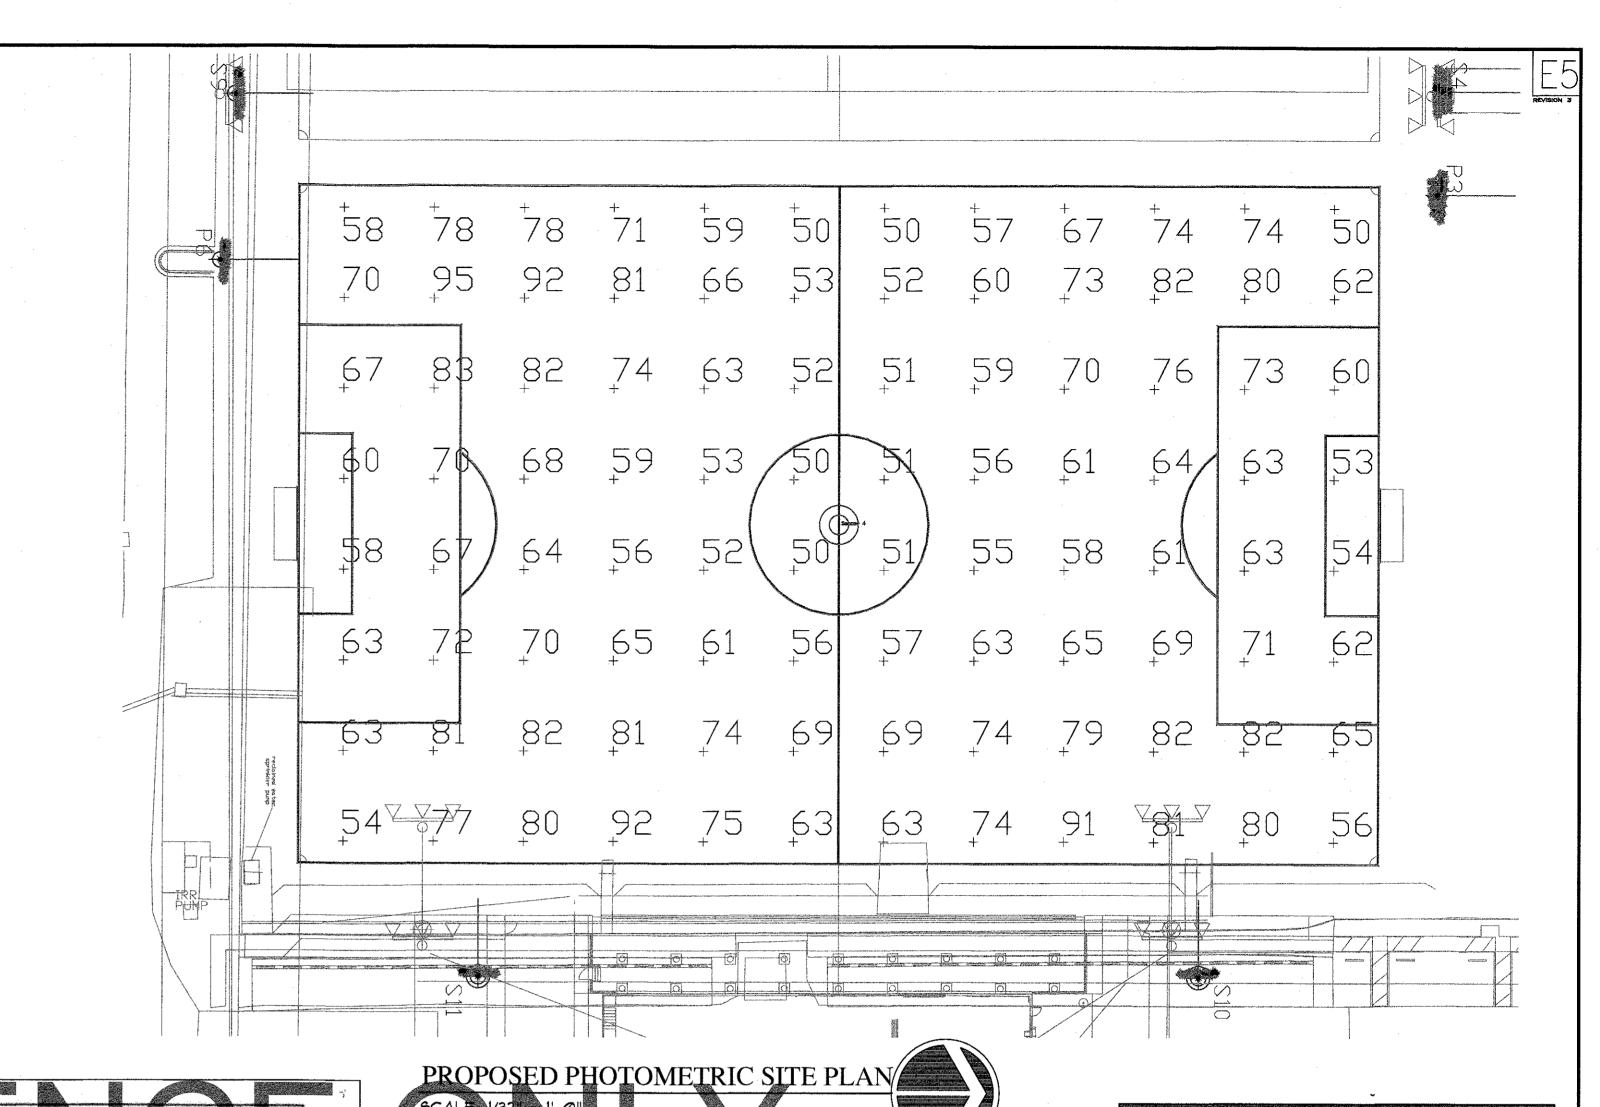

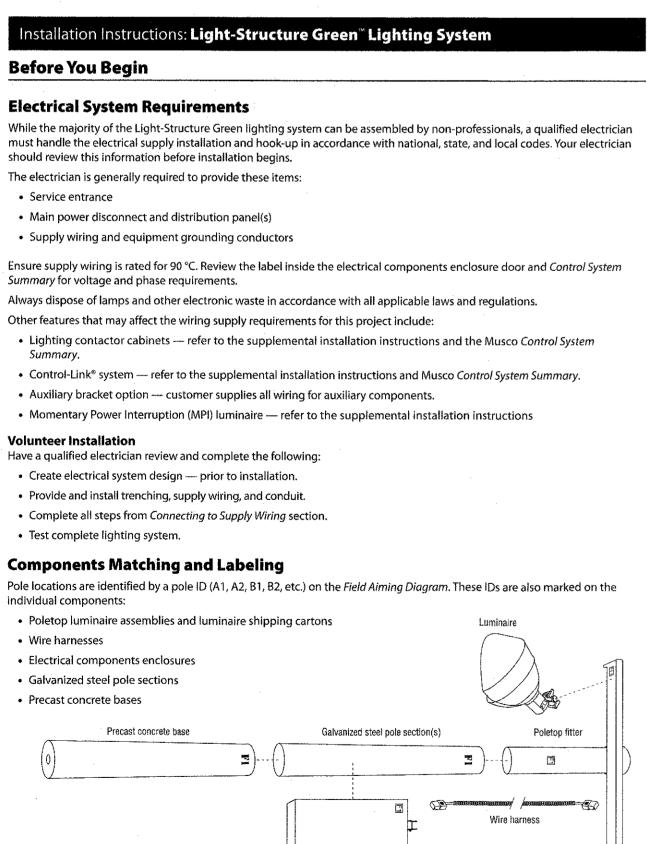

Electrical components enclosure

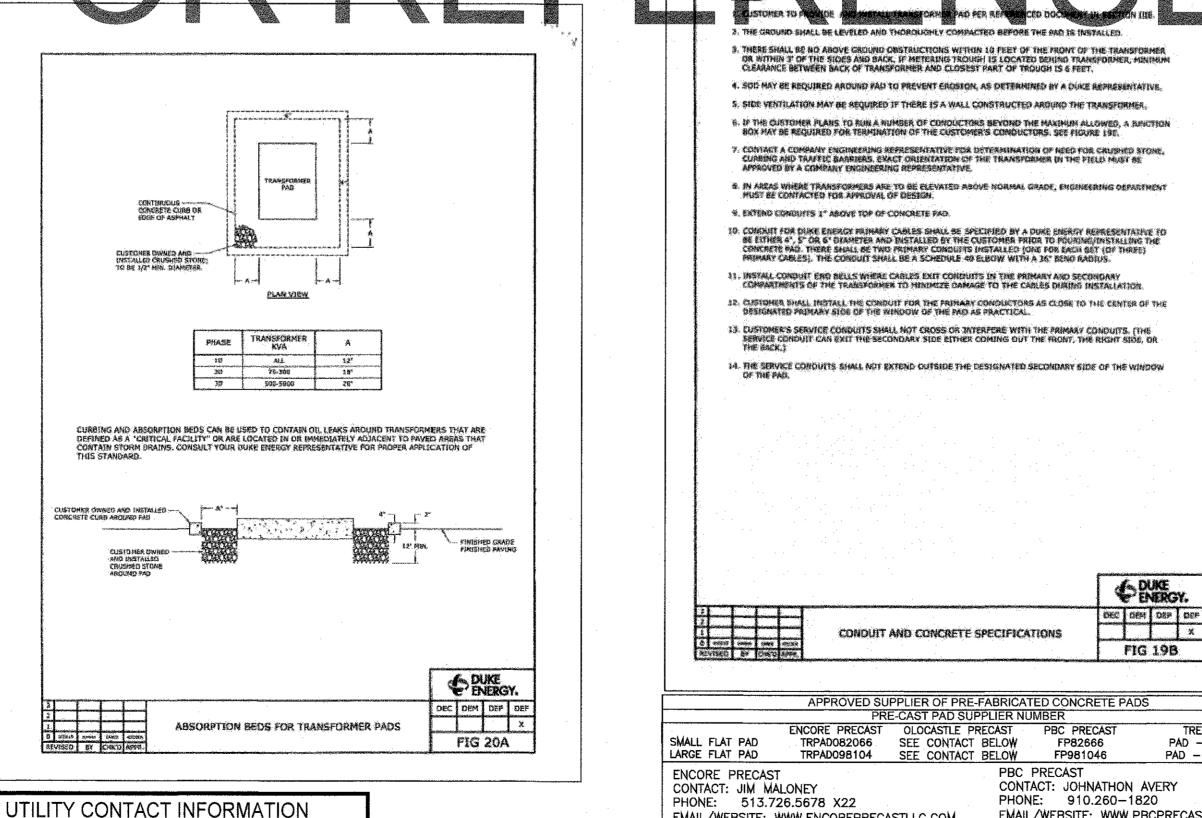

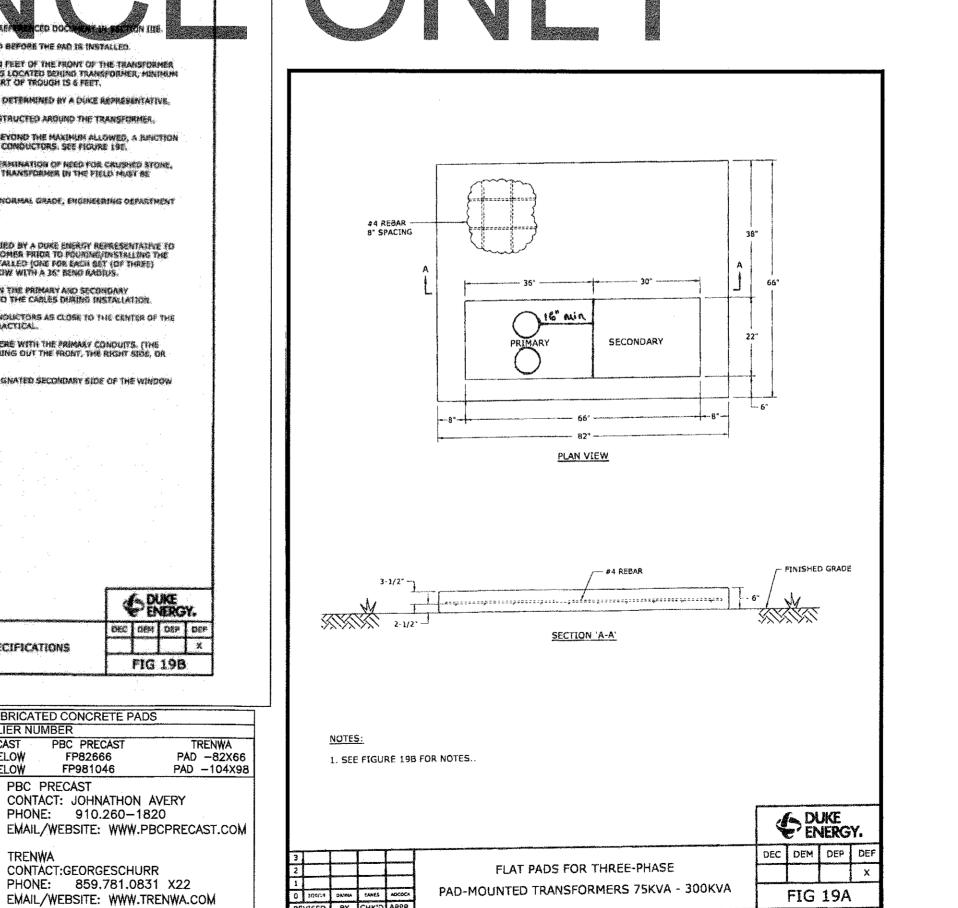

GRID SUMMARY Name: Soccer 4 Size: 360.0' x 225.0' Spacing: 30.0' x 30.0' Height: 3.0' above grade CONSTANT ILLUMINATION HORIZONTAL FOOTCANDLES **Entire Grid** Scan Average: Maximum Minimum Avg / Min: 1.34 Max / Min: UG (adjacent pts): 0.41 0.17 Application Efficacy: No. of Points: UMINAIRE INFORMATION Luminaire Type: Green Generation Design Usage Hours: 5,000 hours Design Lumens: 134,000 Avg Lamp Tilt Factor: 1.000 No. of Luminaires: 106 Avg KW: 165.78 (180.2 max) **Guaranteed Performance:** The CONSTANT ILLUMINATION described above is guaranteed for the design usage hours of the system. Field Measurements: Illumination measured in accordance with

Location: Clearwater,FL

Name: Countryside Athletic Complex Redesign


MY PROJECT

IESNA RP-6-15 and CIBSE LG4. Individual values may vary. See the Warranty document for details. **Electrical System Requirements:** Refer to Amperage Draw Chart and/or the "Musco Control System Summary" for electrical sizing.

Installation Requirements: Results assume +/- 3% nominal voltage at line side of the ballast and structures located within 3 feet (1m) of design locations CEIVED BY: J.A.W.

PLANNING & DEVELOPMEN CITY OF CLEARWATER

RECORD DRAWINGS SURVEYED BY DRAWN BY REVIEWED BY PROJECT ENGINEER DATE APPROVED BY CITY ENGINEER MICHAEL D. QUILLEN, P.E. # 33721

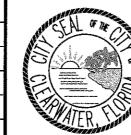

FOR TRANSFORMER COORDINATION INQUIRIES,

CONTACT: 727.562.3814 (OFF), 727.401.7878

EMAIL: JARED.BUTTS@DUKE-ENERGY.COM

REVISION

CONTACT JARED A. BUTTS E & TCR- ENGINEER

ENERGY, SHOWN

CITY OF CLEARWATER, FLORIDA PARKS & RECREATION DEPT. 100 S. Myrtle Ave. Clearwater, Fl 33756

G GRINER GRINER ENGINEERING, INC. 1628 First Avenue North St. Petersburg, Florida 33713 JAR Phone: (727)-822-2335 JAR Fax: (727)-821-3361

Certificate of Authorization #3173

CONTACT:GEORGESCHURR

PHONE: 859.781.0831 X22

EMAIL/WEBSITE: WWW.TRENWA.COM

EMAIL/WEBSITE: WWW.ENCOREPRECASTLLC.COM

EMAIL: Alex.Palomegue@oldcastle .com WEBSITE: WWW.OLDCASTLEINFRASTRUCTURE .COM

OLDCASTLE PRECAST

PHONE:

CONTACT: ALEX PALOMEQUE

704. 788.4050

COUNTRYSIDE SPORTS COMPLEX FIELD 3 AND 4 RENOVATION PHOTOMETRIC PERFORMANCE DATA

DRAWN BY	SK/JAR	DES/PJLIGNED BY	CHECKED BY JAR	CLEARWATER CONTRACT
SCALE VERT.	NONE	SURVEYED BY Clearwater	BOOK NO.	CLEARWATER JOB NO.
HORIZ.	1"=N/A	Nov 24, 2019	DWG NAME 2019-XXXX	SHEET NO. 12

POLE FOUNDATION SCHEDULE FORCES (1.) **DRILLED PIER** POLE CONCRETE DESIGNATION MOMENT (M) SHEAR (V) VERTICAL (P) DIAMETER **EMBEDMENT BACKFILL** FT-LBS LBS INCHES DEPTH LBS YD^{3} (2.) 36 2.7 P4 237,311 4,646 5,723 20'-0" 30 174,522 3,733 3,801 18'-0" 1.6 P8 1.917 S5, S6 88,595 2,184 30 14'-0" 1.6

- ASD LOAD COMBINATION D + 0.6W. VERTICAL FORCE IS WEIGHT OF DRESSED POLE (DOES NOT INCLUDE PRECAST BASE WEIGHT).
- 2. MINIMUM CONCRETE BACKFILL VOLUME, SITE CONDITIONS MAY REQUIRE ADDITIONAL BACKFILL.

PRECAST BASE IDENTIFICATION								
PRECAST BASE IDENTIFICATION								
PRECAST BASE TYPE	PRECAST BASE WEIGHT	PRECAST BASE LENGTH	PROJECTION ABOVE GRADE	STANDARD EMBEDMENT	OUTSIDE DIAMETER			
4B	3,490 LBS	22'-0"	8'-0"	14'-0"	15.75"			
6B	6,930 LBS	26'-1"	8'-1"	18'-0"	20.56"			
7B	7B 10,160 LBS 27'-10" 7'-10" 20'-0" 23.75"							

POLE IDENTIFICATION						
POLE POLE PRECAST CONFIGURATION ACCESSOR (FIX. PER XARM) POLE PRECAST CONFIGURATION (FIX. PER XARM) POLE POLE PRECAST (FIXTURE ACCESSOR EPA (FT²)						
P4	LSS80D	7B	13 (7+6)	28.6		
P8	LSS70E	6B	12 (6+6)	28.8		
S5, S6 LSS70C 4B 4 (4) 7.6						

POLE FOUNDATION ELEV.

SCALE: NOT TO SCALE

LIGHT STRUCTURE ~

STEEL POLE BY

(SEE POLE ID)

DRILLED PIER EMBEDMENT DEPTH SEE POLE FOUNDATION SCHEDULE)

MUSCO LIGHTING

SOIL BACKFILL NOTE:

THE TOP TWO FEET OF ANNULUS SHALL BE BACKFILLED WITH SOIL, WITH A CLASSIFICATION OF CLASS 4 (TABLE 1806.2) OR BETTER. COMPACTION, 95% FOR COHESIVE SOIL AND 98% FOR A COHESIONLESS SOIL BASED UPON STANDARD PROCTOR TESTING (ASTM D698).

SOIL BACKFILL.

SEE NOTE BELOW

LIGHT STRUCTURE

PRECAST BASE BY

MUSCO LIGHTING (SEE POLE ID)

CONCRETE

~ UNDISTURBED

IN-SITU SOIL~

DRILLED PIER DIAMETER

(SEE POLE FNDTN. SCH.)

BACKFILL

DESIGN NOTES

DESIGN PARAMETERS:

GEOTECHNICAL PARAMETERS:

ALLOWABLE END BEARING SOIL PRESSURE: 2,000 PSF OR SKIN FRICTION: 367 PSF ALLOWABLE LATERAL SOIL BEARING PRESSURE:

150 PSF/FT (GRADE TO -2'-0"); 300 PSF/FT (BELOW -2'-0") IN ACCORDANCE WITH THE 2020 EDITION OF THE FLORIDA BUILDING CODE, CHAPTER 18. SEE TABLE 1806.2, SOIL MATERIAL CLASS 4 & SECTION 1806.3.4.

DESIGN SOIL PARAMETERS ARE AS NOTED. ACTUAL ALLOWABLE SOIL PARAMETERS MUST BE VERIFIED ON SITE.

A GEOTECHNICAL ENGINEER OR REPRESENTATIVE OF IS RECOMMENDED (NOT REQUIRED) TO BE AVAILABLE AT THE TIME OF THE FOUNDATION INSTALLATION TO VERIFY THE SOIL DESIGN PARAMETERS AND TO PROVIDE ASSISTANCE IF ANY PROBLEMS ARISE IN FOUNDATION INSTALLATION.

ENCOUNTERING SOIL FORMATIONS THAT WILL REQUIRE SPECIAL DESIGN CONSIDERATIONS OR EXCAVATION PROCEDURES MAY OCCUR. POLE FOUNDATIONS WILL NEED TO BE ANALYZED ACCORDING TO THE SOIL CONDITIONS THAT EXIST. IF ANY DISCREPANCIES OR INCONSISTENCIES ARISE, NOTIFY THE ENGINEER OF SUCH DISCREPANCIES. FOUNDATIONS WILL THEN BE REVISED ACCORDINGLY. REVISIONS WILL BE ANALYZED PER RECOMMENDATIONS DIRECTED BY A REGISTERED ENGINEER.

ALL EXCAVATIONS MUST BE FREE OF LOOSE SOIL AND DEBRIS PRIOR TO FOUNDATION INSTALLATION AND CONCRETE BACKFILL PLACEMENT. TEMPORARY CASINGS OR DRILLERS SLURRY MAY BE USED TO STABILIZE THE EXCAVATION DURING INSTALLATION. CASINGS MUST BE REMOVED DURING CONCRETE BACKFILL PLACEMENT. CONCRETE BACKFILL MUST BE PLACED WITH A TREMIE WHEN SLURRY OR WATER IS PRESENT WITHIN THE EXCAVATION OR WHEN THE FREE DROP EXCEEDS 6'-0".


CONTRACTOR MUST BE FAMILIAR WITH THE COMPLETE SOIL INVESTIGATION REPORT AND BORINGS, AND CONTACT THE GEOTECHNICAL FIRM (IF NECESSARY) TO UNDERSTAND THE SOIL CONDITIONS AND THE POSSIBILITY OF GROUND WATER PUMPING AND EXCAVATION STABILIZATION OR BRACING DURING PRECAST BASE INSTALLATION AND PLACEMENT OF CONCRETE BACKFILL.

CONCRETE:

CONCRETE SHALL BE AIR-ENTRAINED AND HAVE A MINIMUM COMPRESSIVE DESIGN STRENGTH AT 28 DAYS OF 3,000 PSI. 3,000 PSI CONCRETE SPECIFIED FOR EARLY POLE ERECTION, ACTUAL REQUIRED MINIMUM ALLOWABLE CONCRETE STRENGTH IS 1,000 PSI. ALL PIERS AND CONCRETE BACKFILL MUST BEAR ON AND AGAINST FIRM UNDISTURBED SOIL.

SENERAL NOTES:

FIXTURES MUST BE LOCATED TO MAINTAIN 10'-0" MINIMUM HORIZONTAL CLEARANCE FROM ANY OBSTRUCTION. ENGINEER MUST BE NOTIFIED IF FOUNDATIONS ARE NEAR ANY RETAINING WALLS OR WITHIN / NEAR ANY SLOPES STEEPER THAN 3H: 1V. POLES, FIXTURES, PRECAST BASES, ELECTRICAL ITEMS AND INSTALLATION PER MUSCO LIGHTING.

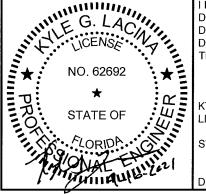

I HEREBY CERTIFY THAT THIS ENGINEERING DOCUMENT WAS PREPARED BY ME OR UNDER MY DIRECT PERSONAL SUPERVISION AND THAT I AM A DULY LICENSED PROFESSIONAL ENGINEER UNDER THE LAWS OF THE STATE OF FLORIDA.

KYLE G. LACINA - NO. PE 62692 LICENSE RENEWAL DATE: FEBRUARY 28, 2022

STRUCTURAL ENGINEERS, P.C. - NO. 26361

DRAWING NO. COVERED BY THIS SEAL: C1

COUNTRYSIDE
ATHLETIC COMPLEX
FIELD LIGHTING - PHASE
CLEARWATER, FL

ന

STRUCTURAL ENGINEERS, P.C

ENCE THE NICE DRAWING TITLE:
POLE AND FOUN
SCALE: SEE PLAN
NOTES:
SCAN #208806B

PROJECT NUMBER

DATE

16 APRIL 2021

DRAWING NUMBER

C1

USE OR REPRODUCTION OF THIS INFORMATION OTHER THAN ITS INTENDED PURPOSE FOR THIS PROJECT IS PROHIBITED WITHOUT WRITTEN CONSENT FROM MUSCO SPORTS LIGHTING, LLC.